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PROJECT:

JLTC- BUILDING #4

UTAH NATIONAL GUARD, JOINT LANGUAGE TRAINING CENTER

CAMP WILLIAMS, UTAH

CONSTRUCTION DOCUMENTS - MAY 18, 2006

DFCM PROJECT NO. 06013480



State of Utah-Department of Administrative Services

DIVISION OF FACILITIES CONSTRUCTION AND MANAGEMENT

4110 State Office Building/Salt Lake City, Utah 84114/538-3018

APPROVALS:

PRIME AGENCY

DATE

DFCM

DATE

APPROVAL DOES NOT RELIEVE A/E OF DESIGN LIABILITY

PROJECT TEAM

ARCHITECT

JSA ARCHITECTS, LLC

6465 SOUTH 3000 EAST SUITE #205 SALT LAKE CITY, UTAH 84121 (801) 133-2500 FAX (801) 133-2501 CONTACT: CHRISTOPHER JENSEN, AIA

STRUCTURAL ENGINEEER

DEMITA ENGINEERING

1474 E. EDGECLIFF DR. SANDY, UTAH 84092 PHONE: (801) 571-6332 FAX: (801) 571-6339 CONTACT: TONY DEMITA P.E.

ELECTRICAL ENGINEER

ECE CONSULTING ENGINEERS

939 SO. WEST TEMPLE SALT LAKE CITY, UTAH 84101 PHONE: (801) 521-8007 FAX: (801) 521-8057 CONTACT: DARRIN SANDERS P.E.

MECHANICAL ENGINEER

PVE INC.

90 SO. 400 WE. SUITE 340 SALT LAKE CITY, UTAH 84101 PHONE: (801) 359-3158 FAX: (801) 521-4114 CONTACT: ALAN SPENDLOVE P.E.

PROJECT INFORMATION

GOVERNING CODE: 2003 INTERNATIONAL BUILDING CODE (I,B,C,)

OCCUPANCY GROUP: B
BUILDING TYPE: VB
MAIN FLOOR SQUARE FOOTAGE: 5,461 SQ. FT.
BASEMENT: 3,555 SQ. FT.
OVER ALL SQUARE FOOTAGE: 9,022 SQ. FT.
SEISMIC ZONE: SEE SHEET S-001
SEE G-002 FOR ADDITIONAL INFORMATION

CIVIL ENGINEER

TWIN PEAKS

1880 NO, 800 EA,

LEHİ, UTAH 84043

PHONE: (801) 450-3511

CONTACT: SCOTT CARLSEN P.E.

APPROVALS:

PRIME AGENCY


DATE

DFCM

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VICINITY MAP

SCALE: = 1'-0"

G001

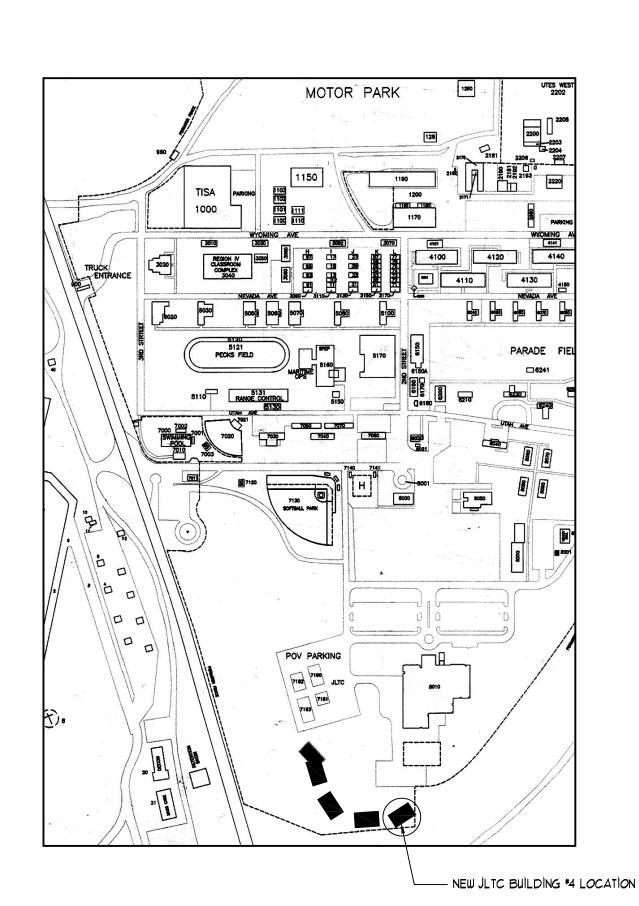planning interiors

6465 s. 3000 e. suite 205 salt lake city utah 84121 801.733.2500 fax 801.733.2501

CREATED BY: JSA ARCHITECTS

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CONSULTANTS:

BUILDING NAME:

UTAH NATIONAL GUARD

PROJECT TITLE:

BUILDING #4

CAMP WILLIAMS DRAPER, UT

MARK DATE DESCRIPTION

	ISSUE TYPE: CONSTRUCTION				
Ī	ISSUE DATE: 5/18/06				

DFCM PROJECT NO: 06013480

CAD PROJECT NO: 06013480
CAD PROJECT NO: 0625
CAD DWG FILE:
DRAWN BY: MLJ

CHK'D BY: CJ COPYRIGHT: STATE OF UTAH

SHEET TITLE

COVER

SHEET

SHEET NUMBER


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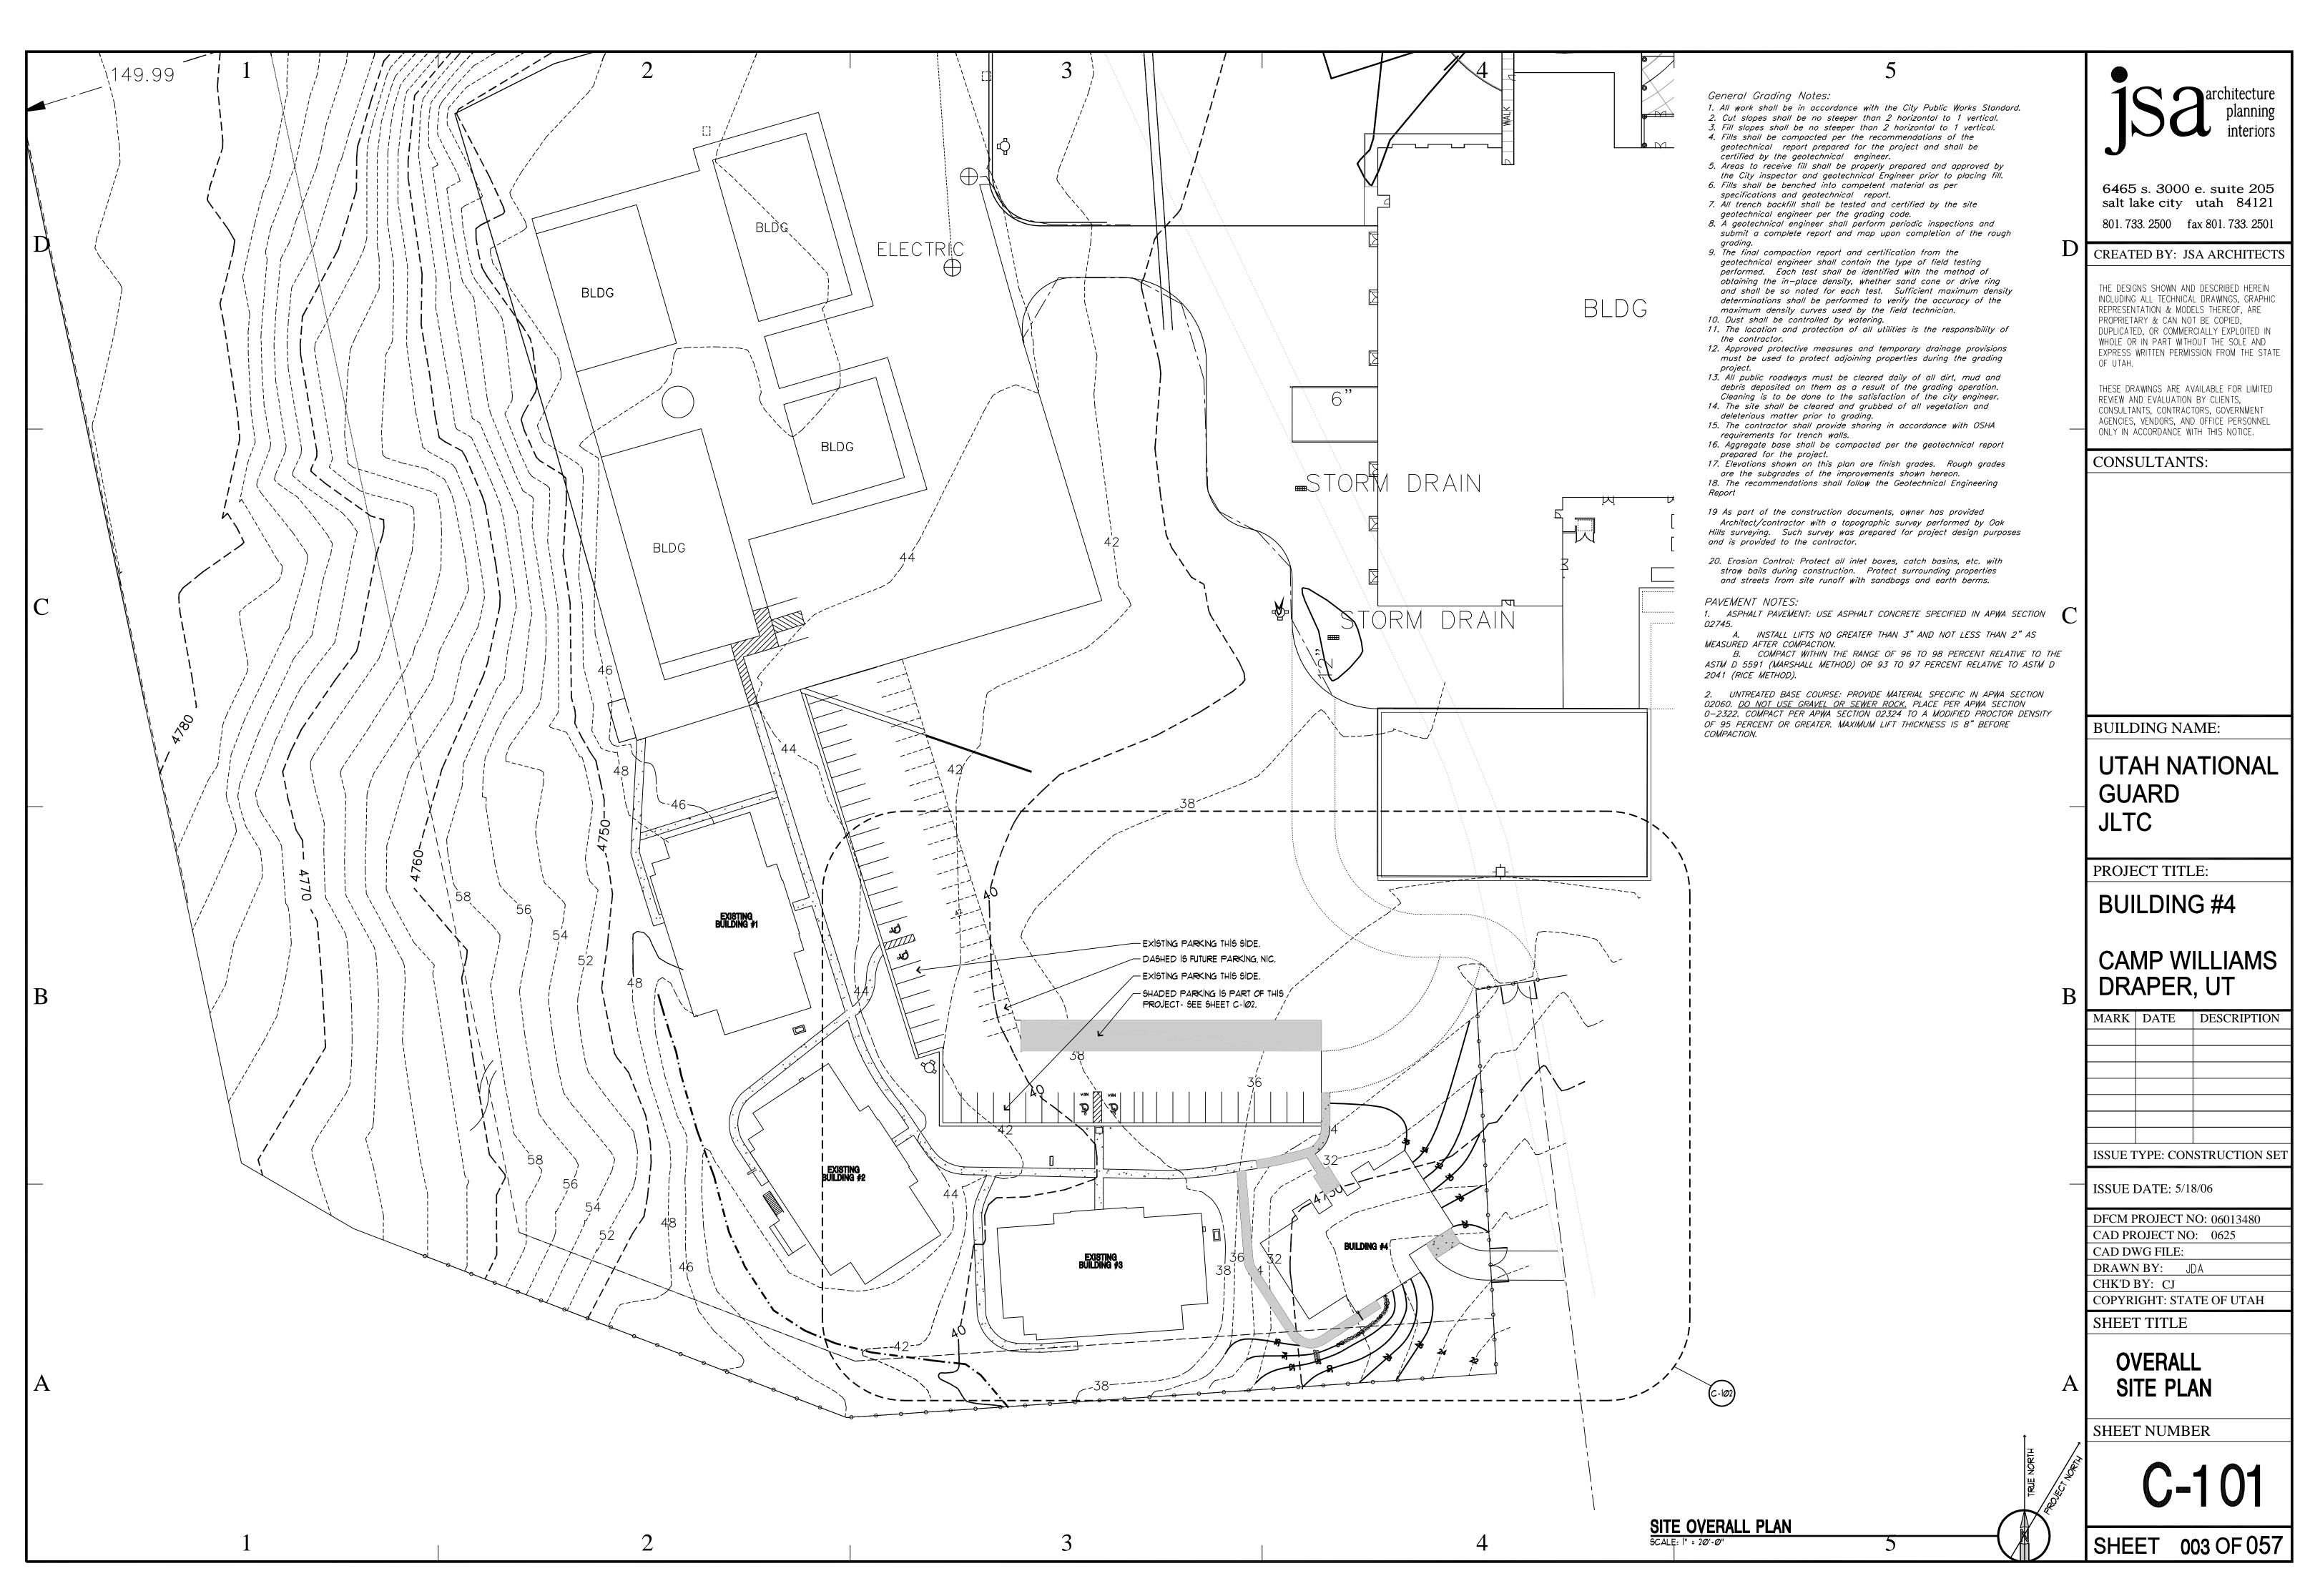
SHEET 001 OF 057




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<u>EXISTING UTILITIES</u> <u>GENERAL</u> ALL ELECTRICAL CONDUITS/LINES TO BE PVC SCH 40 OR BETTER REFER TO THE SITE ELECTRICAL PLAN FOR DETAILS AND LOCATIONS OF 30. THE CONTRACTOR SHALL BE RESPONSIBLE FOR ALL UTILITY S SHOWN 24, WATERLINES TO BE PVC C-900 PIPE. (MECHANICAL JOINTS . ALL MATERIALS AND CONSTRUCTION SHALL BE IN OR NOT SHOWN. THE EXISTENCE, LOCATION, AND CHARACTERISTICS OF 44. ALL CONSTRUCTION WORK IN UDOT RIGHT-OF-WAY SHALL 11. CONTRACTOR TO SPACE UTILITIES TO PROVIDE MINIMUM 37. UNSUITABLE MATERIAL, SUCH AS TOP SOIL, WEATHERED BED ROCK, ELECTRICAL LINES, TRANSFORMERS AND LIGHT POLES. REQUIRED WHEN LESS THAN 18" VERTICAL OR TEN FEET HORIZONTAL ALL UNDERGROUND UTILITIES AND STRUCTURES SHOWN ON THESE PLANS BE SUBJECT TO INSPECTION BY THE STATE. IT SHALL BE THE architecture architecture ACCORDANCE WITH DFCM STANDARDS. DISTANCES AS REQUIRED BY LOCAL, COUNTY, STATE, ETC., SHALL BE REMOVED AS REQUIRED BY THE SOILS ENGINEER HAVE BEEN OBTAINED FROM A REVIEW OF AVAILABLE RECORD DATA. NO SEPARATION FROM SEWERLINE). RESPONSIBILITY OF THE CONTRACTOR TO INSURE THAT AND INDIVIDUAL UTILITY CODES. 17. ALL GAS LINES TO BE HDPE WITH COPPER TRACER WIRE AND (AND/OR ENGINEERING GEOLOGIST, WHERE EMPLOYED) FROM ALL AREAS 2. CONTRACTOR AND APPLICABLE SUBCONTRACTORS SHALL ATTEND ALL REPRESENTATION IS MADE AS TO THE ACCURACY OR COMPLETENESS OF INSPECTIONS TAKE PLACE WHERE AND WHEN REQUIRED AND TO TO RECEIVE COMPACTED FILL OR DRAINAGE STRUCTURES. DETECTA TAPE. TERMINATE TRACER WIRE AT APPROVED LOCATIONS. 25. ALL WATERLINES SHALL BE 8" MINIMUM SIZE AND SERVICE PRE CONSTRUCTION CONFERENCES AND PERIODIC PROGRESS MEETINGS. 12. ALL UTILITIES ARE TO BE INSTALLED IN ACCORDANCE WITH SAID UTILITY INFORMATION. THE CONTRACTOR SHALL TAKE DUE INSURE THAT ALL WORK IS COMPLETED TO UDOT STANDARDS. MANUFACTURERS RECOMMENDATION AND THESE DISTRICT STANDARDS. 18. ALL GAS LINE TAPS, VALVES AND CAPS TO BE FUSED USING ELECTRO-FUSION TECHNOLOGY. LATERALS SHALL BE 1" MINIMUM UNLESS OTHERWISE NOTED. WATER PRECAUTIONARY MEASURES TO PROTECT THE FACILITIES SHOWN AND ANY 38. NO TREES SHALL BE REMOVED OR DAMAGED WITHOUT SPECIFIC 45, FILLS IN EXCESS OF 4 FEET IN THICKNESS AND BENEATH 3. CONTRACTOR SHALL BE RESPONSIBLE FOR ALL PUBLIC SAFETY AND LINES, VALVES, FIRE HYDRANTS, FITTINGS ETC. ARE TO BE OTHER FACILITIES NOT OF RECORD OR NOT SHOWN ON THESE PLANS, WRITTEN AUTHORIZATION FROM PROPERTY OWNER. ALL FOUNDATIONS OR PAVEMENT SECTIONS SHALL BE COMPACTED TO 95 PERCENT OF THE MAXIMUM DRY DENSITY AS DETERMINED BY THE ASTM D-1557 COMP ACTION CRITERIA. ALL OTHER STRUCTURAL FILL LESS THAN 4 FEET IN THICKNESS WATER-CAMP WILLIAMS CONSTRUCTED AS SHOWN. CONTRACTOR IS RESPONSIBLE TO CONSTRUCT ANY VERTICAL ADJUSTMENTS NECESSARY TO CLEAR SEWER, 19. ALL PHONE AND TV CONDUITS TO BE PVC SCH 40 OR BETTER. 31. CONTRACTOR SHALL CALL BLUE STAKES, OR OTHER AGENCY SEWER-SEWER DISTRICT 39. CONTRACTOR SHALL INSTALL EROSION CONTROLS (SILT FENCES, RESPONSIBLE FOR LINE LOCATIONS TWO WORKING DAYS PRIOR TO DIGGING. STRAW BALES, ETC) AS REQUIRED BY REGULATORY AGENCIES. SAID 4. THE CONTRACTOR SHALL FAMILIARIZE HIM/HER SELF WITH THE PLANS, STORM DRAIN OR OTHER UTILITIES AS NECESSARY INCLUDING RAISED TELEPHONE LINES, AND CABLE TV LINES ARE NOT SHOWN AS PART OF STORM DRAIN/GROUNDWATER-CAMP WILLIAMS VALVE BOXES AND HYDRANT SPOOLS TO PROPER GRADE. FOR PIPE THE GEOLOGY REPORTS AND THE SITE CONDITIONS PRIOR TO COMMENCING THESE PLANS. SEE CORRESPONDING DRAWINGS FOR SPECIFIC DETAILS. CONTROLS SHALL BE INSTALLED IN ACCORDANCE WITH AGENCY STANDARDS SHOULD BE COMPACTED TO AT LEAST 90 PERCENT OF THE SIZES 3/4" TO 2" DIAMETER PIPE - COPPER TUBE ASTM B, TYPE K , 32. PRIOR TO COMMENCING CONSTRUCTION, THE CONTRACTOR SHALL 20. NO GROUNDWATER OR DEBRIS TO BE ALLOWED TO ENTER THE NEW AND FOLLOWING BEST MANAGEMENT PRACTICES FOR ACTUAL PLACEMENT ELECTRICAL- UTAH POWER ABOVE CRITERIA. ADDITIONAL COMPACTION MAY BE REQUIRED ON SITE. EROSION CONTROLS SHOWN ON THESE DRAWINGS ARE INTENDED SOFT TEMPER FOR PIPES OVER 2" DIAMETER PIPE - AWWA C-900 UNCOVER AND VERIFY THE LOCATION AND ELEVATION OF ALL EXISTING PIPE DURING CONSTRUCTION. THE OPEN END OF ALL PIPE TO BE 5. ALL WORK SHALL COMPLY WITH THE AMERICAN PUBLIC WORKS 6465 s. 3000 e. suite 205 BY THE GEOTECHNICAL OR STRUCTURAL ENGINEER. AS A MINIMUM REQUIREMENT. ADDITIONAL CONTROLS REQUESTED BY TELEPHONE- QWEST UTILITIES TO BE JOINED, CROSSED, OR PARALLELED. ANY CONFLICT OR COVERED AND EFFECTIVELY SEALED AT THE END OF EACH DAYS WORK. ASSOCIATION UTAH CHAPTER (APWA) MANUAL OF STANDARD SPECIFICATIONS DISCREPANCY SHALL BE BROUGHT TO THE ATTENTION OF THE ENGINEER AGENCY INSPECTORS SHALL BE REQUIRED. salt lake city utah 84121 GAS- QUESTAR 46. COMPACTION TESTING SHALL BE ACCOMPLISHED BY THE 2002 EDITION AND THE MANUAL OF STANDARD PLANS 2002 EDITION. 26. WATER SERVICE LATERALS TO INCLUDE ALL BRASS SADDLE; CORP. PRIOR TO CONSTRUCTION. OTHERWISE, CONTRACTOR ASSUMES SOLE AND CONTRACTOR, OR THE CONTRACTOR WILL HAVE SUCH TESTING SAID STANDARD SPECIFICATIONS AND PLANS SHALL BE SUBSIDIARY TO 13, COORDINATE ALL SERVICE LATERAL AND BUILDING CONNECTIONS WITH COMPLETE RESPONSIBILITY FOR ANY COSTS OF REPLACEMENT, RELOCATION, 40, ALL RECOMMENDATIONS MADE BY THE SOILS ENGINEER CONTAINED IN STOP LATERAL. DOUBLE CHECK VALVE AND BACKFLOW PREVENTION ACCOMPLISHED BY A SEPARATE CONTRACTOR. TEST RESULTS MORE STRINGENT REQUIREMENTS BY APPLICABLE LOCAL JURISDICTION. CORRESPONDING ARCHITECTURAL, MECHANICAL OR ELECTRICAL DRAWING DEVICE, WATER METERS ARE TO BE INSTALLED PER CITY STANDARDS THE GEOTECHNICAL INVESTIGATION CONSULTANTS INC. SHALL BE REQUIRED 801. 733. 2500 fax 801. 733. 2501 OR ADDITIONAL COSTS OF CONSTRUCTION. WILL BE SUBMITTED FOR REVIEW WITHIN 24 HOURS AFTER TEST FOR LOCATION AND ELEVATION. NOTIFY ENGINEER IMMEDIATELY IF ANY AND SPECIFICATIONS IT WILL BE THE CONTRACTOR'S RESPONSIBILITY TO AS PART OF THESE CONSTRUCTION PLANS. CONTRACTOR SHALL SUBMIT A TRAFFIC CONTROL PLAN IN ONFORMANCE WITH THE MUTCD AND IN COMPLIANCE WITH STANDARD DISCREPANCIES ARE ENCOUNTERED 47. CONTRACTOR TO SUBMIT PROCTOR AND/OR MARSHALL TS INSTALL ALL ITEMS REQUIRED. ALL SEWER LINE TO BE FLUSHED, PRESSURE TESTED 33. ALL UTILITY MANHOLE RIMS, CATCH BASIN GRATES AND VALVE BOX 41. ALL DEBRIS AND FOREIGN MATERIAL SHALL BE REMOVED FROM THE 14. ALL STORM DRAIN MANHOLES AND CATCH BASINS ARE TO BE PRE TO 5 PSI VIDEO INSPECTED AND OTHERWISE TESTED IN ACCORDANCE WITH COVERS ARE TO BE ADJUSTED TO FIT THE FINISHED GRADE OF THE SITE DATA 24 HOURS PRIOR TO TEST. CREATED BY: JSA ARCHITECTS SITE AND DISPOSED OF AT APPROVED DISPOSAL SITES. THE CONTRACTOR SHALL OBTAIN NECESSARY PERMITS FOR THE TRANSPORTATION OF SPECIFICATION 01555 "TRAFFIC CONTROL" CAST CONCRETE FROM APPROVED LOCAL MANUFACTURER UNLESS 27, ALL WATERLINES SHALL BE MINIMUM 48" BELOW FINISH GROUND DISTRICT STANDARDS PRIOR TO PLACING IN SERVICE. AND INCLUDE CONC. COLLAR IN PAVED AREAS. OTHERWISE NOTED. BOTTOM OF BOX TO BE FREE DRAINING. TO TOP OF PIPE. ALL VALVE BOXES AND MANHOLES SHALL BE RAISED 48. STRAIGHT GRADE SHALL BE MAINTAINED BETWEEN CONTOUR 7. SHOULD CONFLICTING INFORMATION BE FOUND ON THE PLANS, THE MATERIAL TO AND FROM THE SITE. ALL CATCH BASIN AND INLET BOX GRATES ARE TO BE BICYCLE OR LOWERED TO FINISH GRADE. (6" ABOVE GRADE IN UNPAYED AREAS 22. ALL SEWER LINES AND LATERALS ARE TO BE SDR 35 PVC PIPE. LINES AND SPOT ELEVATIONS UNLESS OTHERWISE SHOWN ON CONTRACTOR SHALL NOTIFY THE PROJECT ENGINEER BEFORE WITH SOIL SLOPED UP TO RIM) AND SHALL INCLUDE A CONCRETE 34. ALL PROPOSED ELEVATIONS SHOWN ON THE GRADING PLAN ARE TO PROCEEDING WITH THE WORK IN QUESTION. 42. THE CONTRACTOR SHALL ASSUME SOLE AND COMPLETE THE DESIGNS SHOWN AND DESCRIBED HEREIN 23. SEWER MANHOLES, LATERALS AND CLEANOUTS TO BE INSTALLED PER 15. ALL STORM WATER CONVEYANCE PIPING FINISHED SURFACE, THE CONTRACTOR IS RESPONSIBLE TO DEDUCT THE THICKNESS OF THE PAVEMENT STRUCTURAL SECTION FOR TOP OF SUB RESPONSIBILITY FOR THE JOB SITE CONDITIONS, INCLUDING SAFETY OF ALL INCLUDING ALL TECHNICAL DRAWINGS, GRAPHIC 10" PIPES OR SMALLER — POLYVINYL CHLORIDE (PVC) SEWER PIPE, IMPROVEMENT DISTRICT STANDARDS. MANHOLES TO STAMPED WITH THE 49. ALL SLOPES ADJOINING STREETS, DRAINAGE CHANNELS, OR 8. CONTRACTOR TO NOTIFY SURVEYOR 72 HOURS PRIOR TO NEED FOR ANY DISTRICT NAME AS REQUIRED. PERSONS AND PROPERTY. DURING THE COURSE OF CONSTRUCTION OF ASTM D3034 TYPE PSM. 28. CONTRACTOR TO NOTIFY ENGINEER FOR CHLORINE TEST PRIOR TO REPRESENTATION & MODELS THEREOF, ARE GRADE ELEVATIONS. OTHER FACILITIES SHALL BE GRADED NO STEEPER THAN 2 (H) THIS PROJECT. THIS REQUIREMENT SHALL APPLY CONTINUOUSLY, AND CONSTRUCTION STAKING. 12" PIPES OR LARGER - REINFORCED CONCRETE PIPE, FLUSHING LINES, CHLORINE LEFT IN PIPE 24 HRS. MINIMUM WITH 25 TO 1 (V) FOR CUT AND FILL. SHALL NOT BE LIMITED TO NORMAL WORKING HOURS. THE CONTRACTOR PROPRIETARY & CAN NOT BE COPIED. PPM RESIDUAL. ALL TURNING OF MAINLINE VALVES, CHLORINATION, ASTM C76, CLASS III 35. IF AT ANY TIME DURING CONSTRUCTION ANY UNFAVORABLE GEOLOGICAL 9. IT SHALL BE THE RESPONSIBILITY OF THE CONTRACTOR TO ASSURE SHALL DEFEND, INDEMNIFY AND HOLD THE OWNER AND THE ENGINEER FIELD VERIFY ALL EXISTING AND /OR PROPOSED ROOF DRAIN/ROOF DRAIN FLUSHING, PRESSURE TESTING, BACTERIA TESTING, ETC. TO BE DUPLICATED, OR COMMERCIALLY EXPLOITED IN CONDITIONS ARE ENCOUNTERED, WORK IN THAT AREA WILL STOP UNTIL 50. UNLESS OTHERWISE SPECIFICALLY CALLED OUT, NO EARTH THAT ALL PIPES, WALLS, ETC. ARE ADEQUATELY BRACED DURING HARMLESS FROM ANY AND ALL LIABILITY, REAL OR ALLEGED, IN DOWN SPOUT CONNECTIONS TO STORM WATER SYSTEM WITH CIVIL, PLUMBING COORDINATED WITH WATER DEPARTMENT. ALL TESTS TO BE IN APPROVED CORRECTIVE MEASURES ARE OBTAINED FROM THE ENGINEER. WHOLE OR IN PART WITHOUT THE SOLE AND SLOPES SHALL EXCEED FOUR FEET IN HEIGHT WITHOUT CONNECTION WITH PERFORMANCE OF WORK ON THIS PROJECT. CONSTRUCTION. & ARCHITECTURAL PLANS. NOTIFY ENGINEER OF ANY DISCREPANCIES. ACCORDANCE WITH AWWA STANDARDS. RETAINING WALLS. NO RETAINING WALLS SHALL EXCEED SIX EXPRESS WRITTEN PERMISSION FROM THE STATE 36. ALL DELETERIOUS MATERIAL, SUCH AS LUMBER, LOGS, BRUSH, 10, ALL WORK SHALL CONFORM TO THE PLANS AND SPECIFICATIONS IN FEET WITHOUT TERRACING. NO TERRACED WALLS SHALL EXCEED 43, NATURAL GROUND MAY HAVE BEEN MODIFIED SINCE THESE PLANS 29. BOTTOM FLANGE OF FIRE HYDRANTS TO BE SET TO OF UTAH. OR ANY OTHER ORGANIC MATERIALS OR RUBBISH, SHALL BE REMOVED TWELVE FEET IN TOTAL HEIGHT. ALL RESPECTS AND SHALL BE SUBJECT TO APPROVAL BY THE ENGINEER. WERE PRODUCED. APPROXIMATELY 4 INCHES ABOVE BACK OF CURB ELEVATION. FROM ALL AREAS TO RECEIVE COMPACTED FILL. THESE DRAWINGS ARE AVAILABLE FOR LIMITED REVIEW AND EVALUATION BY CLIENTS, CONSULTANTS, CONTRACTORS, GOVERNMENT AGENCIES, VENDORS, AND OFFICE PERSONNEL ONLY IN ACCORDANCE WITH THIS NOTICE. - CONTRACTOR TO LOCATE **CONSULTANTS:** AND CONNECT TO EXISTING BUILDING ELEVATIONS / WATERLINE, EXG. COMMUNICATION LINE | Finished/Floor Elevations 4746.0 EXISTING BUILDING #1 4745.0 | Finished Floor Flevations ``4740.0 Finished Floor Exevations // EXG. 4" SANITARY SEWER *4738.0* Finished Floor Elevations CONTRACTOR TO LOCATE AND CONNECT TO EXISTING GAS LÍNE. **BUILDING NAME:** S **UTAH NATIONAL** SERVICE LATERAL. **GUARD** - EXISTING FIRE NYDRANT CONTRACTOR TO VERIFY FL FLOW OF — INSTALL GAS SERVICE LATERAL. EXISTING MH, (N) 8" PVC PROJECT TITLE: **BUILDING #4** - NEW GAS METER CAMP WILLIAMS (N) 8"/PVC DRAPER, UT EXISTING SWITCH/JUNCTION BOX **EXISTING** MARK DATE DESCRIPTION BUILDING #2 - INSTALL 4" SEWER LATERAL MIN. 2% SLOPE. DCO © 4735-Ø EXISTING-ISSUE TYPE: CONSTRUCTION SE TRANSFORMER EXISTING BUILDING #3 **ISSUE DATE: 5/18/06 BUILDING #4** DFCM PROJECT NO: 06013480 NEW ELECTRICAL CAD PROJECT NO: 0625 CAD DWG FILE: DRAWN BY: JDA CHK'D BY: CJ COPYRIGHT: STATE OF UTAH SHEET TITLE CIVIL **UTILITY PLAN** SHEET NUMBER EXISTING FENCE LINE CIVIL UTILITY SITE PLAN 005 OF 057 SHEET

DESIGN CRITERIA 1. GOVERNING BUILDING CODE: 2003 IBC 2. GRAVITY LOADING A, ROOF DEAD LOAD 20 PSF B, ROOF SNOW LOAD: Pg = 46 PSF, Pf = 34 PSF + DRIFT Ce = 1,0, | = 1,0, Ct = 1,0 A, FLOOR DEAD LOAD 50 PSF B. FLOOR LIVE LOAD: 100 PSF 3. SEISMIC DESIGN A, SEISMIC CATEGORY E, SIESMIC USE GROUP I, Sas = .811, Sal = .466, SITE CLASS D, BEARING WALL SYSTEM: K, DESIGN BASE SHEAR = 40.4 K, EQUIVALENT LATERAL FORCE PROCEDURE USED. 4. WIND DESIGN A, BASIC WIND SPEED V35 = 90 MPH, I = 1,0, EXP C, INTERNAL PRESSURE COEFFICIENT GCpi = +,18, -,18 COMPONENTS AND CLADDING: ROOF -18,73 PSF, WALLS -20,3 PSF 5, FOUNDATION A. ALLOWABLE SOIL BEARING PRESSURE IS 2500 PSF PER SOILS REPORT *2154JT161 BY WESTERN TEHNOLOGIES, B. SUBSURFACE CONDITIONS IF GROUND WATER IS ENCOUNTERED, NOTIFY ENGINEER BEFORE PROCEEDING FURTHER. GENERAL 1. ALL CONSTRUCTION SHALL BE IN CONFORMANCE WITH 2003 EDITION OF THE INTERNATIONAL BUILDING CODE AND SUPPLEMENTS UNLESS HIGHER STANDARD IS CALLED FOR. 2. THE CONTRACTOR SHALL VERIFY ALL DIMENSIONS AND CONDITIONS AT THE SITE, 3. THE CONTRACTOR SHALL BE RESPONSIBLE FOR SAFETY AND PROTECTION WITHIN AND ADJACENT TO THE JOB SITE. 4. DURING AND AFTER CONSTRUCTION THE CONTRACTOR AND/OR OWNER SHALL KEEP LOADS ON THE STRUCTURE WITHIN THE LIMITS OF THE DESIGN LOADS, 5. DO NOT SCALE THE DRAWINGS, IF DIMENSION ARE IN QUESTION, THE CONTRACTOR SHALL BE RESPONSIBLE FOR OBTAINING CLARIFICATION FROM THE ARCHITECT/ENGINEER BEFORE CONTINUING WITH CONSTRUCTION. 6. SHOP DRAWINGS SHALL BE SUBMITTED TO THE GENERAL CONTRACTOR AND ARCHITECT PRIOR TO FABRICATION OR ERECTION FOR THE FOLLOWING ITEMS: REINFORCING STEEL STRUCTURAL STEEL MISCELLANEOUS METALS (EMBEDDED CONNECTIONS, PLATES, ETC. THE GENERAL CONTRACTOR SHALL SUBMIT THREE(3) COPIES OF ALL SHOP DRAWINGS TO THE STRUCTURAL ENGINEER FOR REVIEW PRIOR TO FABRICATION OR ERECTION, FIVE (5) WORKING DAYS SHALL BE ALLOWED FOR THE REVIEW OF THESE SHOP DRAWINGS BY THE ENGINEER. 7. THE TYPICAL DETAILS SHALL BE USED WHEREVER APPLICABLE UNLESS OTHERWISE NOTED ON THE DRAWINGS, NOTES AND DETAILS ON DRAWINGS SHALL TAKE PRECEDENCE OVER THE GENERAL NOTES AND TYPICAL DETAILS, 8. ALL OMISSIONS OR CONFLICTS BETWEEN THE VARIOUS ELEMENTS OF THE WORKING DRAWINGS AND /OR SPECIFICATIONS SHALL BE BROUGHT TO THE ATTENTION OF THE ARCHITECT BEFORE PROCEEDING WITH ANY WORK INVOLVED. IN CASE OF CONFLICT, FOLLOW MOST STRINGENT REQUIREMENT AS DETERMINED BY ARCHITECT/ENGINEER WITHOUT COST TO OWNER.

EARTHWORK CONC

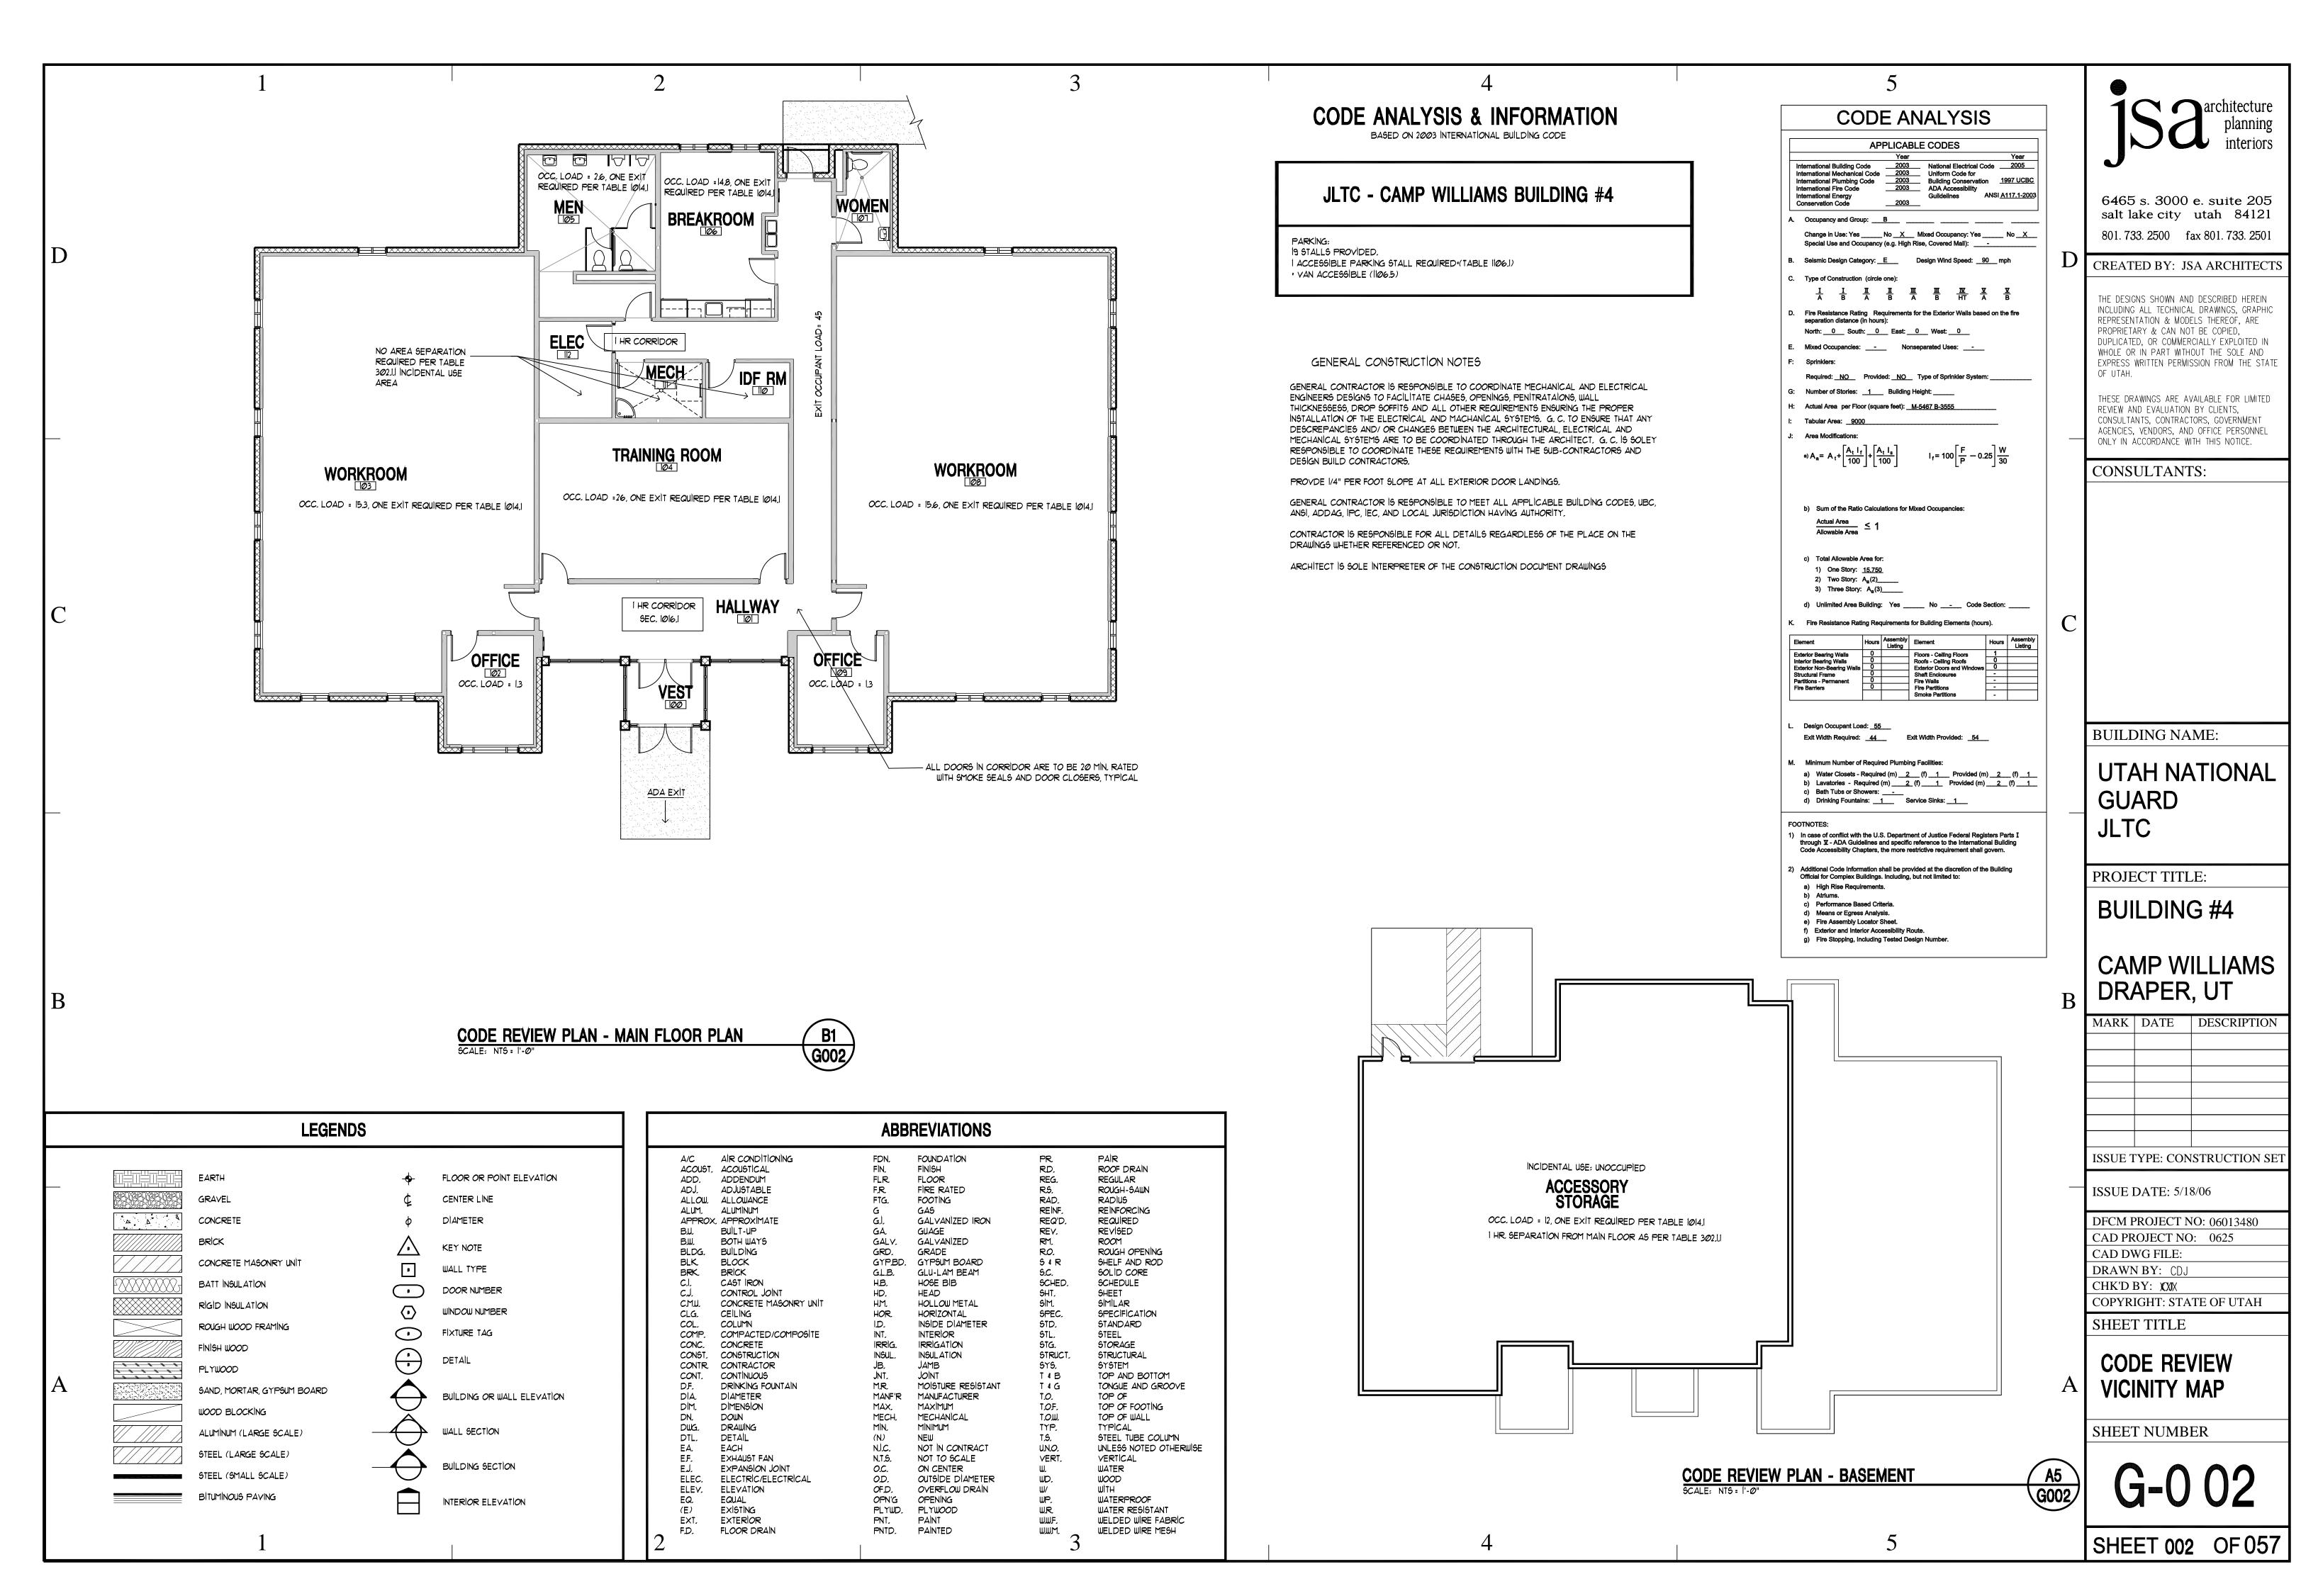L SITE PREPARATIONS

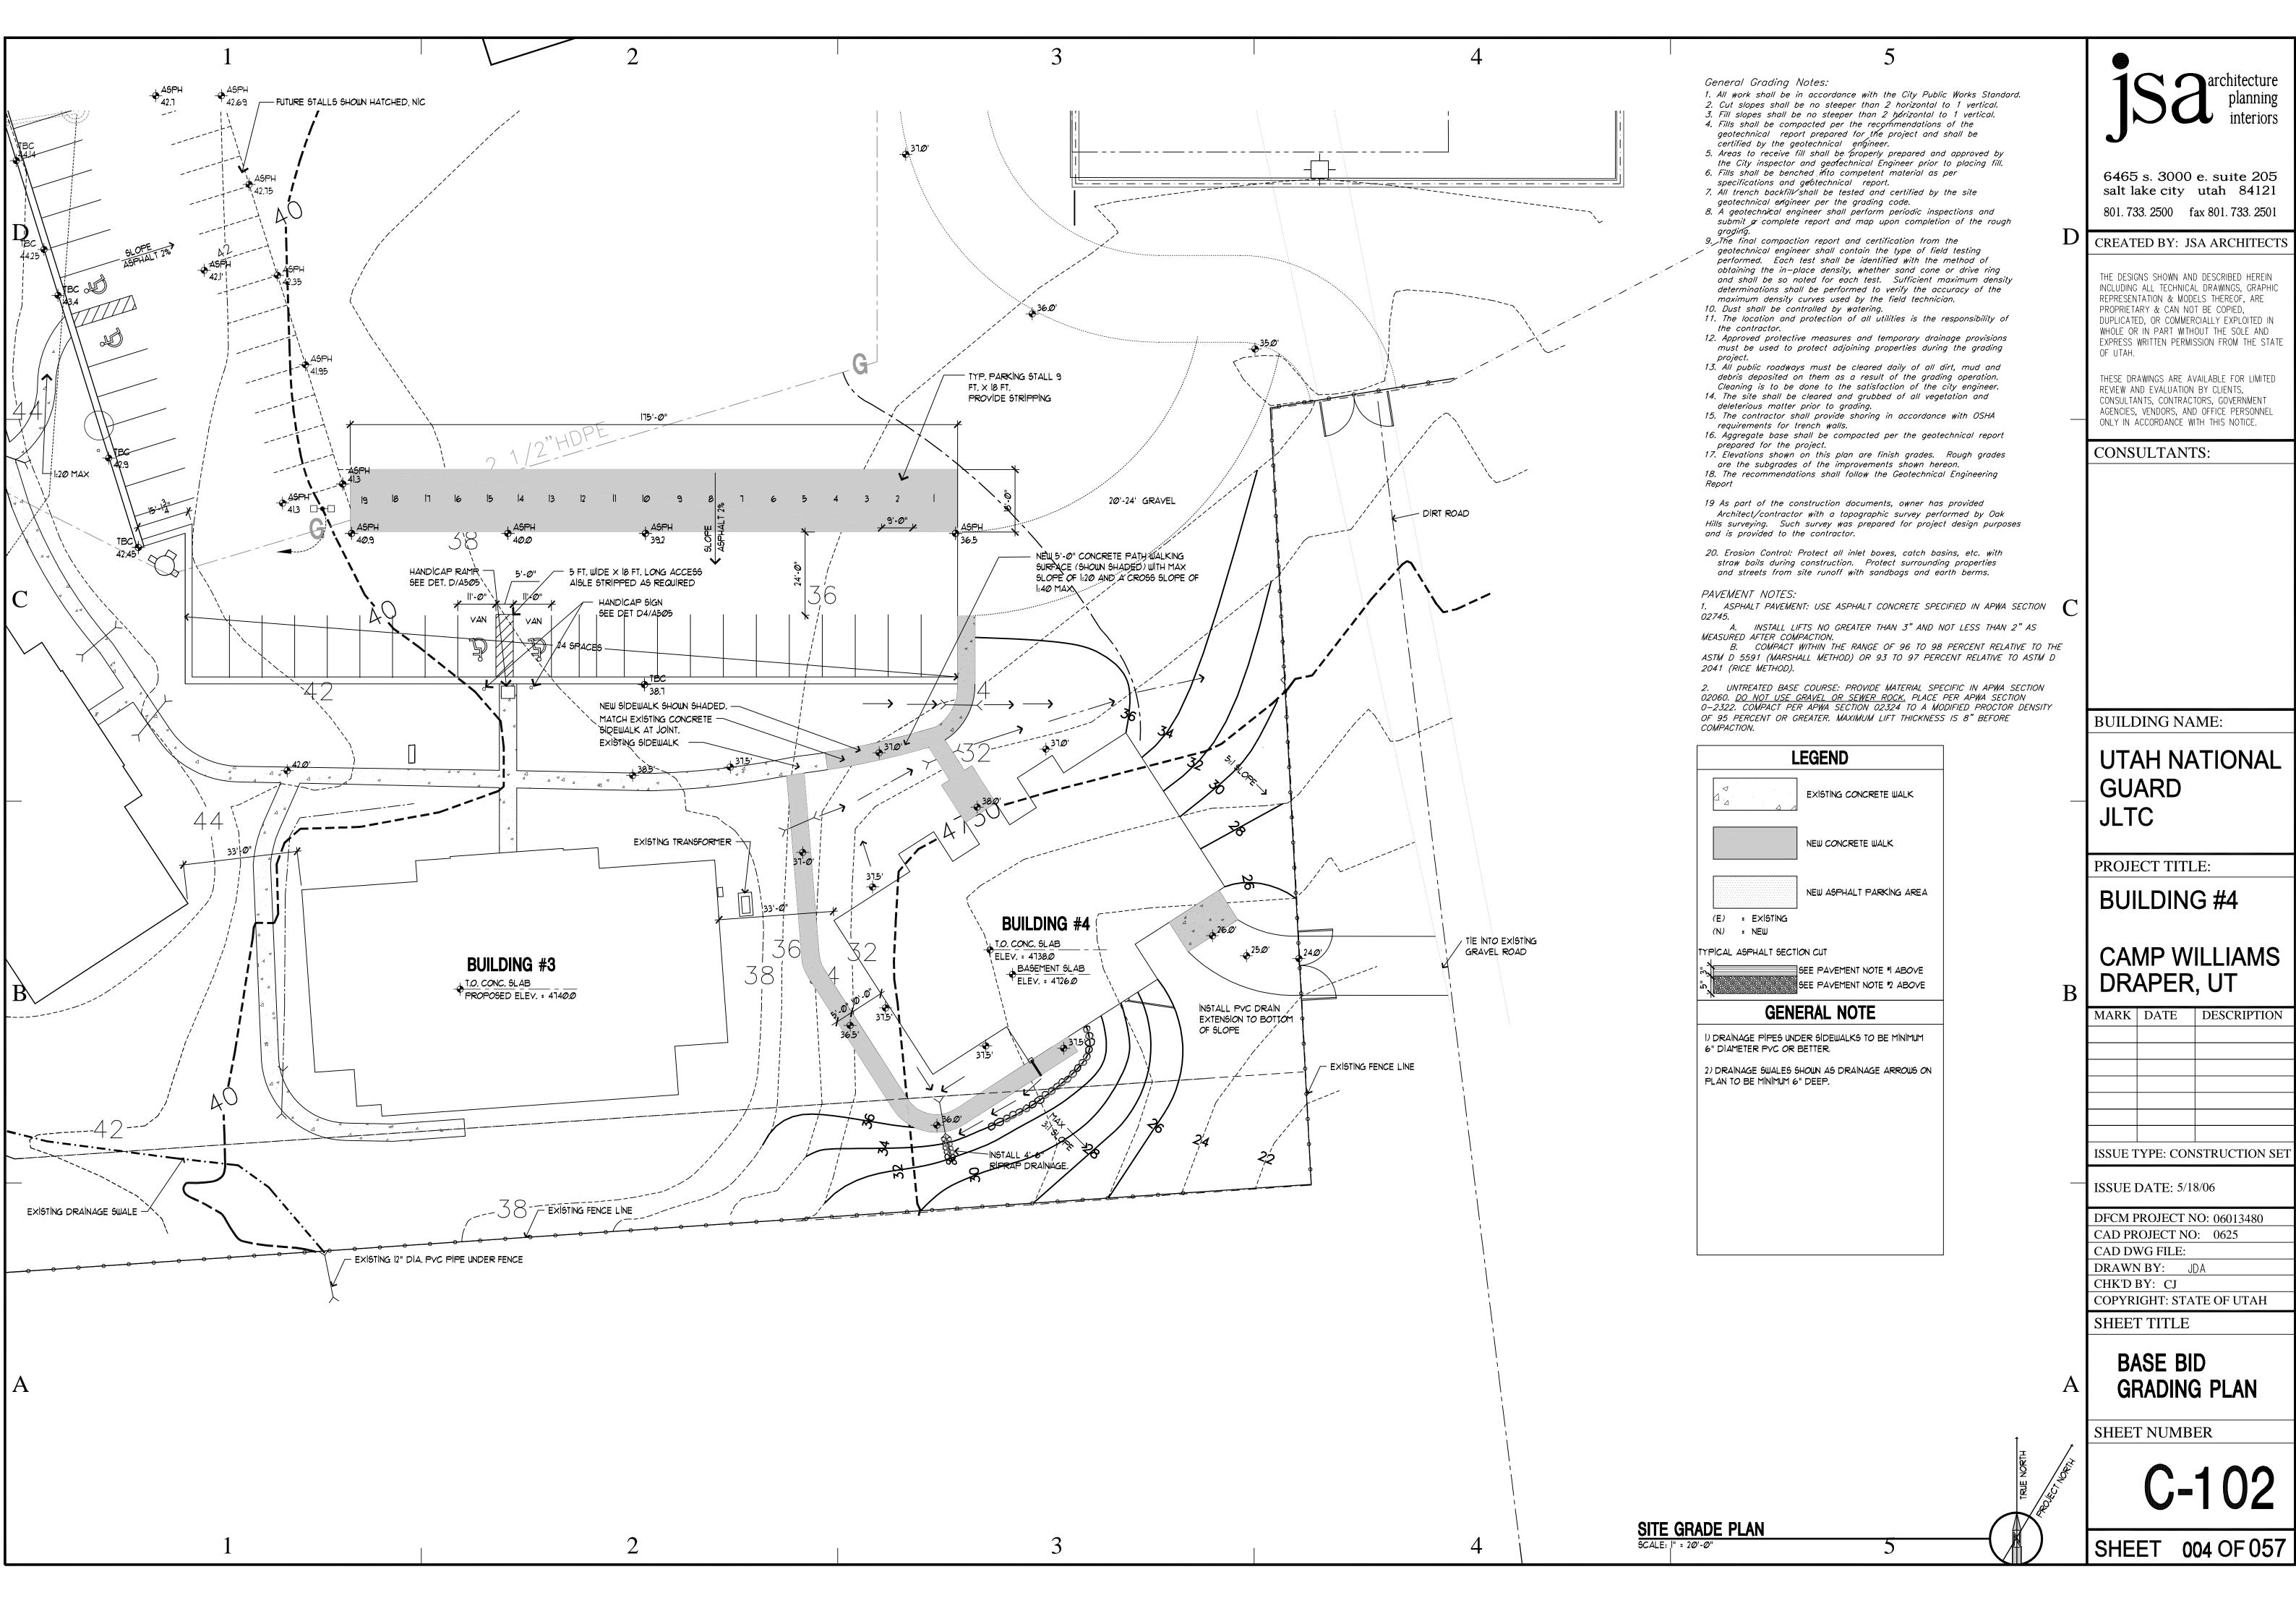REMOVE SUFACE VEGETATION AND OTHER SURFACE DELETERIOUS

MATERIALS FROM ALL AERAS WHICH WILL BE STRUCTURALLY LOADED

SUSSEQUENT FROM AN AREA EXTENDING FIVE FEET FROM THE PERIMETER

OF THE BUILDING ALL NON-ENGINEERED FILL MUST BE REMOVED,
SUBSEQUENT TO INITIAL STRIPPING AND OVER-EXCAVATION,
THE EXPOSED SUBGRADE MUST BE PROOFROLLED, IF ANY SOFT OR UNSUITABLE
SOIL ZONES ARE ENCOUNTERED, THE MUST BE REMOVED TO A MAXIMUM DEPTH OF

TWO FEET AND REPLACED WITH COMPACTED GRANULAR FILL.
ON-SITE GRANULAR NON-ENGINEERED FILLS MAY BE
RE-UTILIZED AS STRUCTURAL FILL.

AND UNUSUAL SOIL CONDITIONS (WATER, SOFT LAYERS, ROCK OUTCROPPINGS, ETC.) ENCOUNTERED DURING EXCAYATION FOR FOOTINGS SHOULD BE IMMEDIATELY BROUGHT TO THE ATTENTION OF THE ARCHITECT AND SOIL ENGINEER,

2. STRUCTURAL FILL

ALL FOOTINGS SHALL BEAR 30" MINIMUM ONTO SUITABLE
NATURAL SOILS AND/OR STRUCTURAL FILL EXTENDING TO
SUITABLE NATURAL SOILS, STRUCTURAL FILL SHALL BE COMPACTED TO 95% OF
MAXIMUM RELATIVE DENSITY BASED ON ASTM D 1551, SUCH
FILL SHALL BE PLACED IN LOOSE LAYERS NOT TO EXCEED EIGHT
INCHES (8") IN DEPTH,

ANY FILL TO BE PLACED UNDER THE BUILDING AND FOOTINGS SHALL BE A WELL GRADED GRANULAR MATERIAL WITHIN THE LIMITS OF THE FOLLOWING GRADATION:

SIEVE SIZE PERCENT PASSING

4"	100%
1"	60-90%
NO. 4	30-60%
NO. 40	10-30%
NO200	5-12%

WIDTH OF COMPACTED STRUCTURAL FILL SHALL EXTEND A MINIMUM DISTANCE EQUAL TO THE DEPTH OF FILL BEYOND THE EDGES OF THE FOOTINGS.

ALL FILL AND BACK FILL SHALL BE COMPACTED TO A MINIMUM OF 95% OF MAXIMUM RELATIVE DENSITY OF BUILDING CONSTRUCTION AND 90% FOR GENERAL SITE WORK.

- 3. ALL WATER SHALL BE REMOVED FROM FOUNDATION EXCAVATION PRIOR TO PLACING OF CONCRETE, DO NOT POUR CONCRETE UNDER WATER OR ON FROZEN GROUND.
- 4. COMPACTION TESTS SHALL BE PERFORMED BY AN INDEPENDENT TESTING LABORATORY AS SELECTED BY THE ARCHITECT/ENGINEER.
- 5. ALL EXCAVATIONS SHOULD BE OBSERVED PERIODICALLY BY A QUALIFIED GEOTECHNICAL PERSONNEL.

OPEN WEB STEEL JOISTS AND STEEL DECKS

I. ALL STEEL JOISTS AND GIRDERS, WITH THEIR ASSOCIATED HARDWARE, SHALL BE DESIGNED, FABRICATED & INSTALLED PER REQUIREMENTS OF THE STEEL JOIST INSTITUTE SPECIFICATION.

- 2. STEEL JOIST MANUFACTURER SHALL DESIGN AND FABRICATE STEEL JOIST AND GIRDERS TO SUPPORT LOADS SHOWN ON PLANS, COORDINATE DESIGN WITH ALL MECHANICAL EQUIPMENT AND SUSPENDED LOADS, ALL JOISTS AND GIRDERS WITH SLOPE EXCEEDING 1/2 INCHES PER FOOT SHALL BE DESIGNED FOR ADDITIONAL AXIAL STRESSES,
- 3. SUBMIT CALCULATIONS AND SHOP DRAWINGS FOR REVIEW PRIOR TO FABRICATION OF JOISTS AND GIRDERS, CONTRACTOR SHALL NOT CUT, DRILL, OMIT OR MODIFY ANY PART OF ANY JOIST OR GIRDER WITHOUT WRITTEN CONSENT AND DIRECTION FROM THE MANUFACTURER.
- 4. BOTTOM CHORD OF THE GIRDERS SHALL NOT BE WELDED TO THE STABILIZER PLATES UNLESS SPECIFICALLY CALLED FOR ON DETAILS, WHERE WELD IS SPECIFIED, WELD AFTER ALL DEAD LOAD HAS BEEN APPLIED, ALL WELDERS SHALL BE AWS CERTIFIED,
- 5. ROOF DECK SHALL BE 20 GA., I 1/2", TYP HS-B, PAINTED AND MANUFACTURED BY VERCO. PROVIDE 1/2" DIA, FUSION WELDS SIX PLACES PER SHEET TO ALL SUPPORTS AND AT 6" ON CENTER AT ALL EDGES, FRAMES, SHEAR WALLS AND DRAG STRUTS, PROVIDE I 1/2" TOP SEAM WELDS AT 24" O.C., FOR ALL PANEL TO PANEL CONNECTIONS.
- 6. SUBSTITUTION OR ROOF DECK SHALL BE APPROVED BY ARCHITECT AND ENGINEER. IT SHALL HAVE CAPACITY FOR GRAVITY AND SHEAR LOADS EQUAL TO OR BETTER THAN SPECIFIED STEEL DECKS AND SHALL BE

REINFORCING BARS

METAL REINFORCEMENT SHALL BE DEFORMED TYPE BARS AND SHALL CONFORM TO ASTM A-615 GRADE 60 WITH MINIMUM YIELD STRENGTH OF 60 KSI. ALL REINFORCEMENT BARS SHALL BE DETAILED, BOLSTERED AND SUPPORTED IN ACCORDANCE WITH ACI STANDARD 315 "MANUAL OF STANDARD PRACTICE FOR DETAILING REINFORCE CONCRETE STRUCTURES", CONCRETE REINFORCING STEEL INSTITUTE (CRSI) AND "BUILDING CODE REQUIREMENTS FOR REINFORCED CONCRETE" ACI 318. LAP REINFORCING BARS 48 BAR DIAMETERS IN CONCRETE.

CONCRETE

1. CONCRETE SHALL CONFORM TO ALL REQUIREMENTS OF ACI 318-02
"SPECIFICATIONS FOR STRUCTURAL CONCRETE FOR BUILDINGS",
EXCEPT AS MODIFIED BY THE SUPPLEMENTAL REQUIREMENTS
BELOW:

PROJECT STRUCTURAL NOTES

- 12 CEMENT NOTES:
 - A. FOOTINGS, FOUNDATION WALLS, PIERS, SUSPENDED SLAB,
 INTERIOR SLABS ON GRADE-TYPE 2 LOW ALKALI PER ASTM C150,
 MAX W/C = 0.50
 - B. EXTERIOR SLABS ON GRADE USE 6 1/2% + 1 1/2% AIR
 PER ASTM C260 WITH MAX. SIZE AGGREGATE 3/4" PER
 C33. MAX w/c=0.45.
- 1.3 CONCRETE SHALL ATTAIN THE FOLLOWING MINIMUM
- COMPRESSIVE STRENGTH AT 28 DAYS:

 A. FOOTINGS, FOUNDATION WALLS 3000 PSI.
- B. SLABS ON GRADE, SUSPENDED SLAB -4000 PSI
- 14 REINFORCING STEEL SHALL MEET ASTM A 615 GRADE 60
 (YIELD STRESS = 60,000 PSI)
- A STATEMENT OF MIX DESIGN FOR ALL CONCRETE SHALL BE SUBMITTED AND APPROVED BY THE ENGINEER TO COMMENCING WORK.
- 3. CURING AND PROTECTION OF CONCRETE SHALL CONFORM TO IBC SECTION 1905.11, 1905.12, 1905.13

THE USE OF CHEMICALS OR ADDITIVES TO PREVENT FREEZING SHOULD NOT BE PERMITTED, REFER TO SPECIFICATIONS AND TO DIRECTIVES BY STRUCTURAL ENGINEER FOR ADDITIONAL COLD WEATHER REQUIREMENTS.

ALL CONCRETE SHALL BE PROPERLY VIBRATED IN PLACE USING INTERNAL VIBRATING RODS (MECHANICAL OR ELECTRICAL.

- 4. ALL SLABS ON GRADE SHALL BE PLACED WITH CONSTRUCTION JOINTS OR SAW CUTS AT 10'-0" ON CENTER (MAXIMUM) OR AS SHOWNNOTED ON DRAWINGS.
- 5. CONCRETE TEST WILL BE MADE ON MAJOR POURS AND AT SUCH
 OTHER TIMES AS MAY BE REQUIRED BY THE ENGINEER. EACH
 TEST SHALL CONSIST OF 3 CYLINDERS OF WHICH ONE SHALL BE
 TESTED AT SEVEN DAYS, ONE TESTED AT TWENTY-EIGHT DAYS AND
 ONE RETAINED IN RESERVE FOR LATER TESTS, IF REQUIRED.

IN GENERAL, ONE TEST SHALL BE MADE FOR EACH 50 CUBIC YARDS ON CONCRETE ON EACH DAY'S POUR. SPECIMENS SHALL BE MADE AND TESTED IN ACCORDANCE WITH ASTM C-31 AND C-39 STANDARDS. SLUMP AND AIR ENTRAINMENT TEST SHALL ALSO BE MADE WITH EACH SET OF CYLINDERS TAKEN. AIR SHALL BE ADDED TO ALL CONCRETE EXPOSED TO WEATHER.

- 6. BEFORE CONCRETE IS POURED, CHECK WITH ALL TRADES TO INSURE PROPER PLACEMENT OF ALL OPENINGS, SLEEVES, CURBS, CONDUITS, BOLTS, INSERTS, ETC. RELATED TO THE WORK.
- 1. REINFORCEMENT PROTECTION:
- A, CONCRETE POURED AGAINST EARTH
- B. CONCRETE POURED AGAINST FORMS BUT EXPOSED TO WEATHER OR EARTH:
- IF BARS ARE LARGER THAN *5
 IF BARS ARE *5 OR SMALLER
- 2. IF BARS ARE *5 OR SMALLER 1.5"
 C. WALLS 2"

MASONRY

- SPECIAL INSPECTION PER I.B.C. SECTION 1704.5,
 AND TABLE 1704.5.3 IS REQUIRED ON ALL MASONRY
- 2. A CONCRETE MASONRY UNITS SHALL BE GRADE N TYPE I
 CONFORMING TO ASTM C90 "STANDARD SPECIFICATION FOR HOLLOW
 LOAD-BEARING CONCRETE MASONRY UNITS", AND SHALL HAVE
 MINIMUM COMPRESSIVE STRENGTH OF 1500 PSI.
- 3. MASONRY REINFORCING:
- A. UNLESS NOTED OTHERWISE, TYPICAL REINFORCING SHALL BE

BARS CONFORMING TO ASTM AGIS, GRADE 60.

- 1-*5 AT 32" O.C. VERT, AND 2-*4 AT 48" O.C. HORIZONTAL. B. ALL REINFORCING STEEL SHALL BE NEW STOCK DEFORMED
- C. ALL VERTICAL REINFORCING SHALL BE DOWELED

 (SAME SIZE AND SPACING AS VERTICAL BARS

 INTO FOUNDATION WALL OR FOOTING BELOW).
- D. ONLY BLOCK CELLS WITH REINFORCING SHALL BE GROUTED FULL USING CONCRETE GROUT. CELLS SHALL BE ALIGNED TO PRESERVE UNOBSTRUCTED VERTICAL CAVITIES OF 2" X 3"
- E. UNLESS OTHERWISE NOTED, ADDITIONAL VERTICAL BARS TO MATCH WALL REINFORCING SHALL BE PLACED AT JAMBS OF ALL OPENINGS ANS AT ENDS AND INTERSECTIONS OF WALLS.
- F. HORIZONTAL BARS SHALL BE PLACED IN BOND BEAMS FILLED WITH GROUT AT THE TOP OF ALL WALLS AND AT 48" O.C.,
 MAXIMUM BETWEEN TOP OF WALL AND FOUNDATION, BOND
 BEAM UNITS SHALL CONTINUE UNINTERRUPTED AROUND ALL
 CORNERS AND WALL INTERSECTIONS,
- G. ALL REINFORCING SHALL BE IN PLACE PRIOR TO GROUTING, VERTICAL REINFORCING BARS SHALL BE HELD IN POSITION AT THE TOP, BOTTOM AND AT INTERVALS NOT FARTHER APART THAN 200 BAR DIAMETERS.
- 4. MORTAR SHALL CONFORM TO ASTM C270-80A, "STANDARD SPECIFICATION FOR MORTAR FOR UNIT MASONRY", TYPE M OR S (AT CONTRACTORS OPTION), MINIMUM COMPRESSIVE STRENGTH OF 1800 PSI.
- 5. NO MASONRY SHALL BE LAID WHEN THE TEMPERATURE OF THE OUTSIDE AIR IS BELOW 40 DEGREE F., UNLESS APPROVED METHODS ARE USED DURING CONSTRUCTION TO PREVENT DAMAGE TO THE MASONRY. SUCH METHODS SHALL INCLUDE PROTECTION OF THE MASONRY FOR A PERIOD OF AT LEAST 48 HOURS. SEE UNIFORM BUILDING CODE SECTION 2104 FOR OTHER CONSTRUCTION AND PROTECTION REQUIREMENTS.
- 6. UNLESS APPROVED OTHERWISE BY THE ENGINEER, LOW LIFT GROUTED CONSTRUCTION PRACTICE SHALL BE USED. UNITS MAY BE LAID TO A HEIGHT NOT TO EXCEED 8 FEET: HOWEVER, IF THE HEIGHT EXCEEDS 4 FEET, CLEANOUTS MUST BE USED. SUCH CLEANOUTS SHALL BE PROVIDED BY SUITABLE OPENING IN THE FACE SHELLS IN THE BOTTOM COURSE OF EACH CELL TO THE GROUTED. THE CLEANOUTS SHALL BE SEALED AFTER INSPECTION AND BEFORE GROUTING.
- ALL ANCHOR BOLTS AND REINFORCING STEEL MUST BE PLACED IN GROUTED CELLS.
- 8, STOP GROUT POUR 1/2" BELOW TOP OF BLOCK UNITS,
- 9. GROUT SHALL CONSIST OF 2 PARTS PORTLAND CEMENT, 3 PARTS
 SAND AND NOT MORE THAN 2 PARTS PEA GRAVEL, IT SHALL BE
 UNIFORMLY MIXED WITH ADEQUATE WATER TO FLOW INTIMATELY
 INTO PLACE WITHOUT SEGREGATION, MINIMUM COMPRESSIVE
 STRENGTH SHALL BE 2000 PSI.

MASONRY REINFORCING LAP SPLICE LENGTH, inches

LAYER (bars centered in wall)

25

31

NOMÍNAL WALL THICKNESS

25

NUMBER OF REINFORCING LAYERS

NOMINAL WALL THÍCKNESS

48

STRUCTURAL STEEL

- 1. ALL STRUCTURAL STEEL SHALL CONFORM WITH ASTM A-36
 STANDARDS AS OUTLINED IN THE AISC "MANUAL OF STEEL
 CONSTRUCTION" (LATEST EDITION) CONTAINING THE
 SPECIFICATIONS FOR THE DESIGN, FABRICATION AND ERECTION
 OF STRUCTURAL STEEL BUILDINGS, AND THE "CODE OF STANDARD
 PRACTICE" (LATEST EDITION).
- 2. STEEL TUBING SHALL CONFORM TO A-500, GRADE B, FY = 46 KSI.
- 3. UNLESS OTHERWISE NOTES, ALL STRUCTURAL STEEL TO STEEL CONNECTIONS SHALL BE MADE IN SUCH A MANNER TO DEVELOP FULL SHEAR CAPACITY OF CONNECTING MEMBERS AS PER AISC SPECIFICATIONS.
- 4. UNLESS OTHERWISE NOTED, ALL STRUCTURAL STEEL TO STEEL BOLTED CONNECTIONS SHALL USE 3/4" DIAMETER HIGH STRENGTH BOLTS CONFORMING TO ASTM A-325 (IN) AND SHALL HAVE CARBONIZED WASHERS UNDER TURNING UNIT, ALL OTHER BOLTS SHALL CONFORM TO ASTM A-307, A-307 BOLTS ARE TO TIGHTENED BY THE TURN-OF-THE -NUT-METHOD, HIGH STRENGTH BOLTS ARE TO TIGHTENED BY EITHER TURN-OF-THE-NUT-METHOD OR LOAD INDICATOR WASHERS.
- 5. REMOVE RUST, O'LS, MILL SCALE AND APPLY ONE COAT RED LEAD IRON OXIDE SHOP PAINT, 2 MILS (DRY) THICK. PROVIDE TOUCH UP FIELD COAT AT ALL ABRADED AND WELDED AREAS, 2 MILS (DRY) THICK.
- 6. PRIOR TO FABRICATION AND PLACEMENT, SHOP DRAWINGS FOR ALL STEEL ITEMS SHALL BE PREPARED FOR AND REVIEWED BY THE STRUCTURAL ENGINEER.
- 1. ALL WELDS SHALL BE MADE WITH E10XX ELECTRODES AND BY WELDERS CERTIFIED BY A.W.X., STANDARDS WITHIN THE LAST 12 MONTHS (PROVIDE WRITTEN CERTIFICATION IF REQUESTED) WHERE NOTED ON THE DRAWINGS.
- A. ALL FIELD WELDING SHALL BE DONE UNDER THE DIRECT SUPERVISION OF AN INDEPENDENT TESTING LABORATORY AS SELECTED BY THE ARCHITECT/ENGINEER.
- B. ALL FULL PENETRATION OR FUSION WELDS SHOWN ON DRAWINGS ARE TO BE TESTED BY X-RAY PER AWS.
- C. THE OWNER MAY TEST ALL FILLET WELDS OR PORTIONS
- D. COPIES OF TEST RESULTS TO BE SENT TO ARCHITECT/STRUCTURAL ENGINEER.

SPECIAL INSPECTION:

- I. SPECIAL INSPECTIONS SHALL BE PROVIDED DURING CONSTRUCTION FOR THE FOLLOWING:
- CONCRETE:
 DURING THE TAKING OF TEST SPECIMANS AND PLACING OF
 REINFORCED CONCRETE (EXCEPT SLABS ON GRADE).
 BOLTS INSTALLED IN CONCRETE:
 PRIOR TO AND DURING THE PLACEMENT OF CONCRETE AROUND
- BOLTS IDENTIFIED ON THE DRAWINGS (IF ANY) AS REQUIRING SPECIAL INSPECTIONS.

 REINFORCING STEEL:
 FOR CONFORMANCE WITH THE APPROVED PLANS PRIOR TO THE
- CLOSING OF FORMS OR THE DELIVERY OF CONCRETE TO THE JOB SITE,
 STRUCTURAL WELDING:
- STRUCTURAL WELDING:

 VERIFY THE MATERIALS, QUALIFICATIONS OF THE WELDING

 PROCEDURES AND WELDERS PRIOR TO THE START OF WORK AND

 PROVIDE PERIODIC INSPECTIONS OF WORK IN PROGRESS AND A

 VISUAL INSPECTION OF ALL WELDS (INCLUDING WELDING OF METAL

 ROOF DECK) PRIOR TO COMPLETION OF WORK. STRUCTURAL STEEL

 SHALL BE PROVIDE FOR BY A REGISTERED AND APPROVED FABRICATOR.

 INSPECTION IS NOT REQUIRED FOR WELDING DONE IN AN

 APPROVED FABRICATOR'S SHOP.

 HIGH STRENGTH BOLTING:
- PROVIDE PERIODIC INSPECTIONS TO INSURE THAT THE PLIES OF THE CONNECTED ELEMENTS HAVE BEEN BROUGHT IN TO SNUG CONTACT.
- STRUCTURAL MASONRY:
 DURING THE PREPARATION AND TAKING OF ANY REQUIRED PRISMS
 OR TEST SPECIMENS, AT THE START OF LAYING UNITS, AFTER THE
 PLACEMENT OF REINFORCING STEEL, GROUT SPACE PRIOR TO EACH
 GROUTING OPERATION, AND DURING ALL GROUTING OPERATIONS.
- EPOXY ANCHORS AND REINFORCEMENT EMBEDDED WITH EPOXY:
 PROVIDE INSPECTION OF HOLES AND PROVIDE CONTINUOUS
 INSPECTION DURING PLACEMENT OF EPOXY ANCHORS OR OTHER
 ITEMS EMBEDDED IN CONCRETE OR MASONRY. INSPECTOR TO
 VERIFY TYPE AND EMBEDMENT OF ANCHORS.

 2. THE SPECIAL INSPECTOR SHALL BE A QUALIFIED PERSON WHO SHALL
- 2. THE SPECIAL INSPECTOR SHALL BE A QUALIFIED PERSON WHO SHALL DEMONSTRATE HIS COMPETENCE, TO THE SATISFACTION OF THE BUILDING OFFICIAL FOR INSPECTION OF THE PARTICULAR TYPE OF CONSTRUCTION OR OPERATION REQUIRING SPECIAL INSPECTION.

 3. DUTIES AND RESPONSIBILITIES OF THE SPECIAL INSPECTOR:
- OBSERVE THE WORK ASSIGNED FOR CONFORMANCE WITH THE APPROVED DESIGN DRAWINGS AND SPECIFICATIONS. THE INSPECTOR MAY NOT ALTER, MODIFY, ENLARGE OR WAIVE ANY OF THE REQUIREMENTS OF THE DOCUMENTS.
 FURNISH INSPECTION REPORTS TO THE OWNER, THE BUILDING OFFICIAL,
- FURNISH INSPECTION REPORTS TO THE OWNER, THE BUILDING OFFICIAL, AND THE PROFESSIONAL OF RECORD. ALL DISCREPANCIES SHALL BE BROUGHT TO THE IMMEDIATE ATTENTION OF THE CONTRACTOR FOR CORRECTION, THEN, IF UNCORRECTED, SUBMIT A COMPLETE LIST TO ALL OUTSTANDING DISCREPANCIES ON A WEEKLY BASIS TO THE OWNER, THE BUILDING OFFICIAL, AND THE PROFESSIONAL OF RECORD UNTIL ALL CORRECTIONS HAVE BEEN COMPLETED.

 SUBMIT A FINAL SIGNED REPORT STATING WHETHER THE WORK
- SUBMIT A FINAL SIGNED REPORT STATING WHETHER THE WORK REQUIRING SPECIAL INSPECTIONS WAS, TO THE BEST OF THE INSPECTOR'S KNOWLEDGE, IN CONFORMANCE WITH THE APPROVED PLANS AND SPECIFICATIONS AND THE APPLICABLE WORKMANSHIP PROVISIONS OF THE CODE.
- 4. STRUCTURAL OBSERVATION (AS DEFINED IN CHAPTER IT OF THE BUILDING CODE) IS NOT REQUIRED.
 5. WHERE SPECIAL INSPECTION REQUIREMENTS DUPLICATE THE
- WHERE SPECIAL INSPECTION REQUIREMENTS DUPLICATE THE REQUIREMENTS OF OTHER SPECIFIED TESTING, DUPLICATE INSPECTIONS SHALL NOT BE REQUIRED.

architecture planning interiors

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CREATED BY: JSA ARCHITECTS

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CONSULTANTS:

BUILDING NAME:

UTAH NATIONAL GUARD JLTC

PROJECT TITLE:

BUILDING #4

CAMP WILLIAMS DRAPER, UT

MARK | DATE | DESCRIPTION

ISSUE TYPE: CONSTRUCTION SE

ISSUE DATE: 5/18/06

CAD DWG FILE:

DFCM PROJECT NO: 06013480 CAD PROJECT NO: 0625

DRAWN BY: CDJ CHK'D BY: CJ


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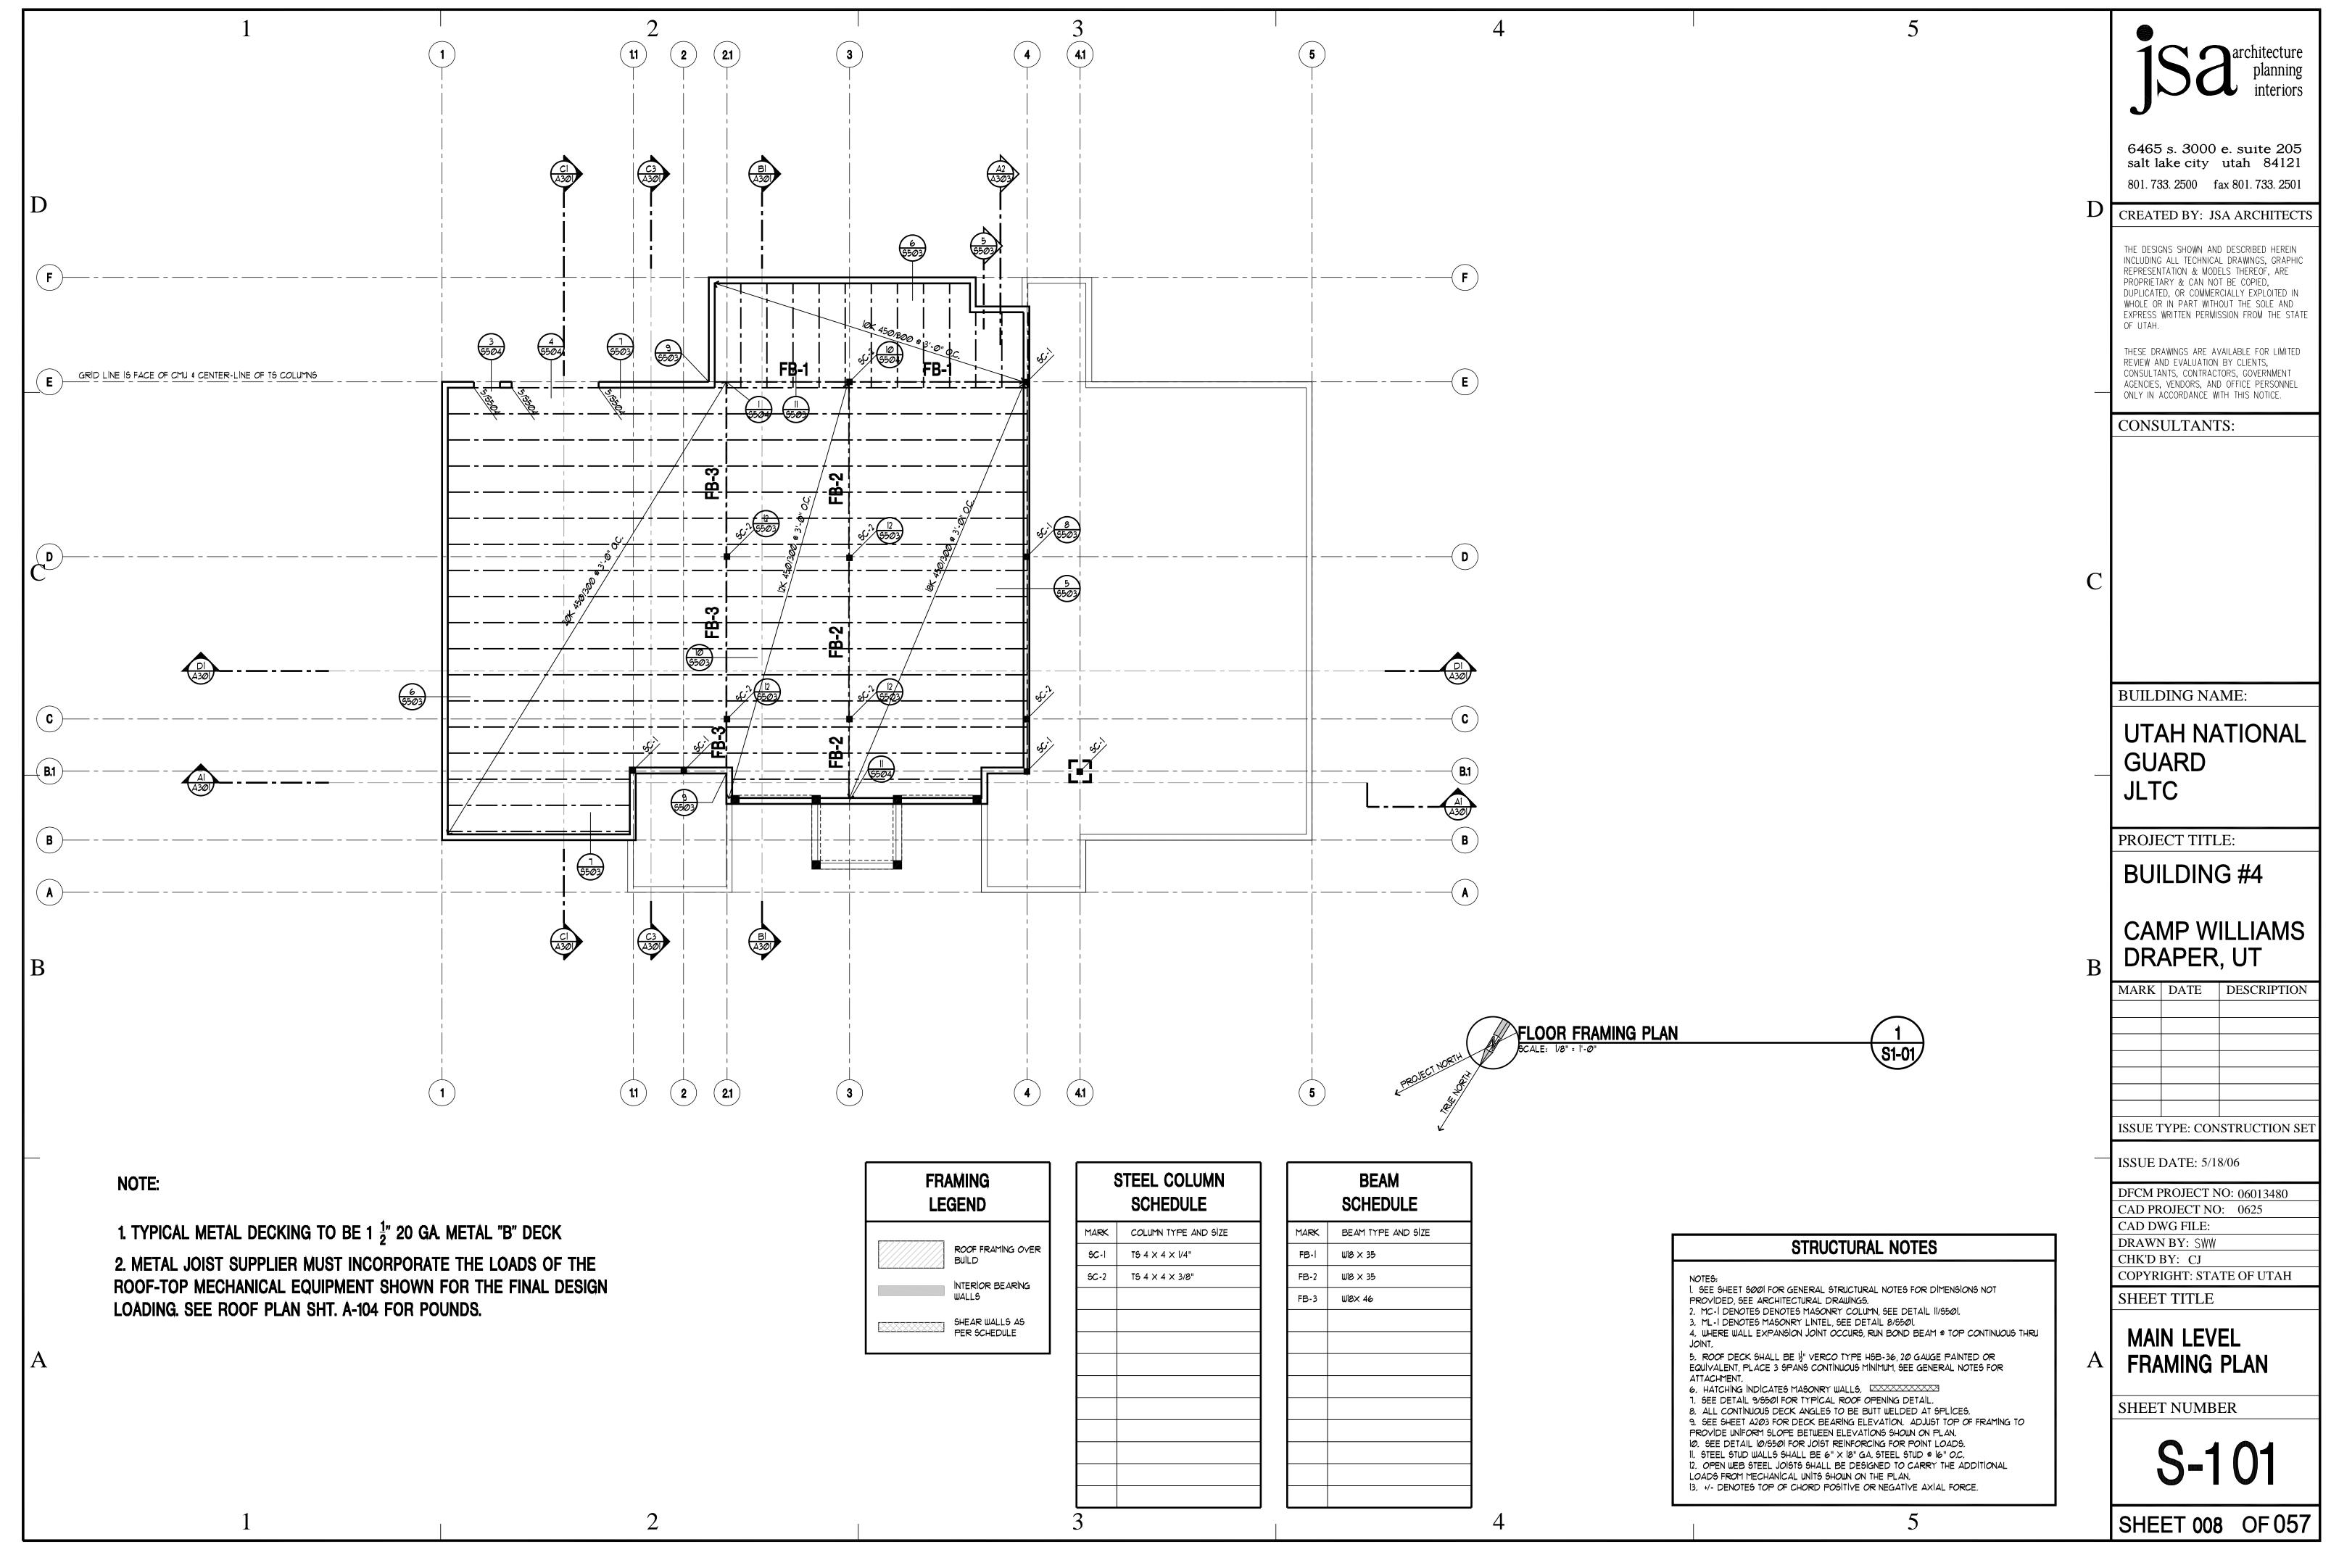
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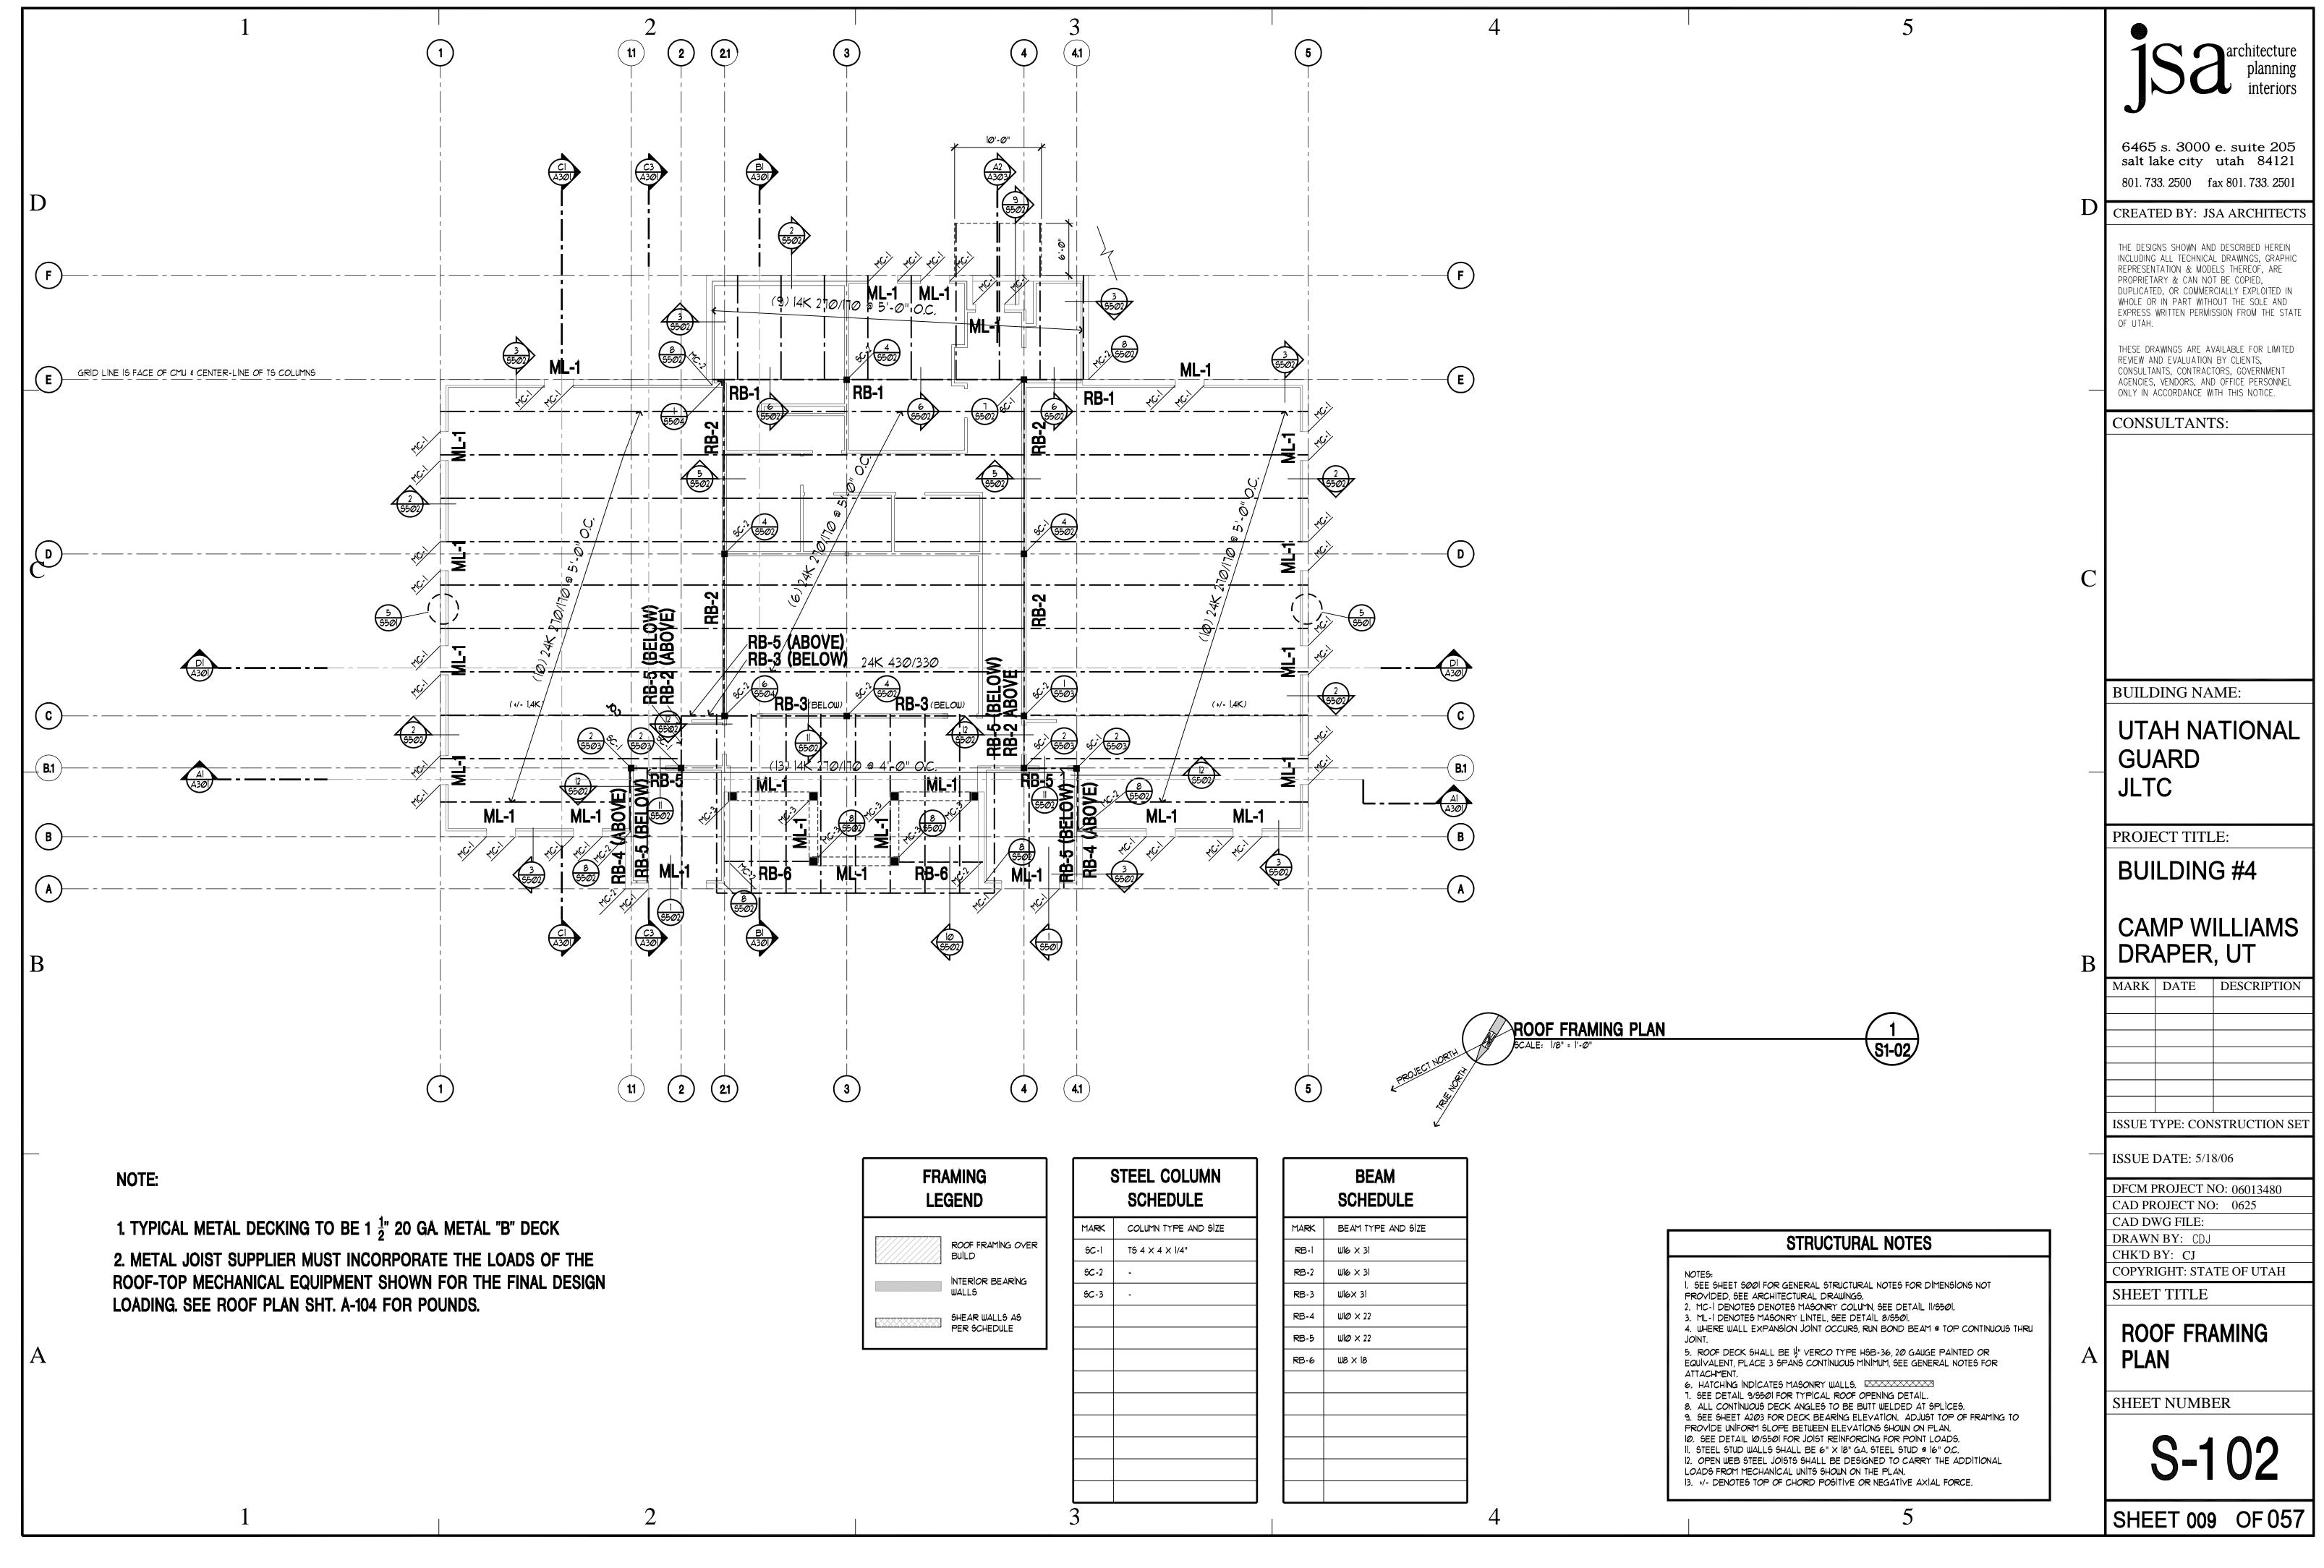
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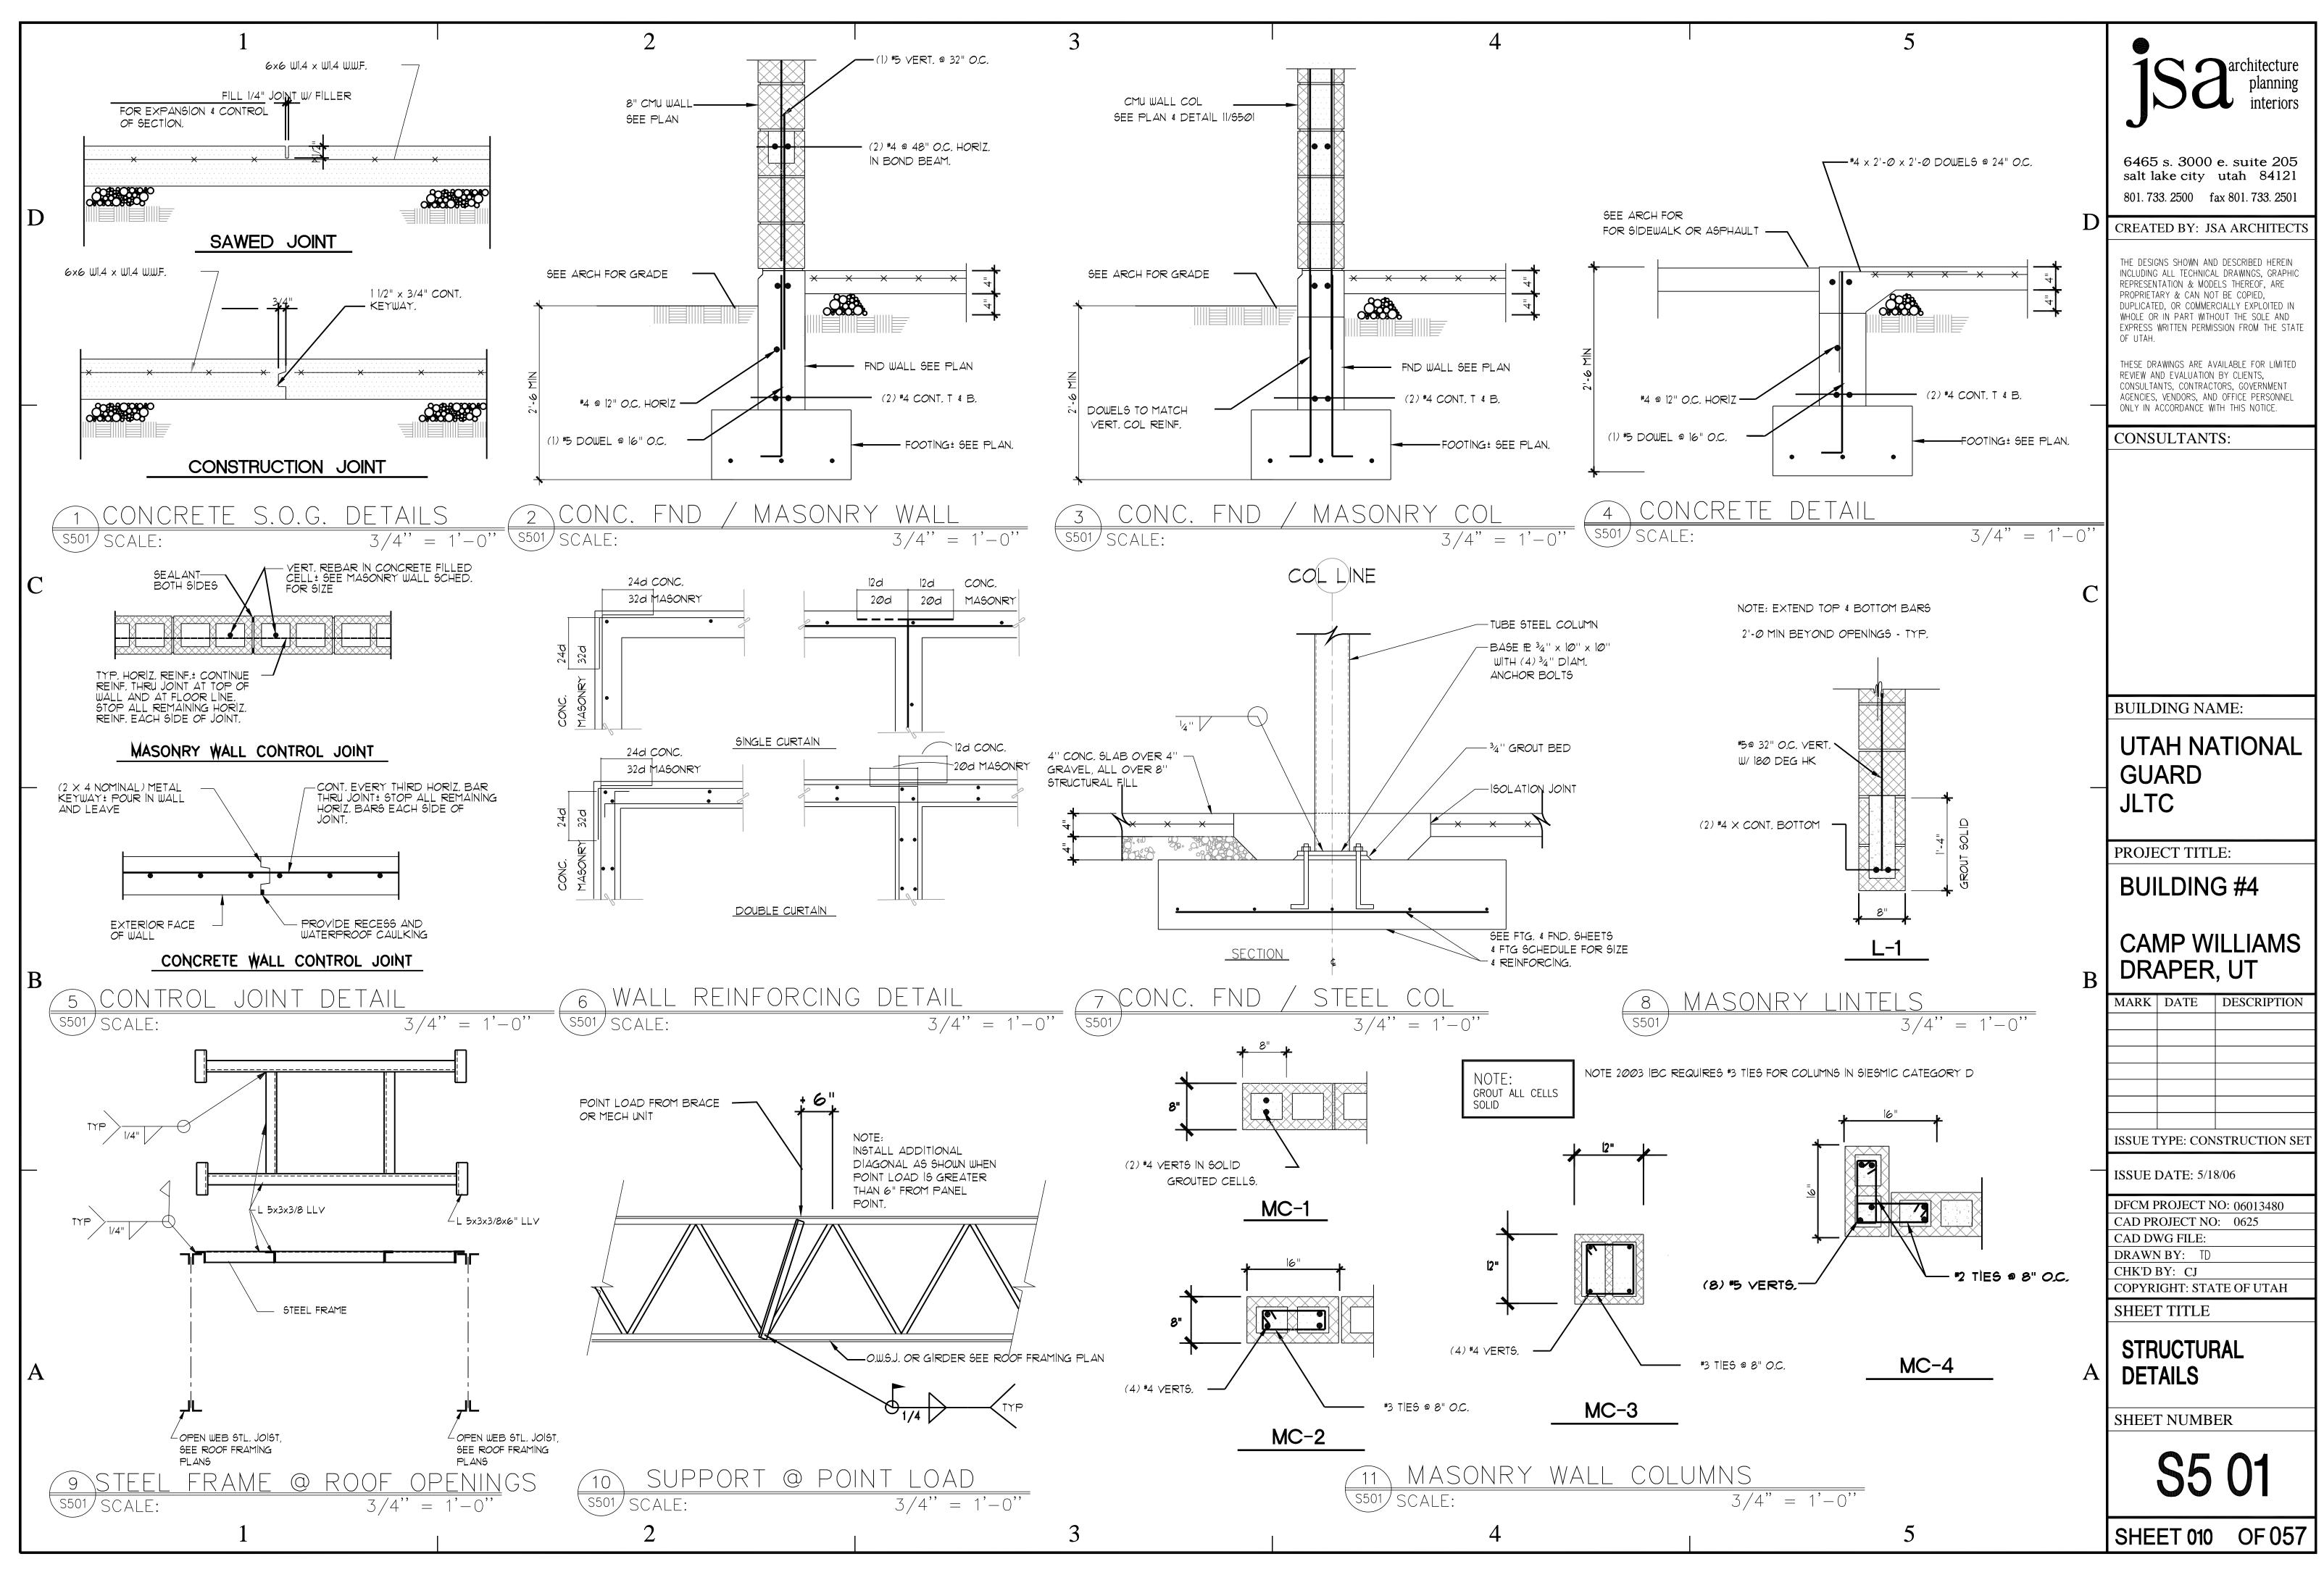
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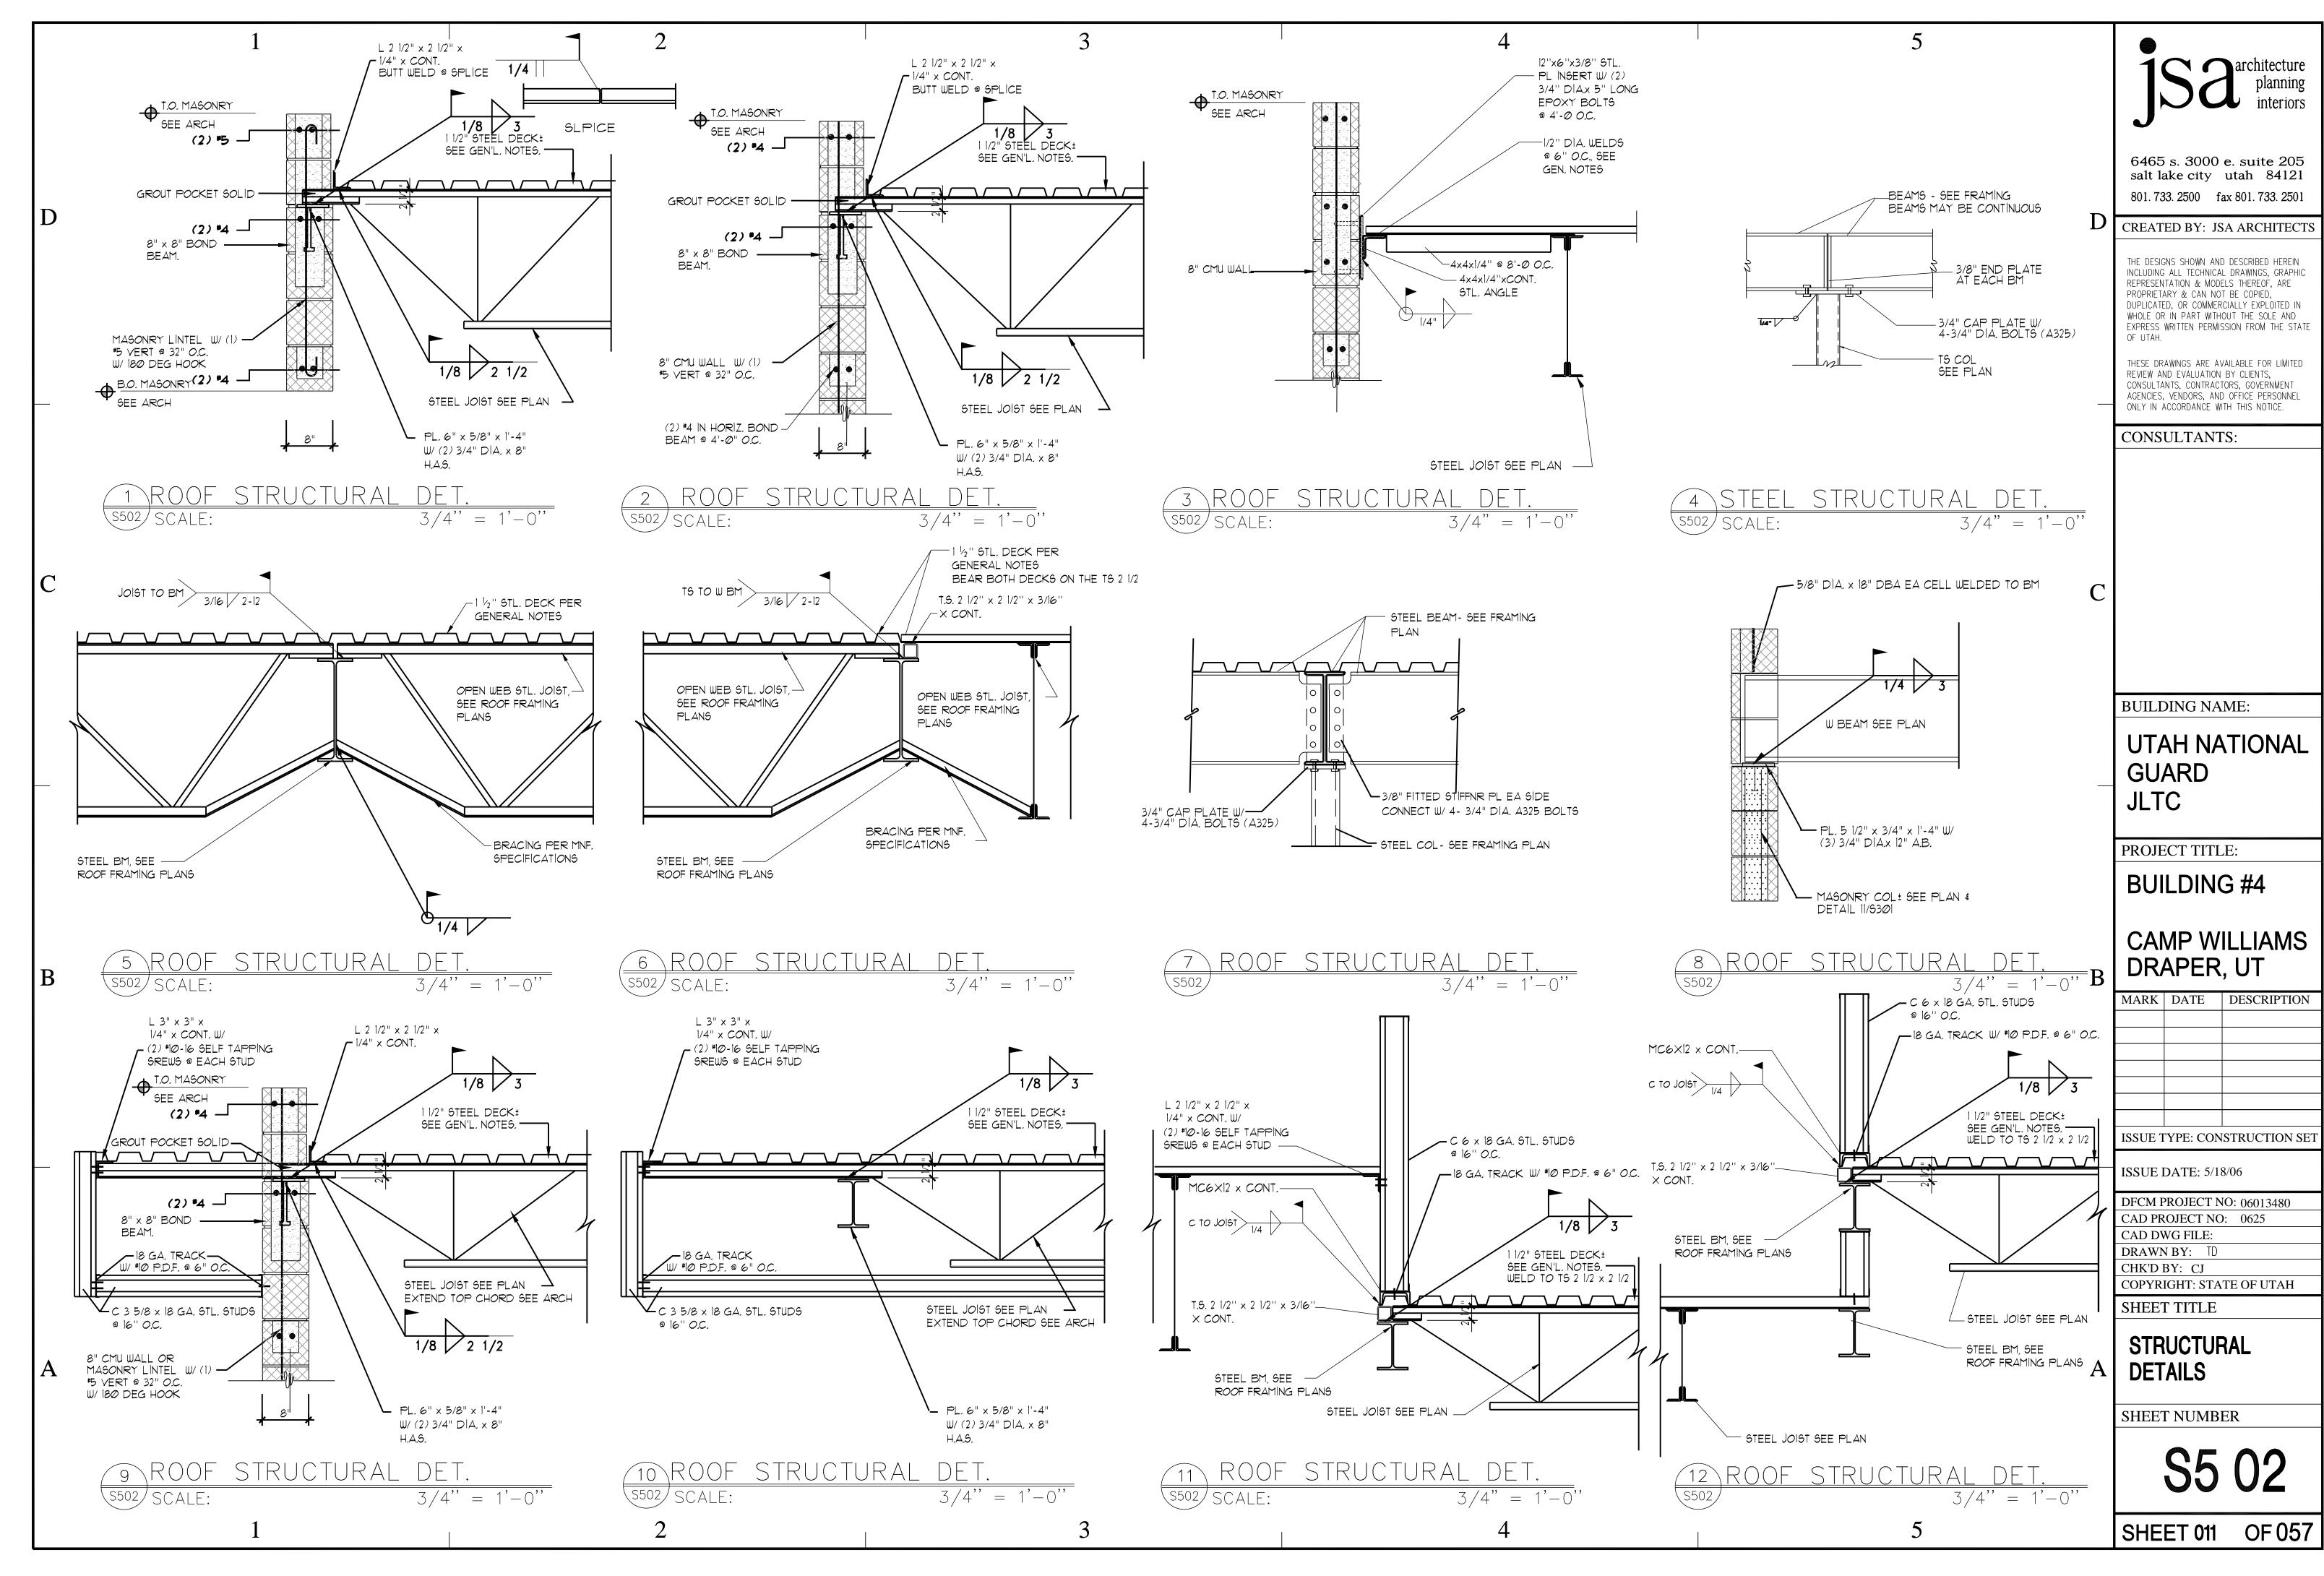
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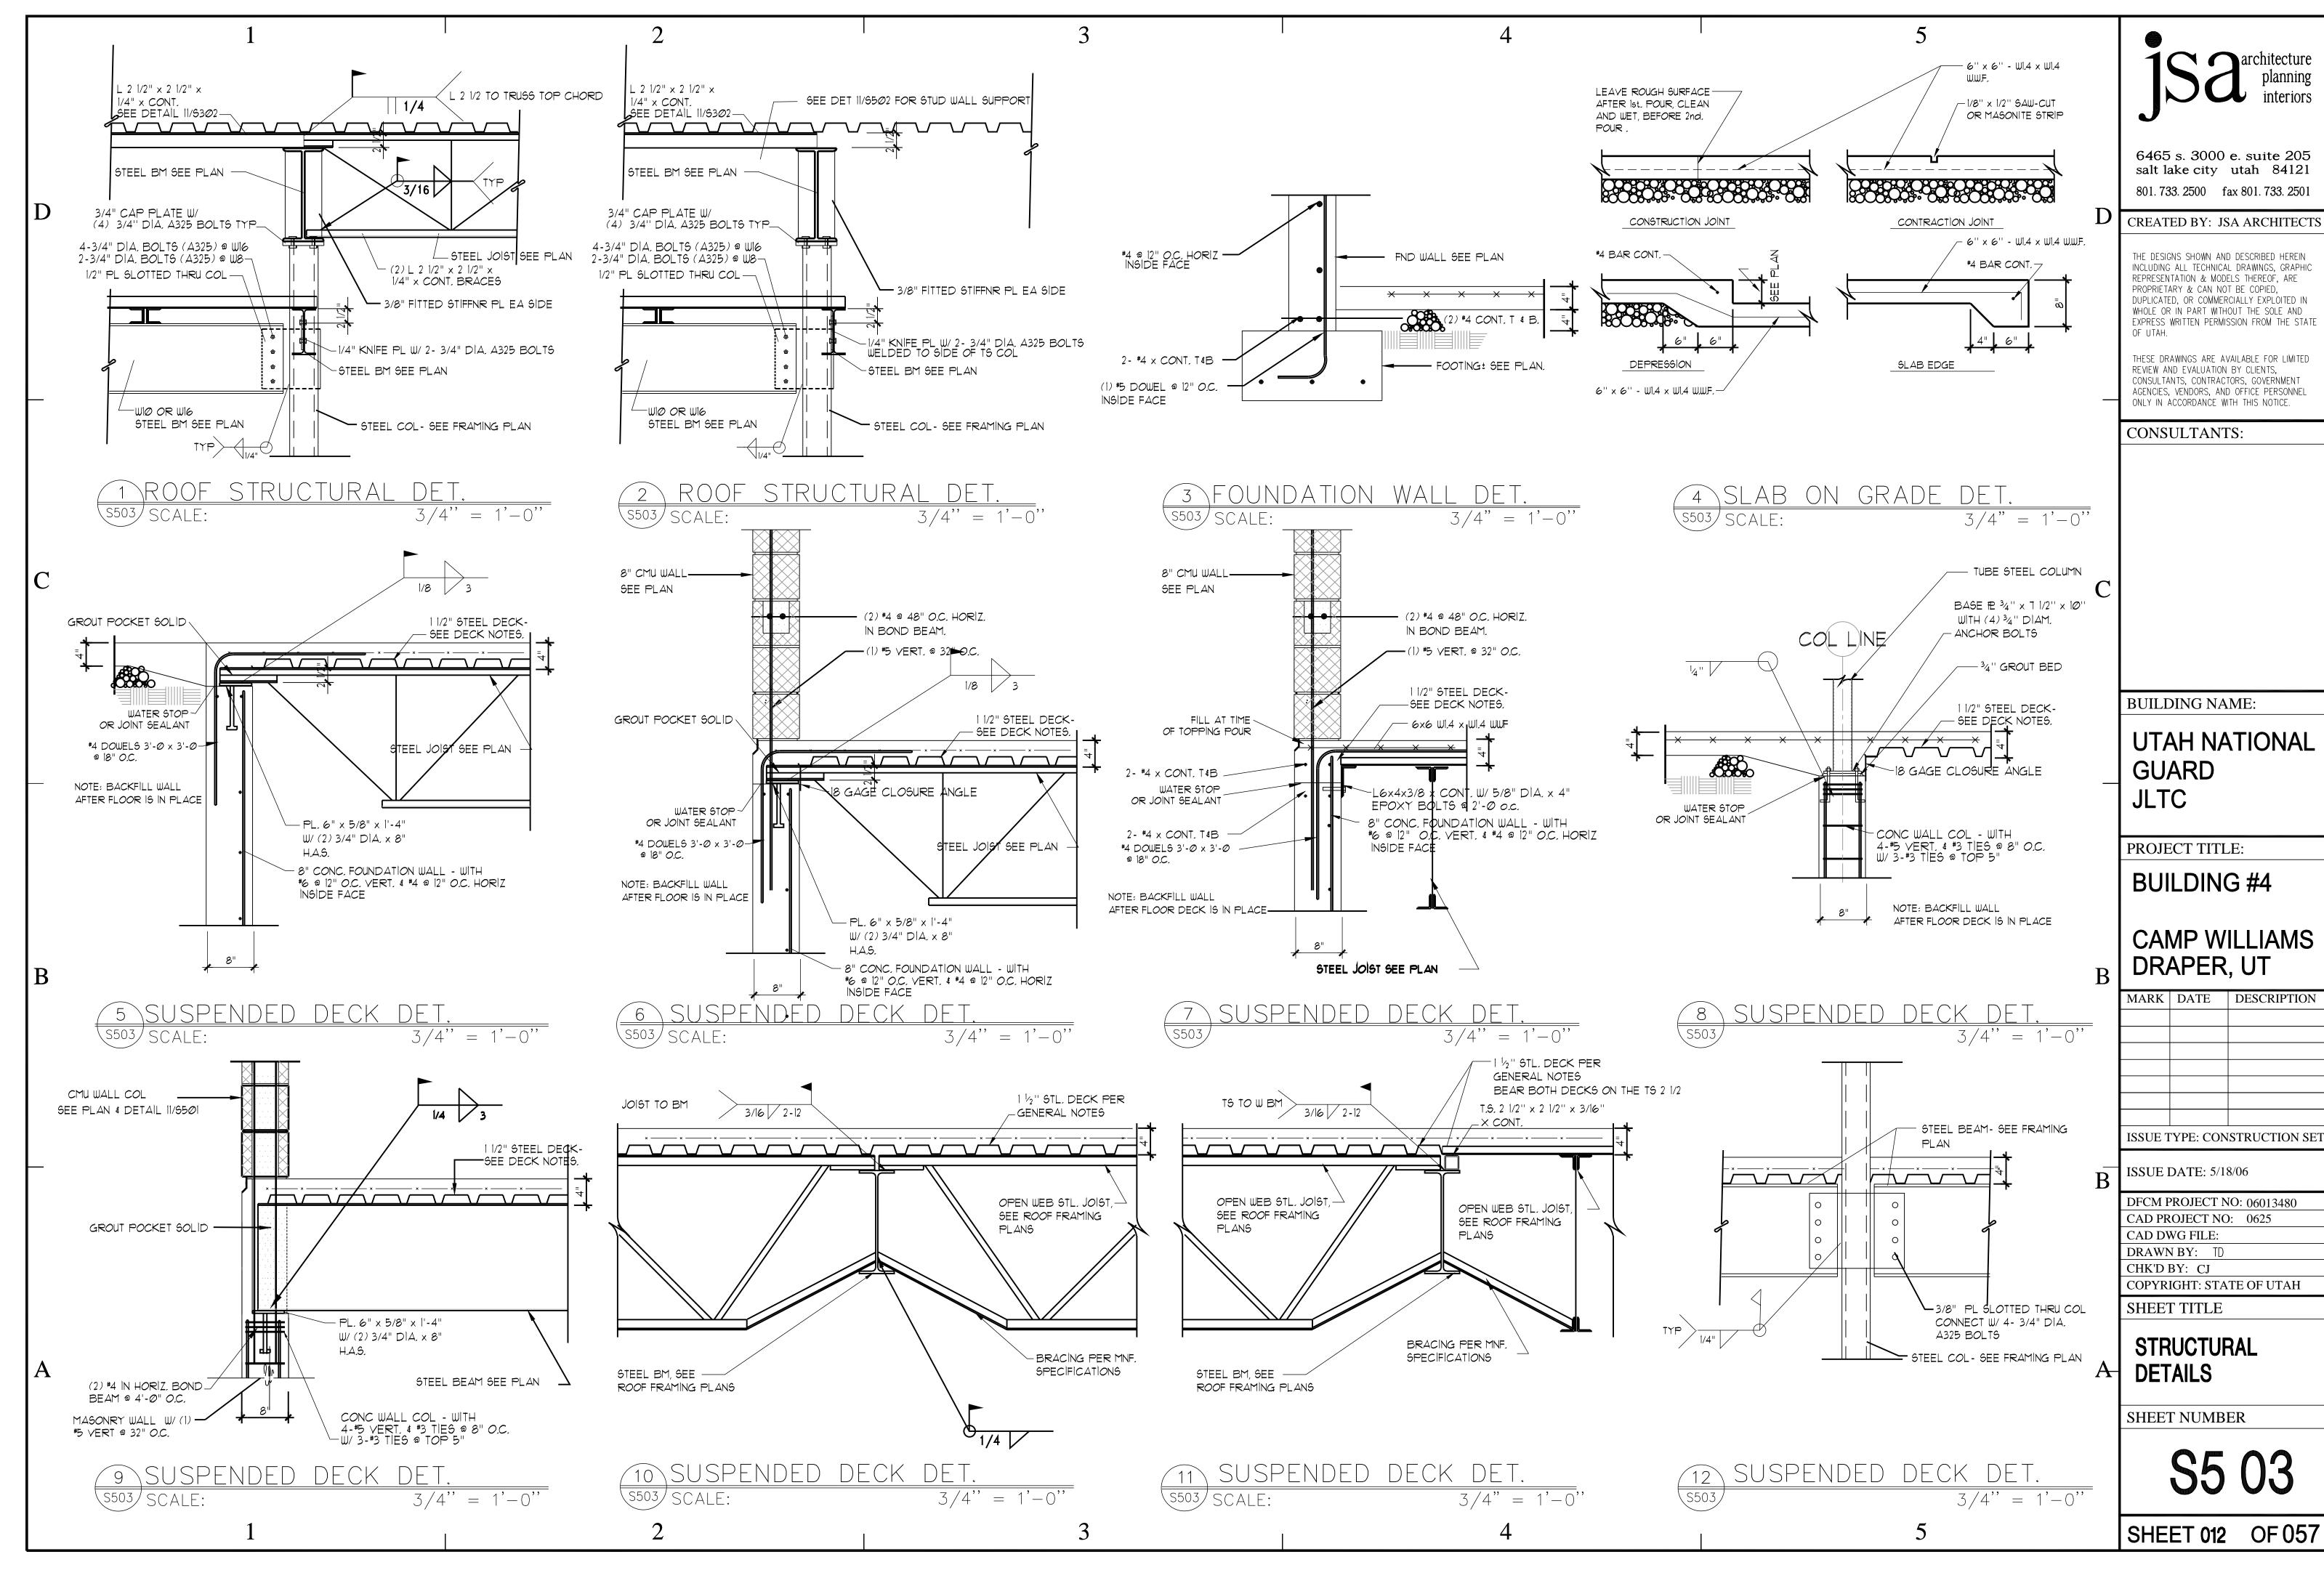














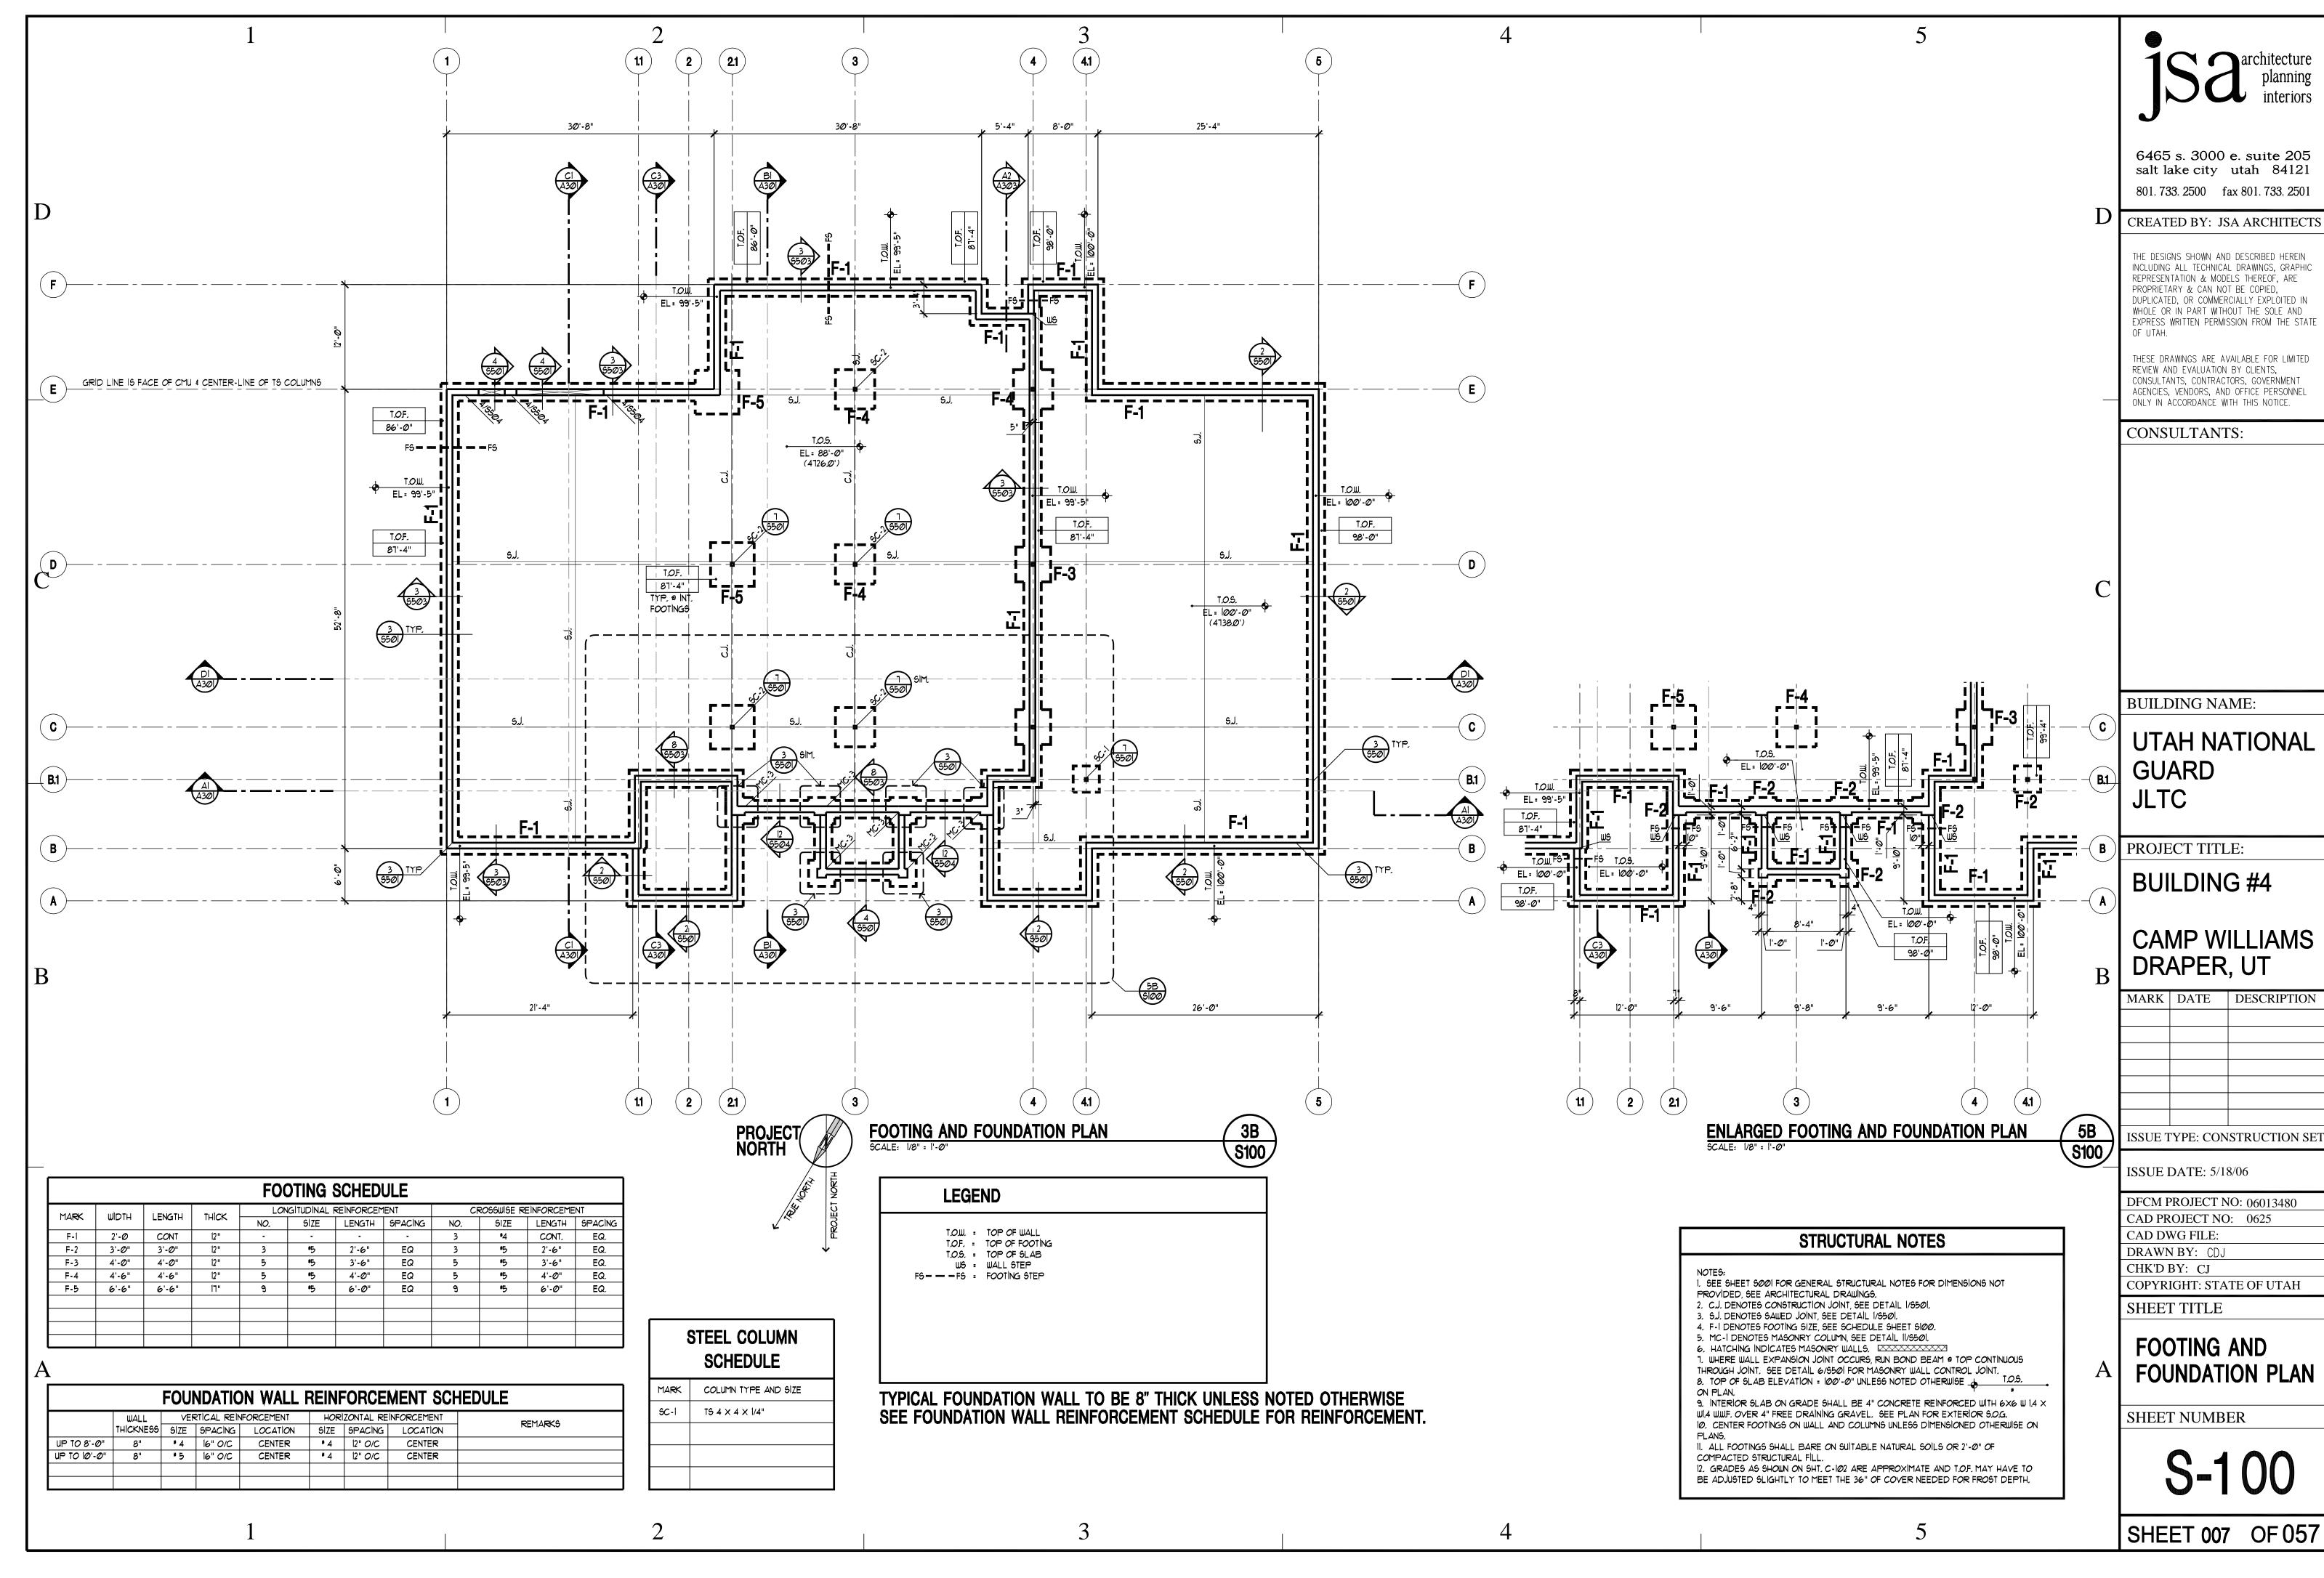


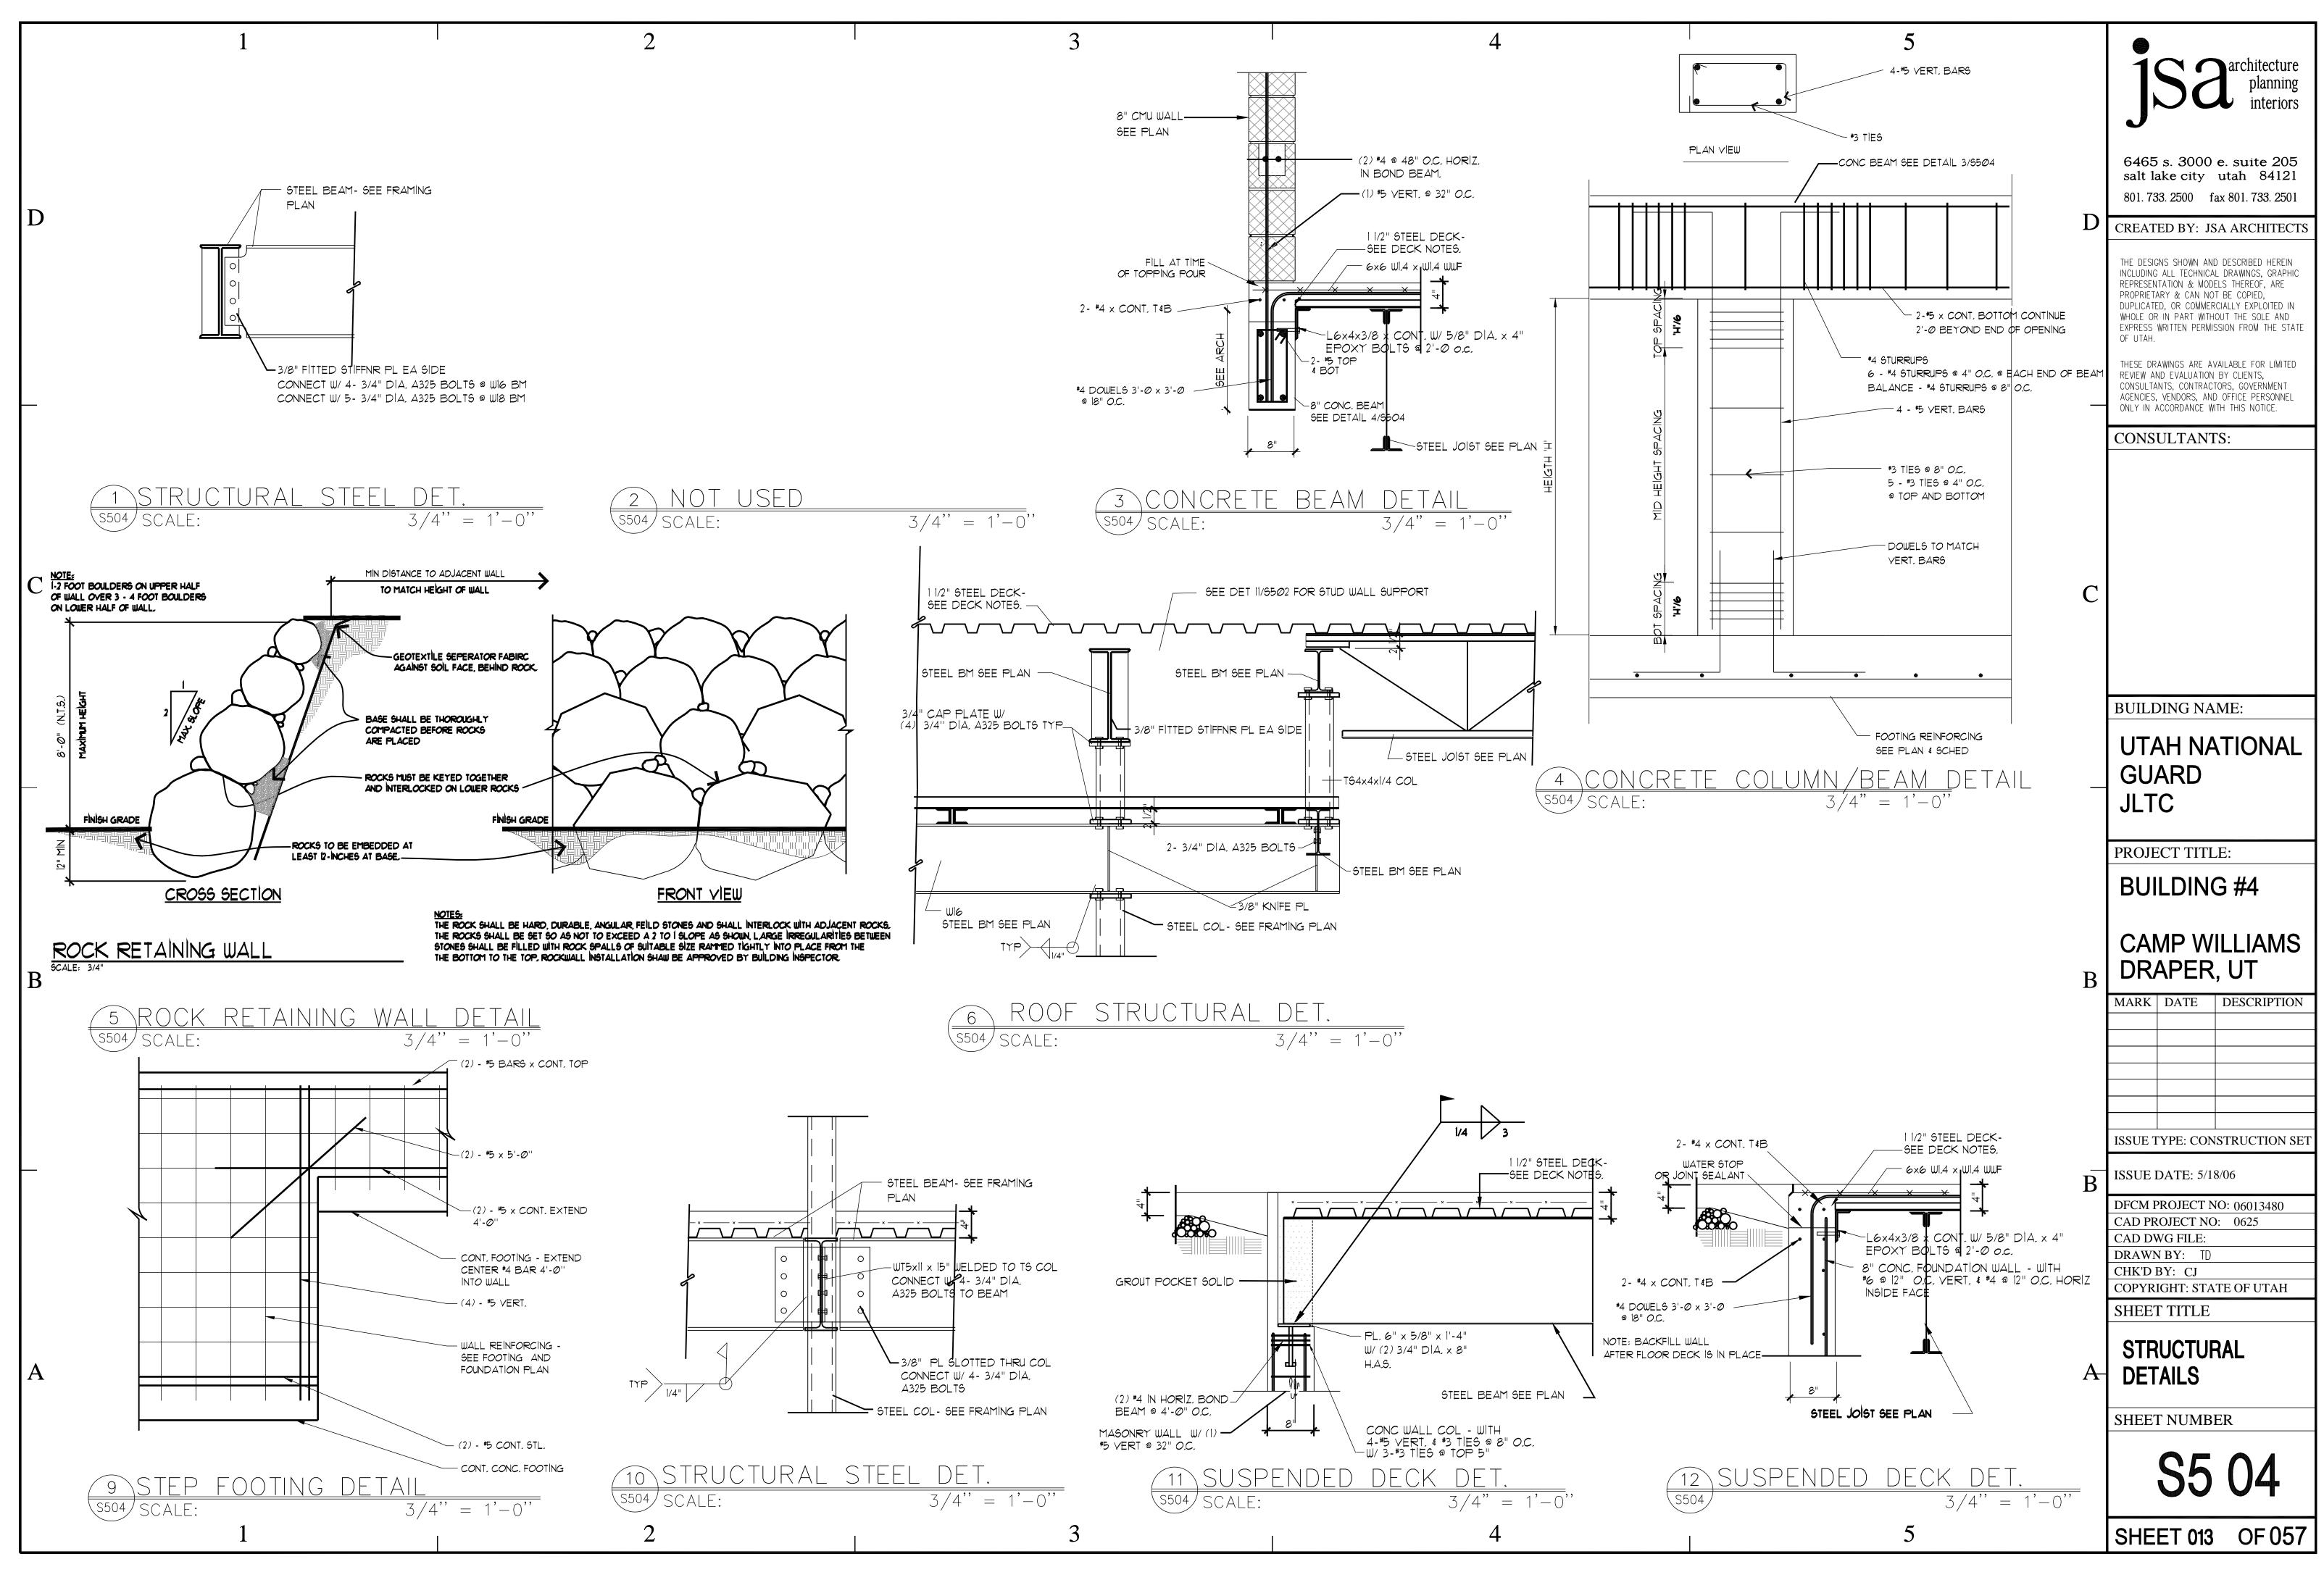


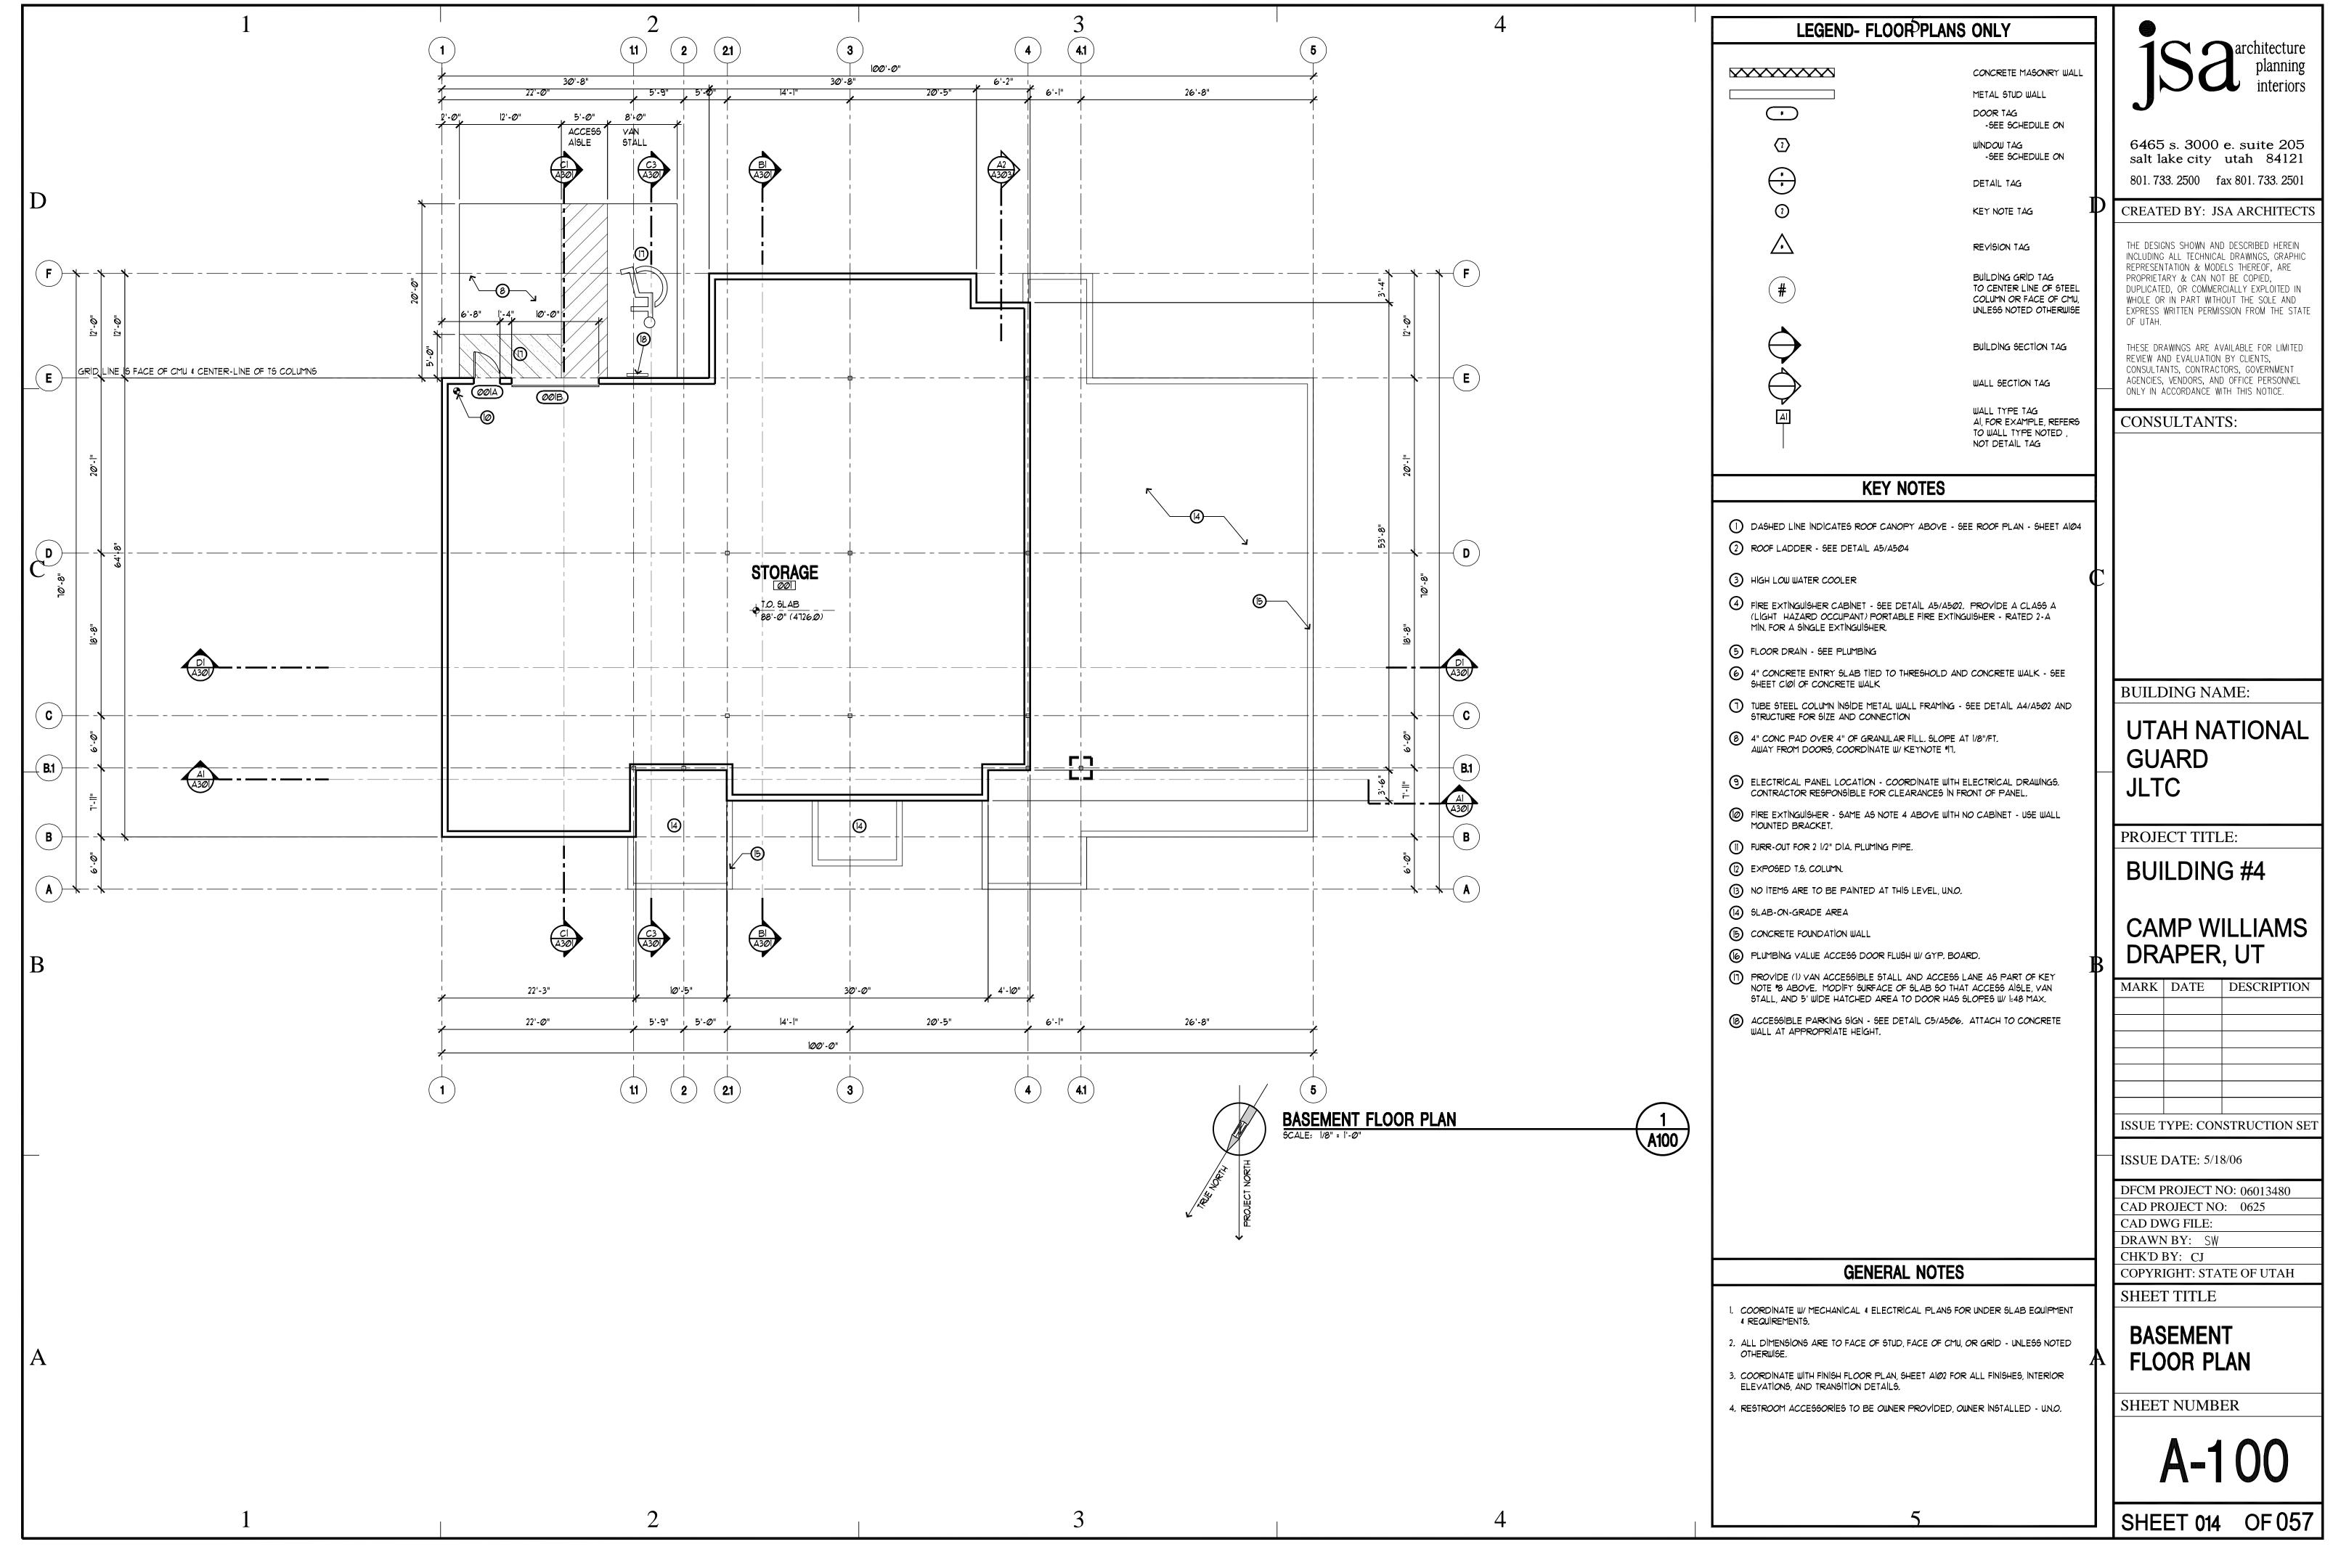


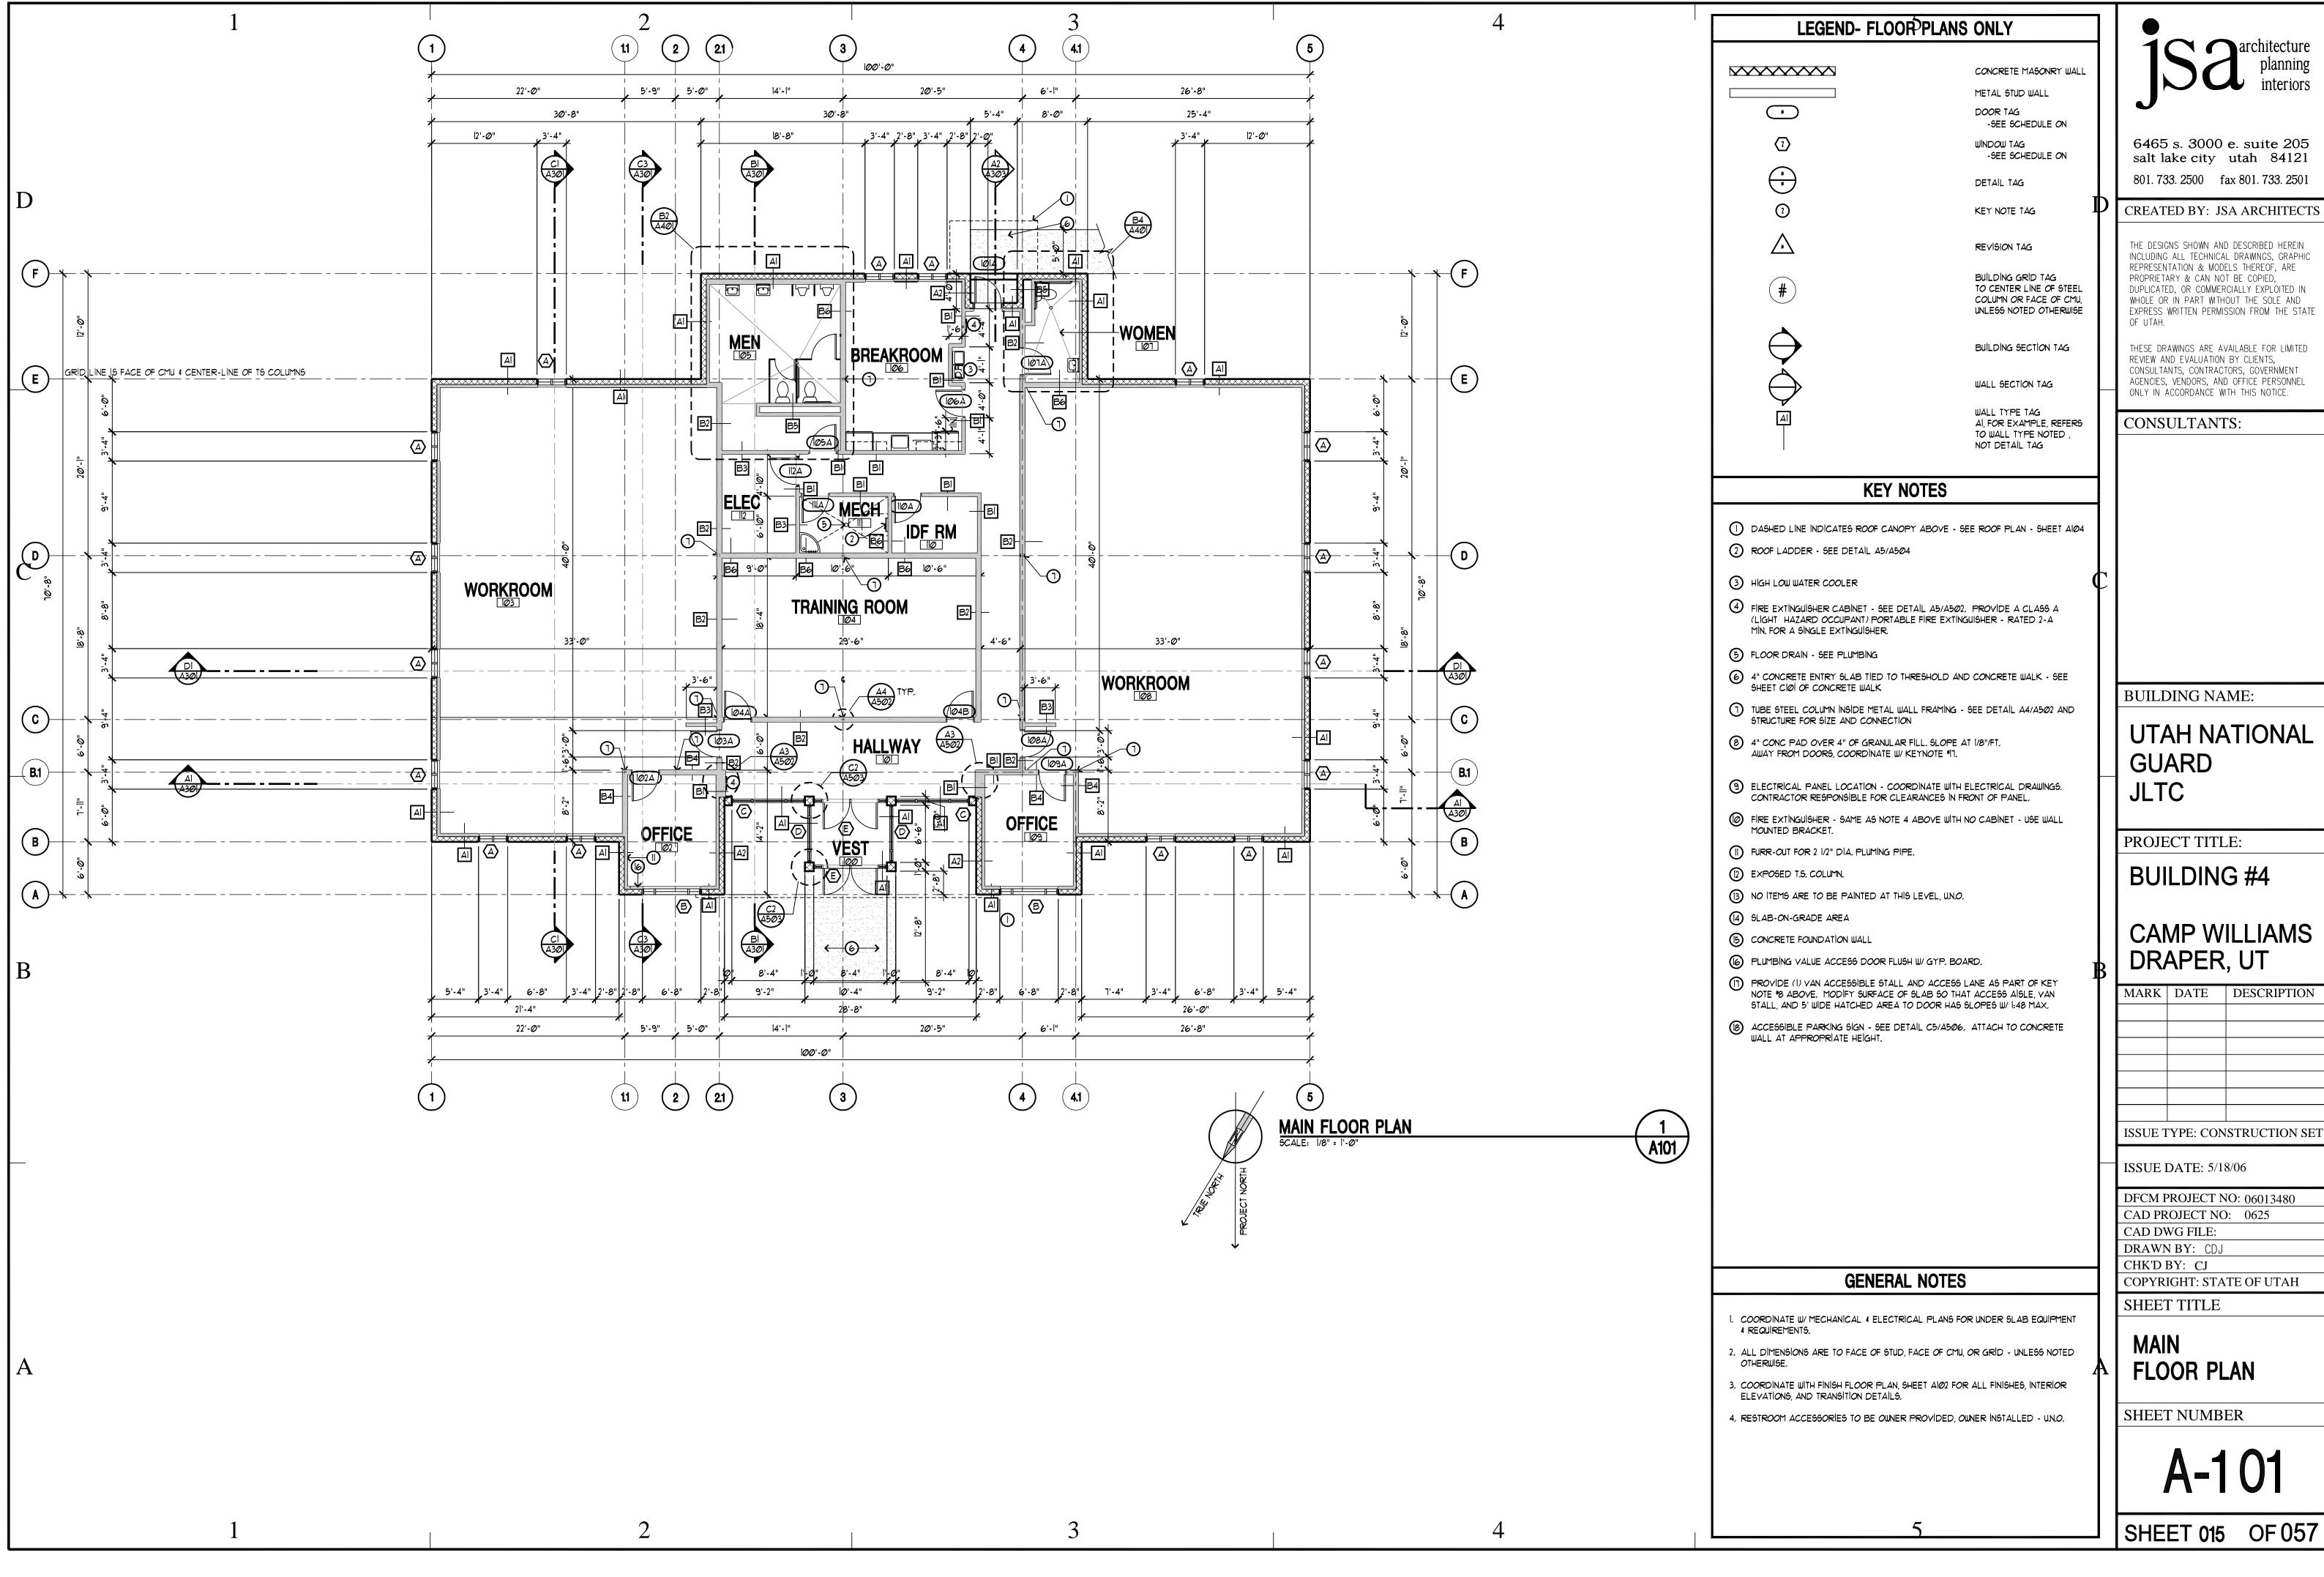


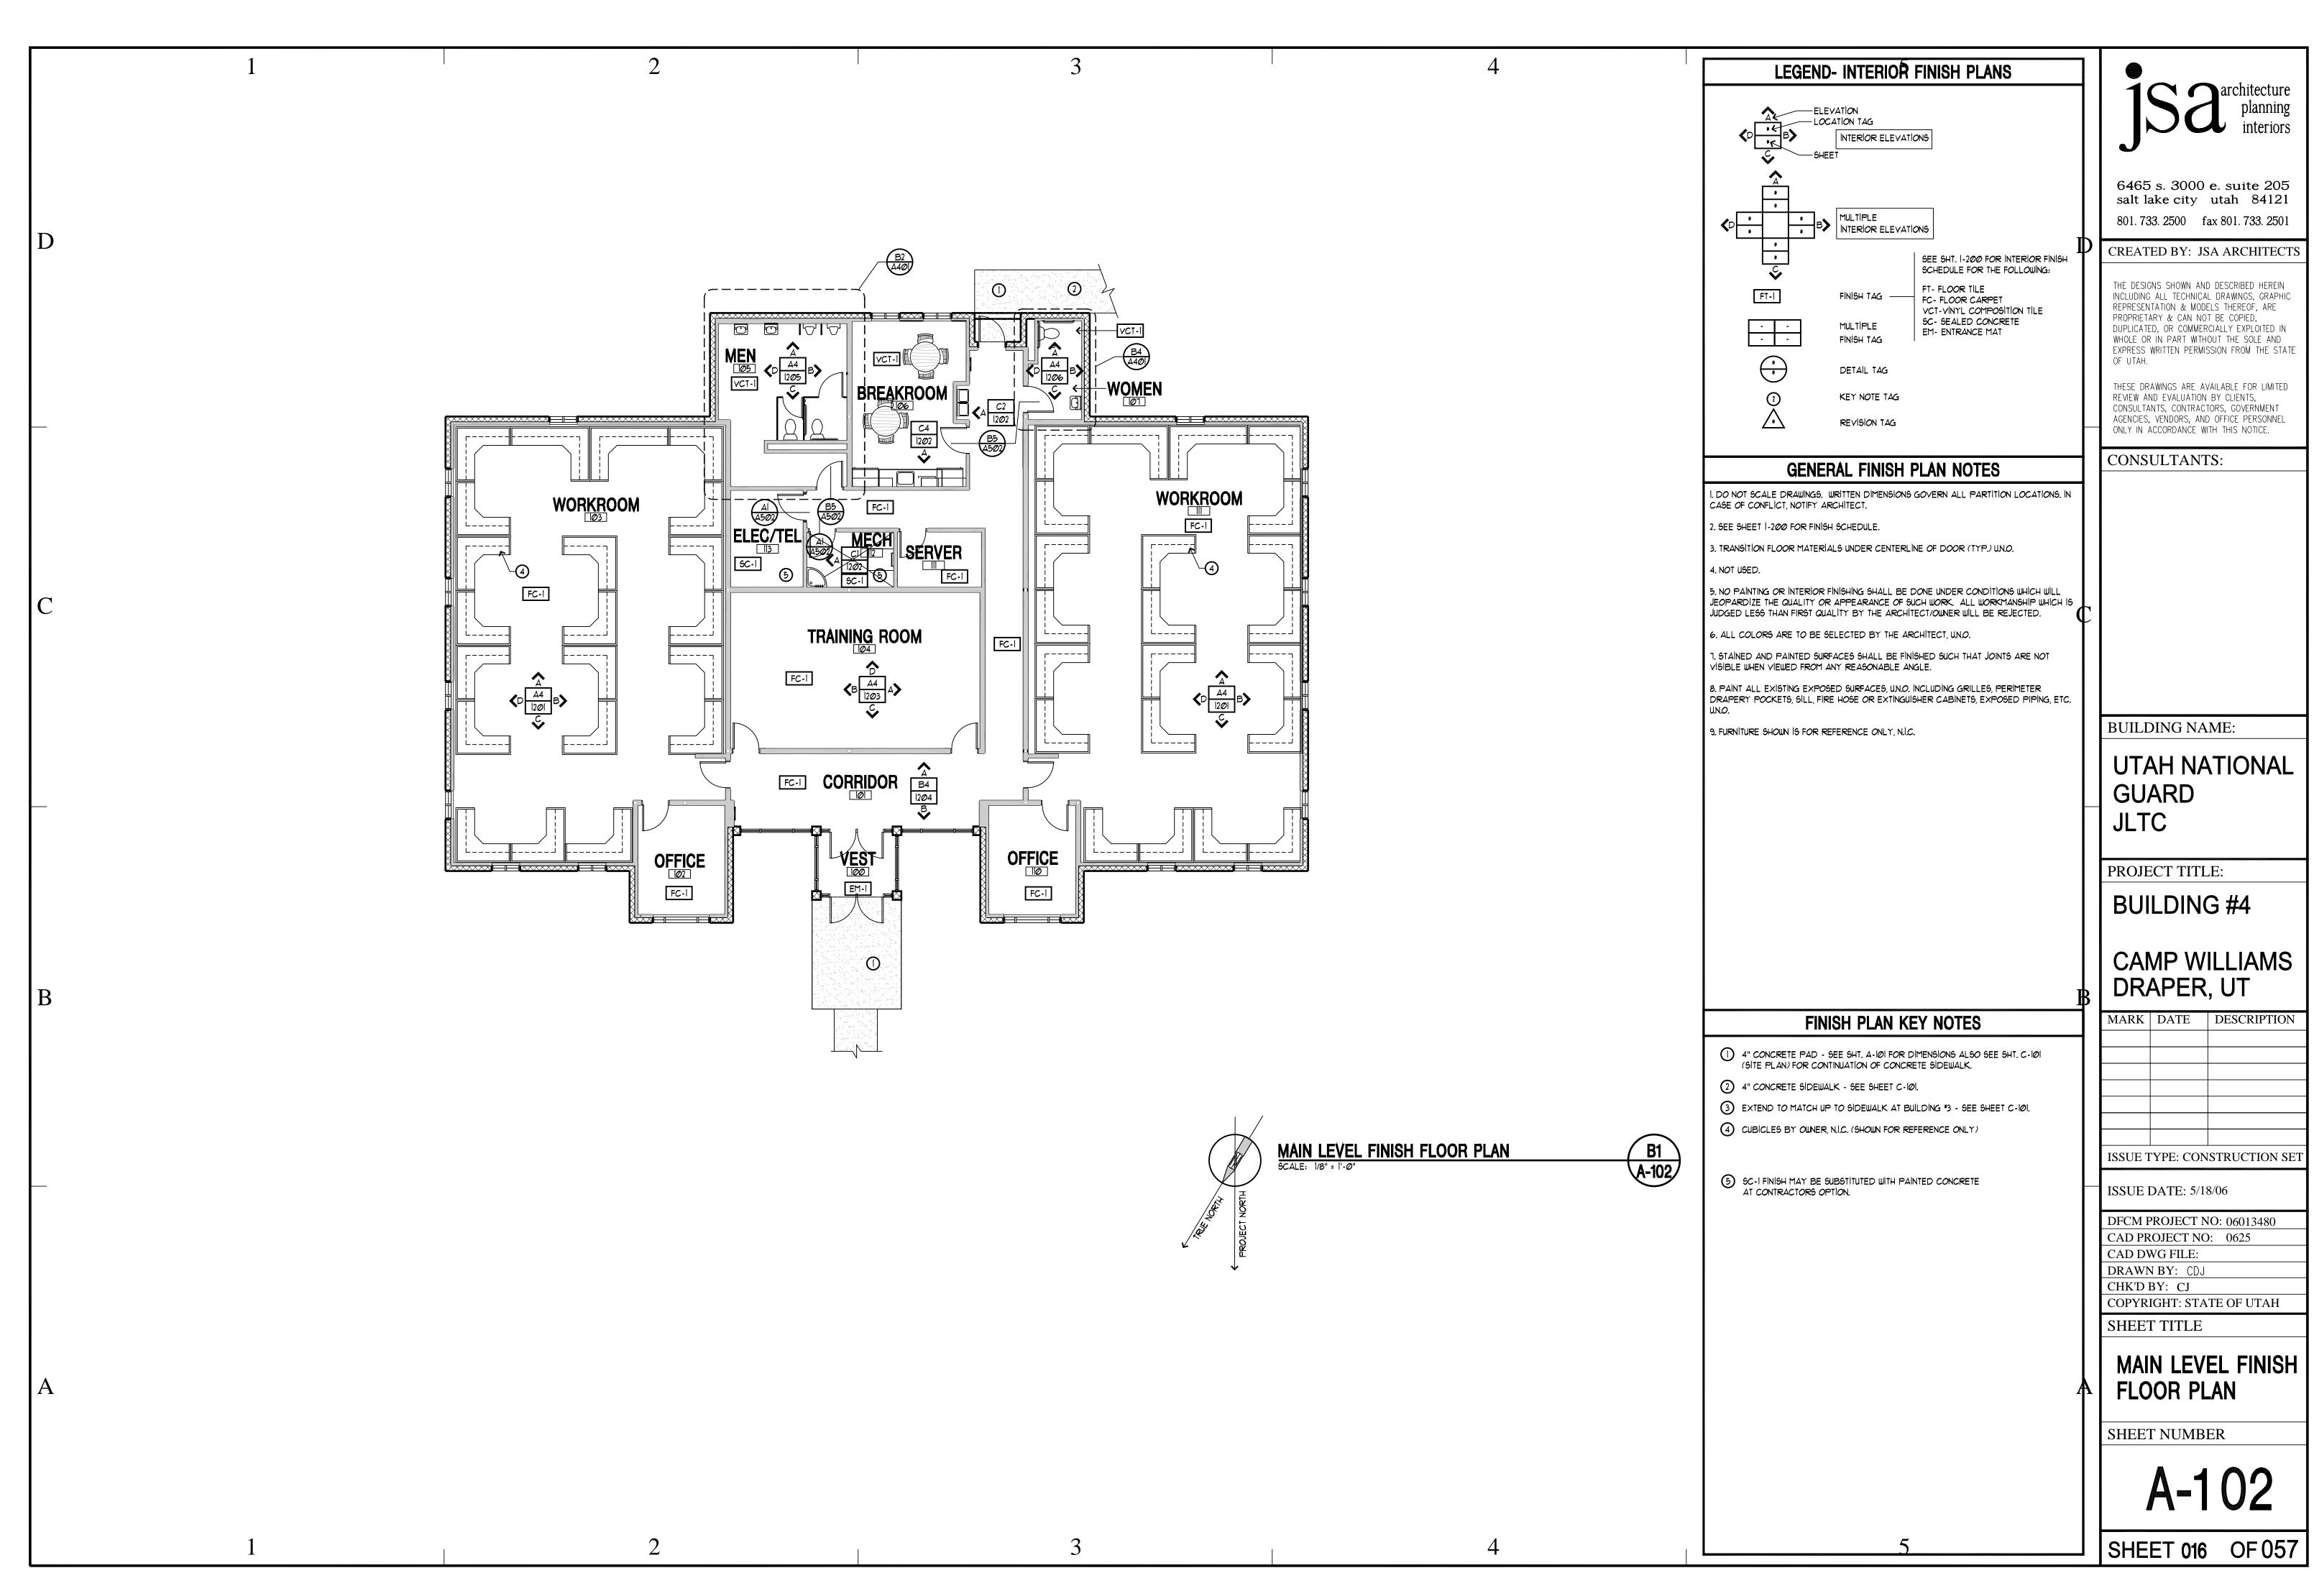


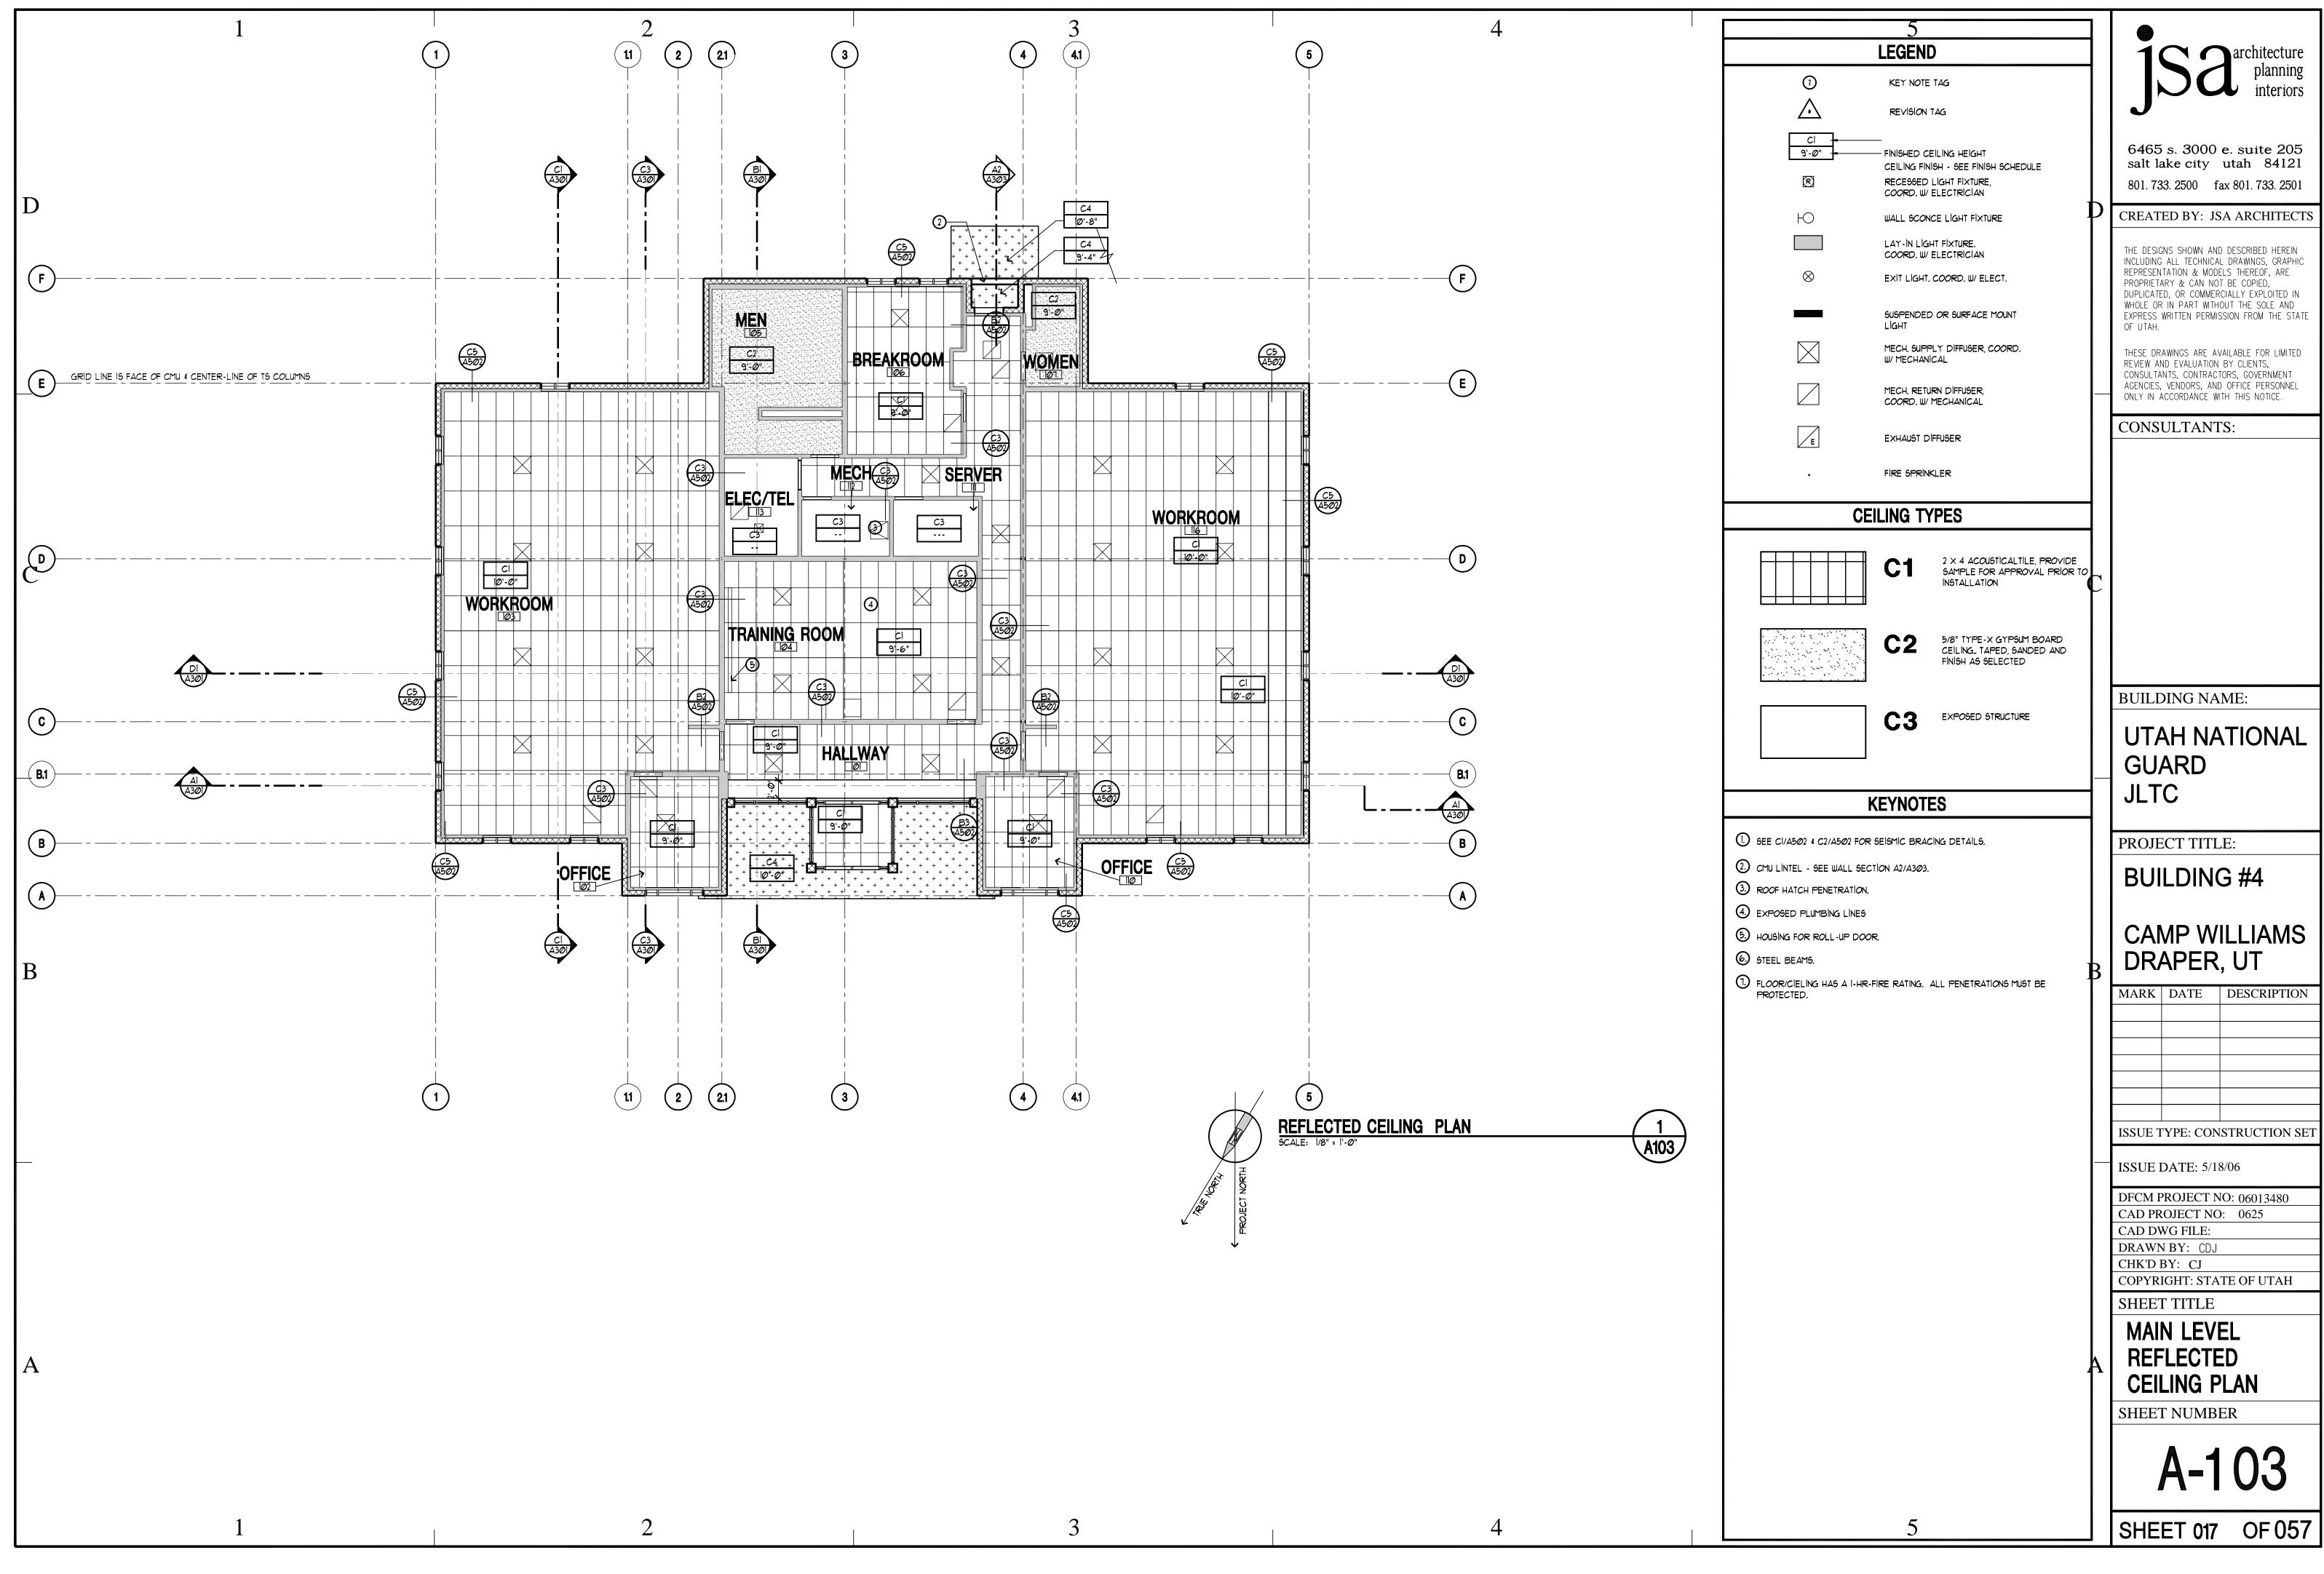


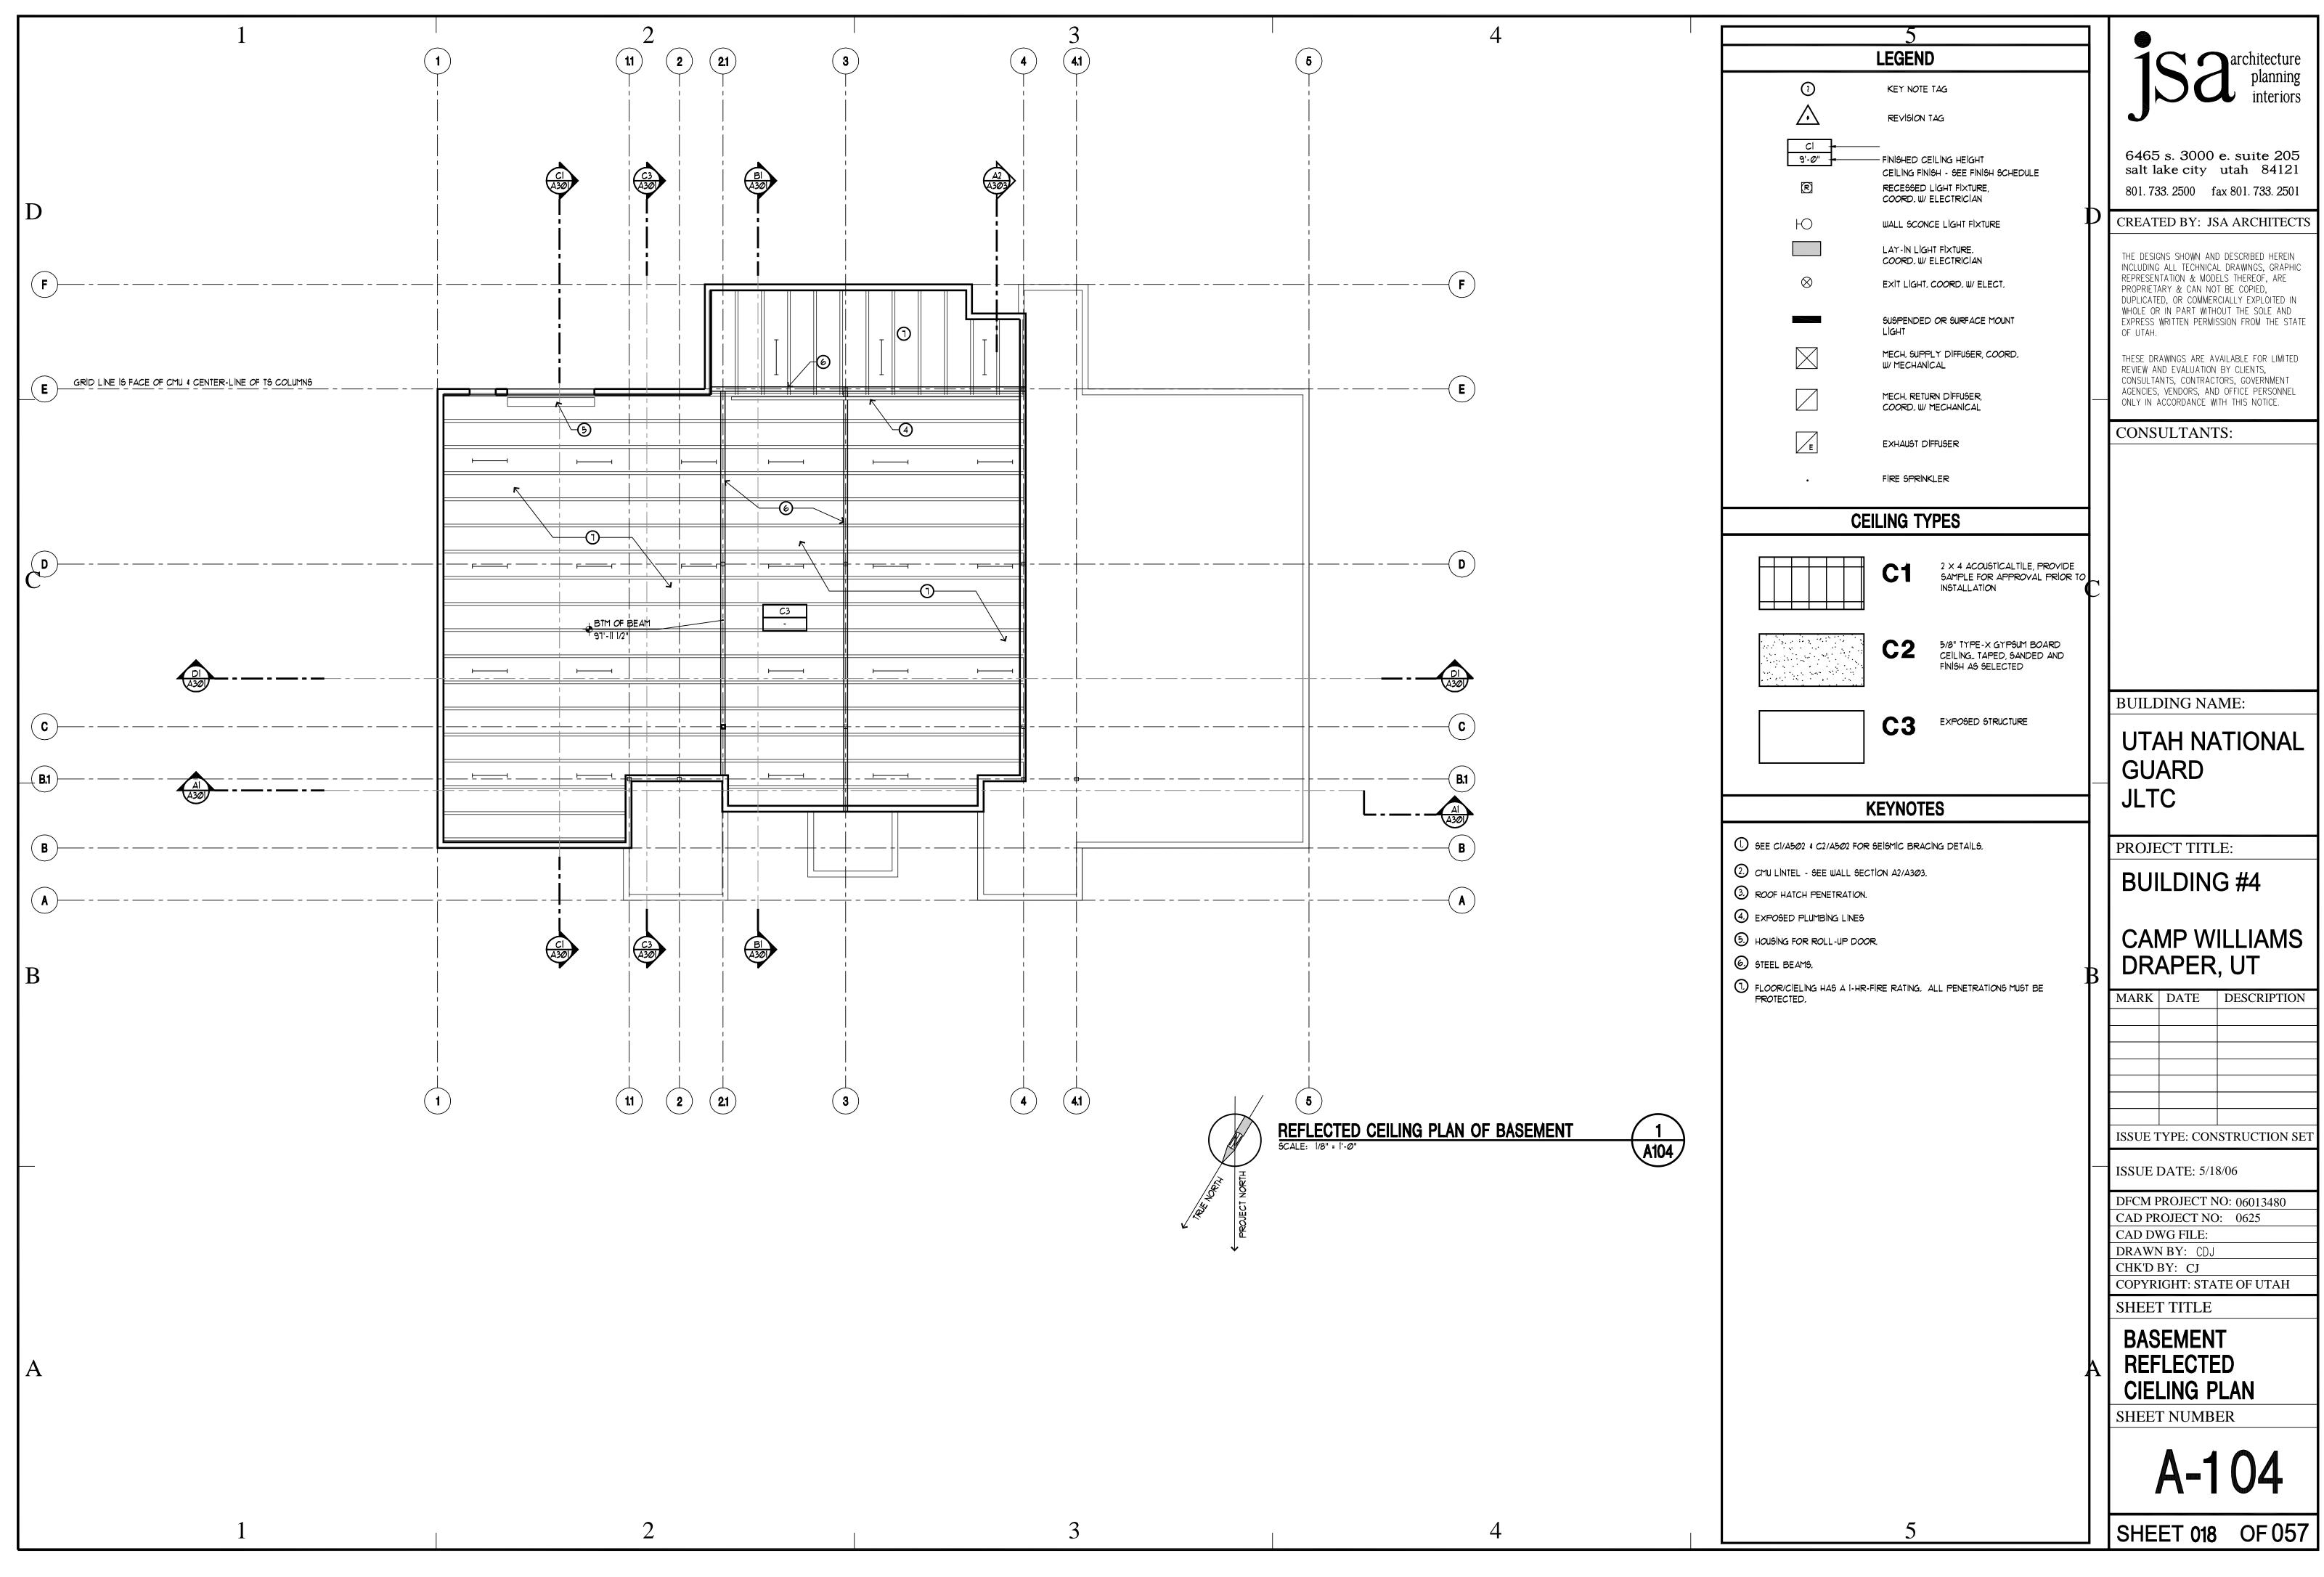


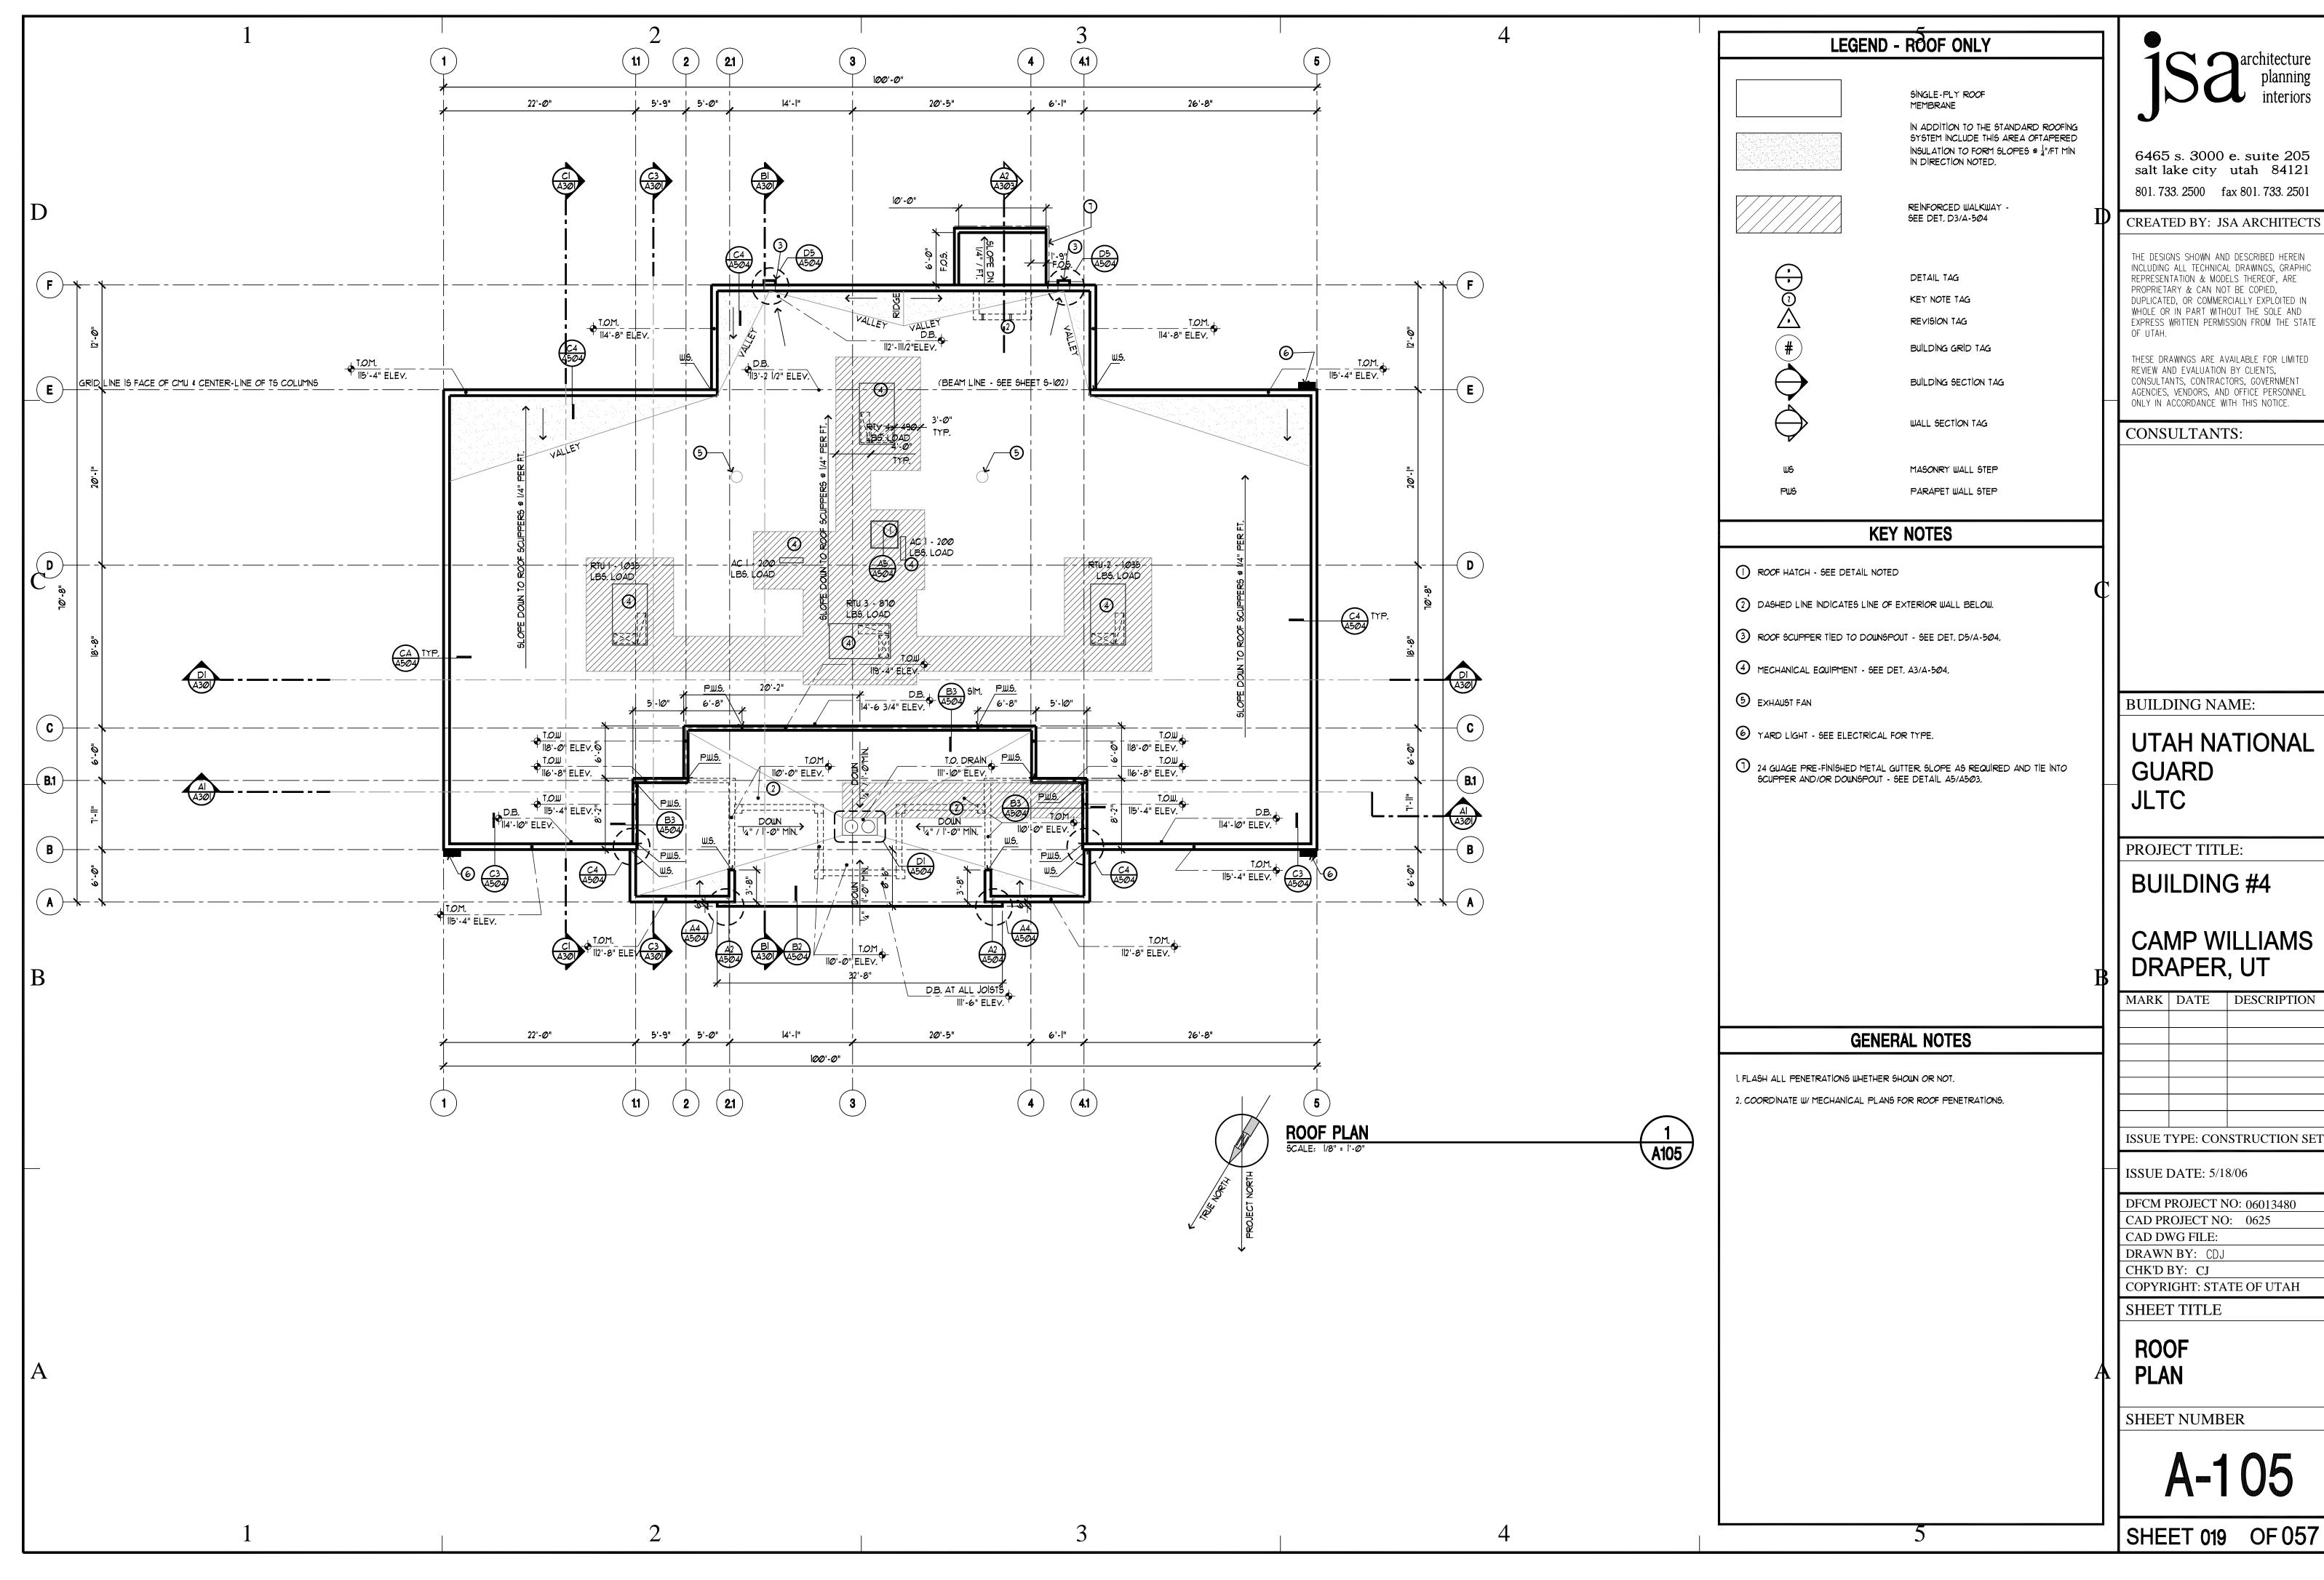


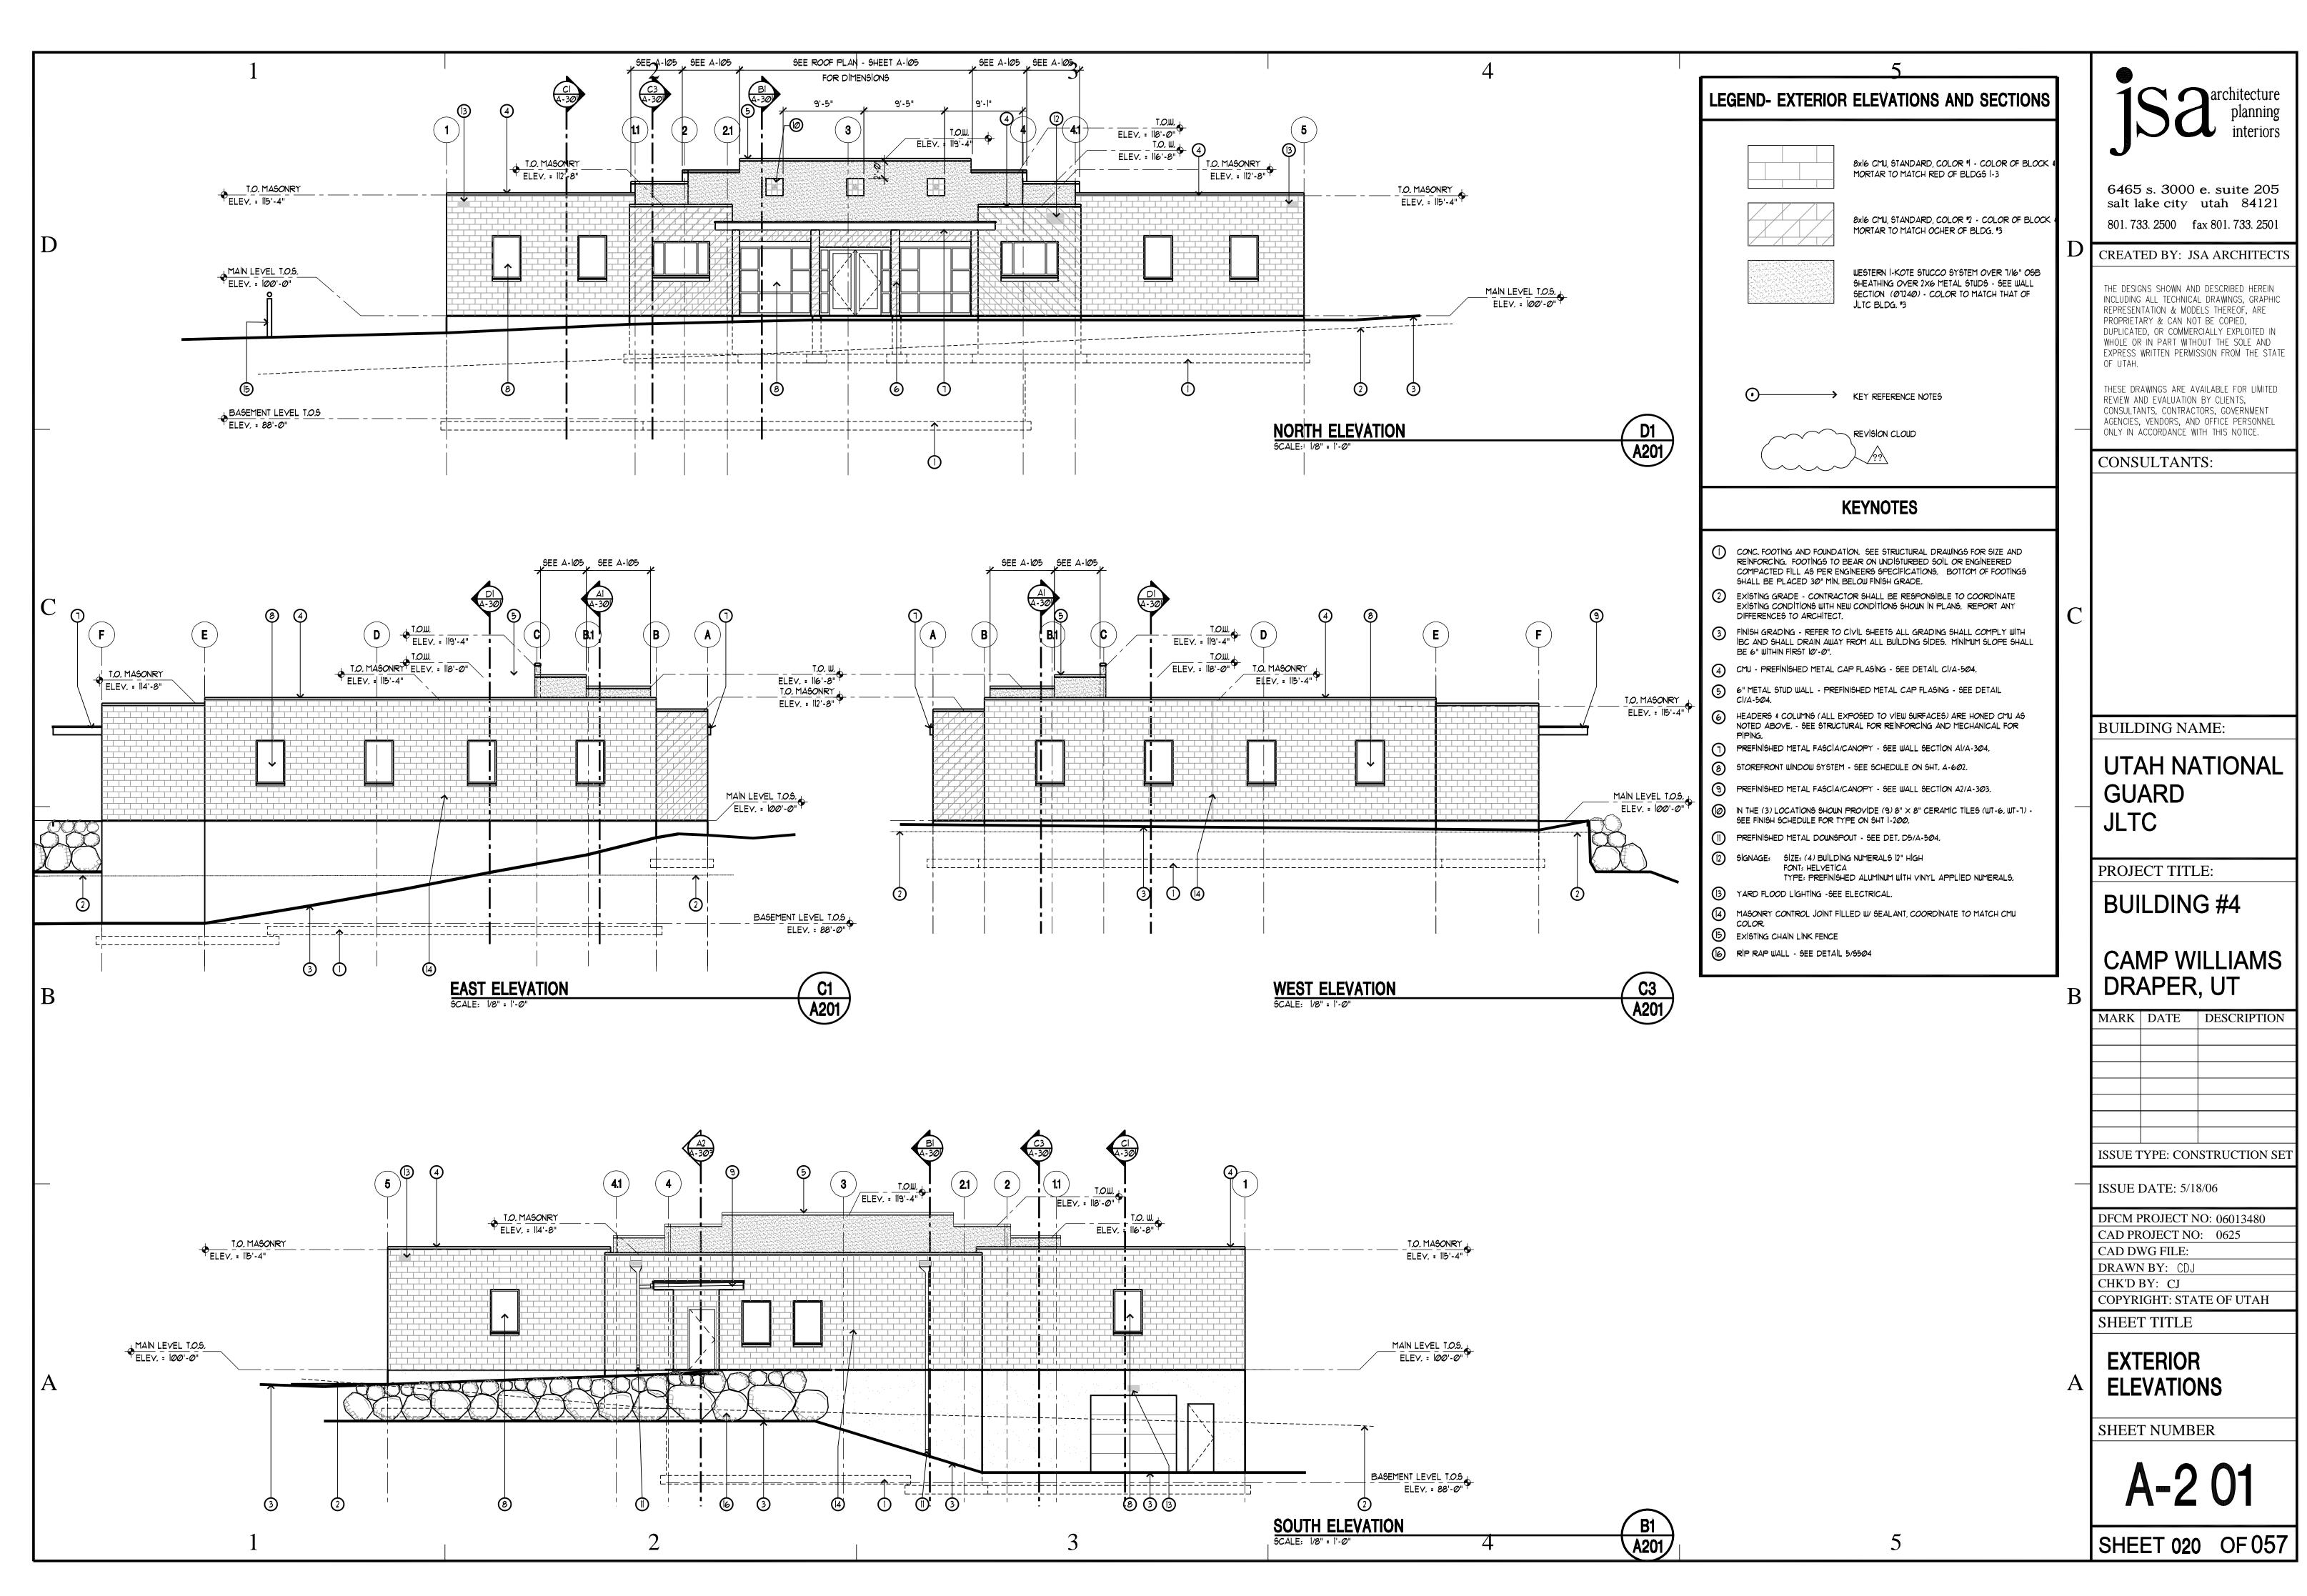


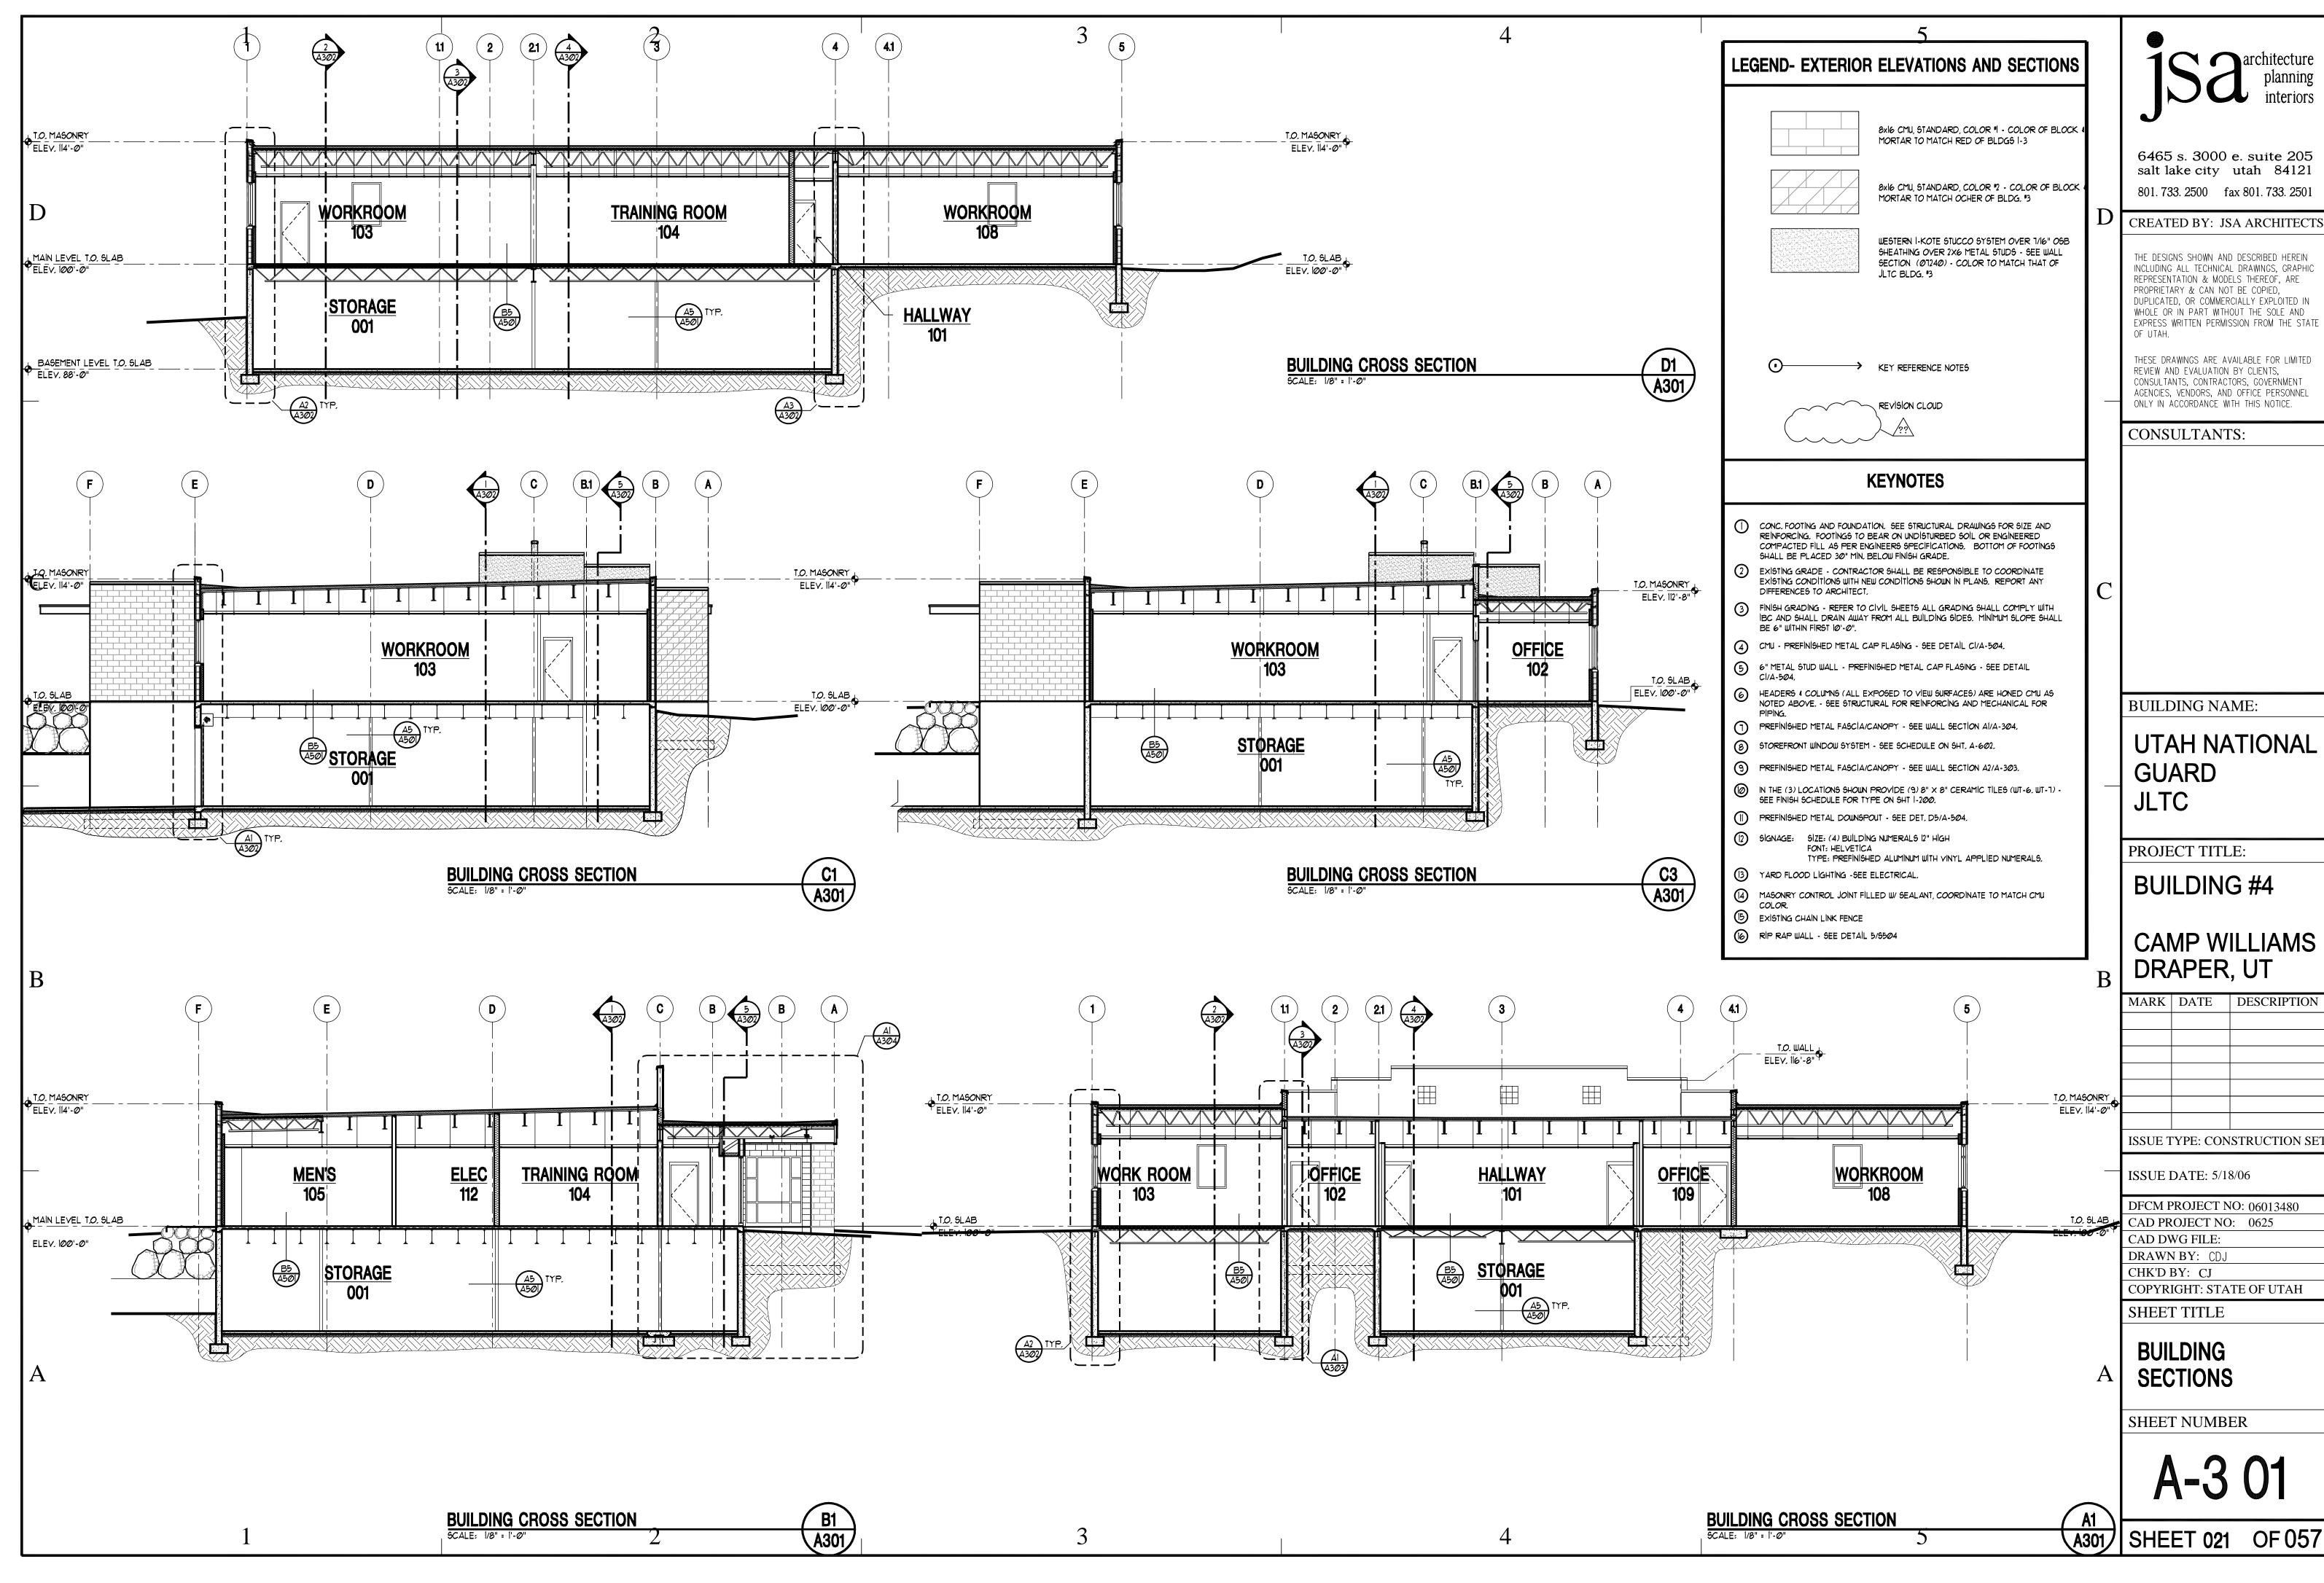


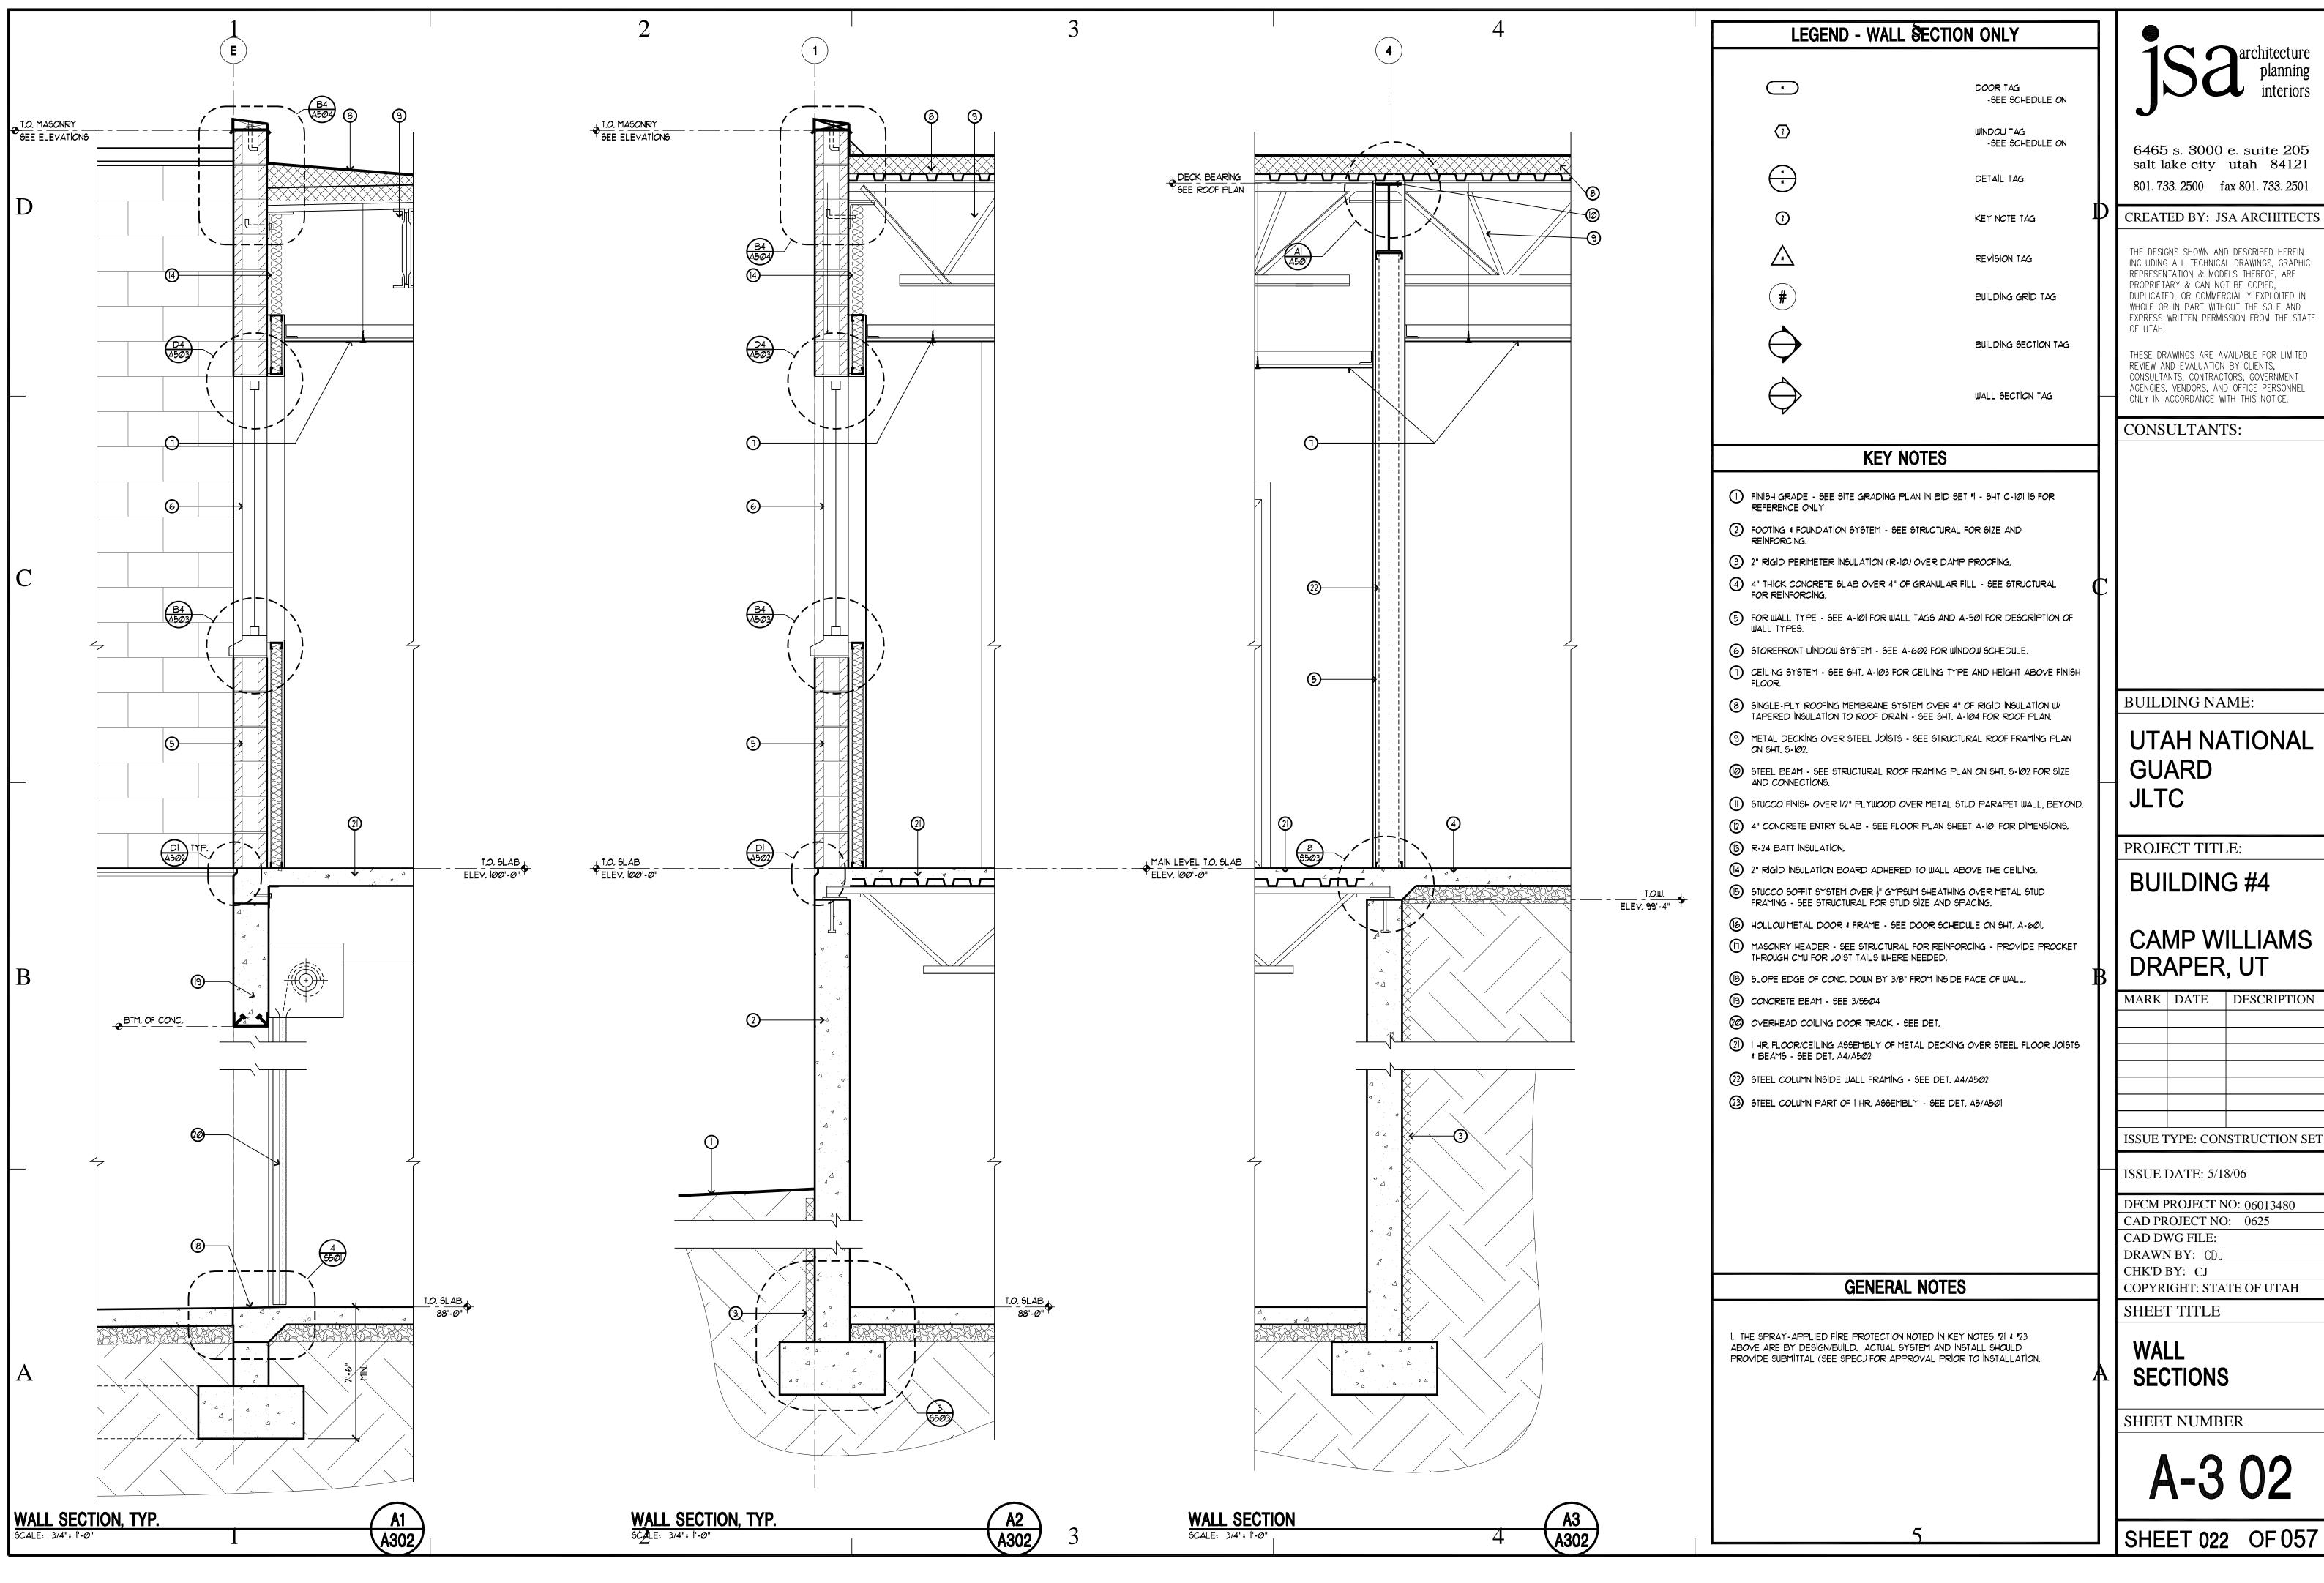


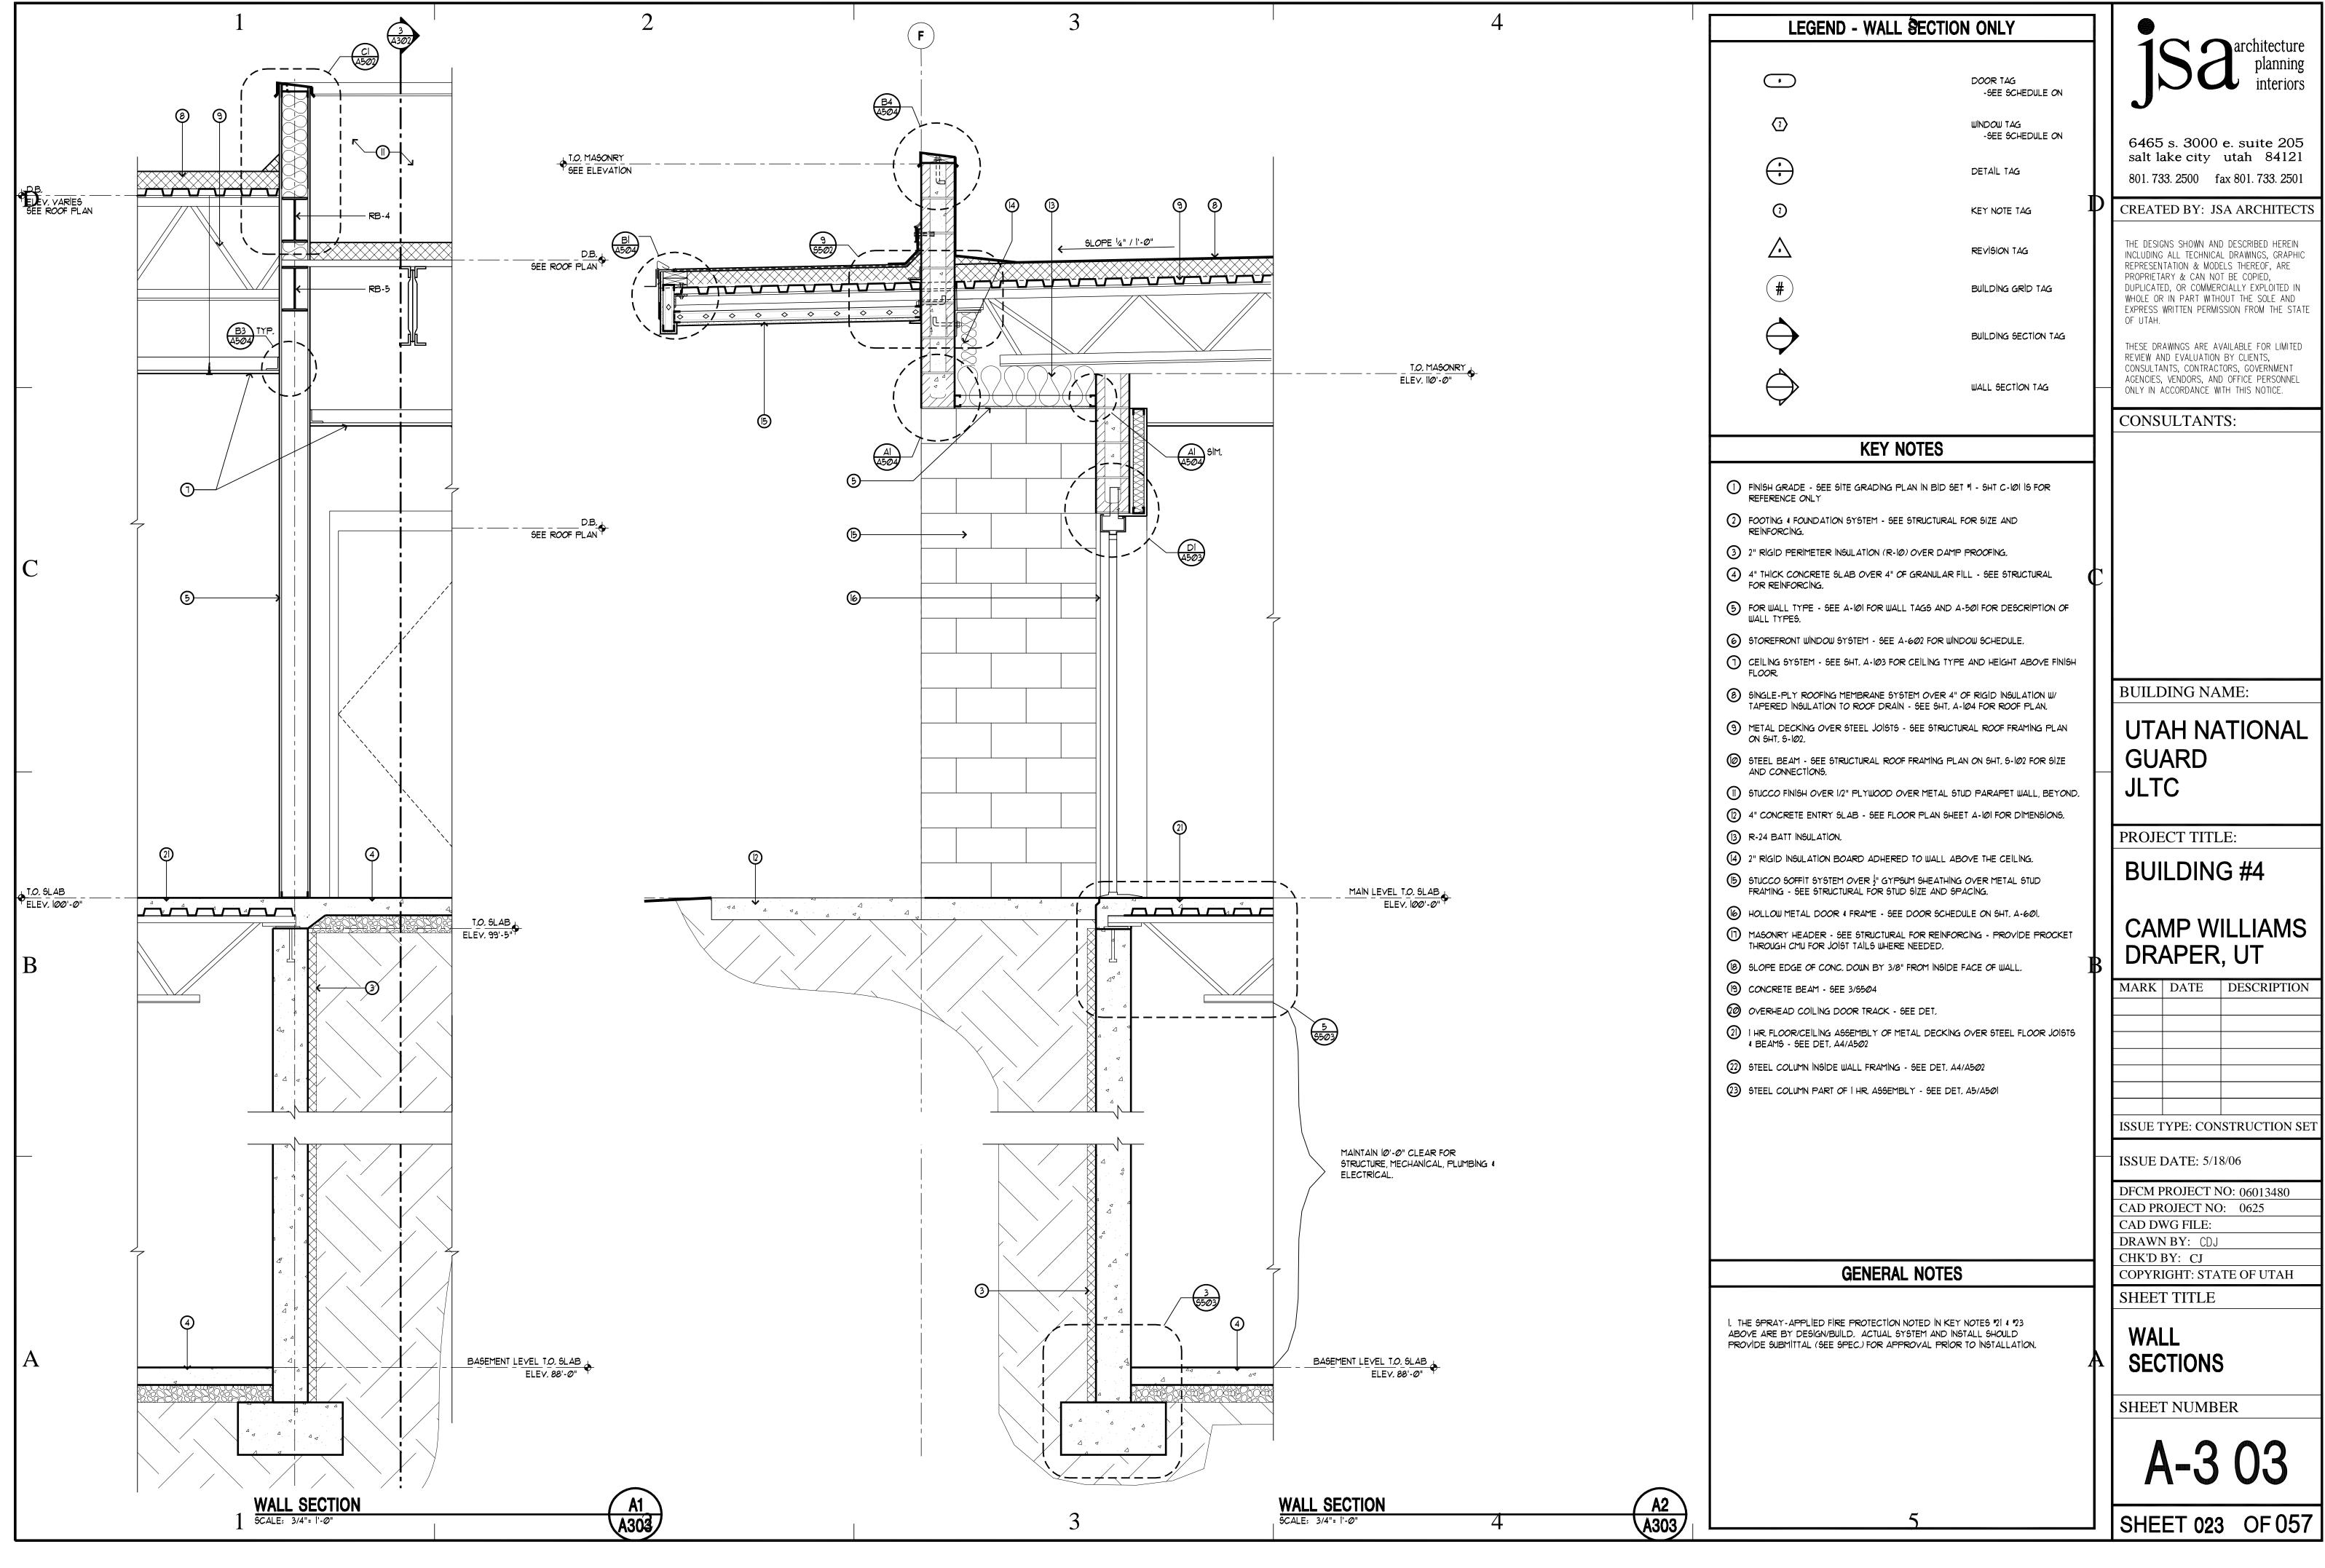


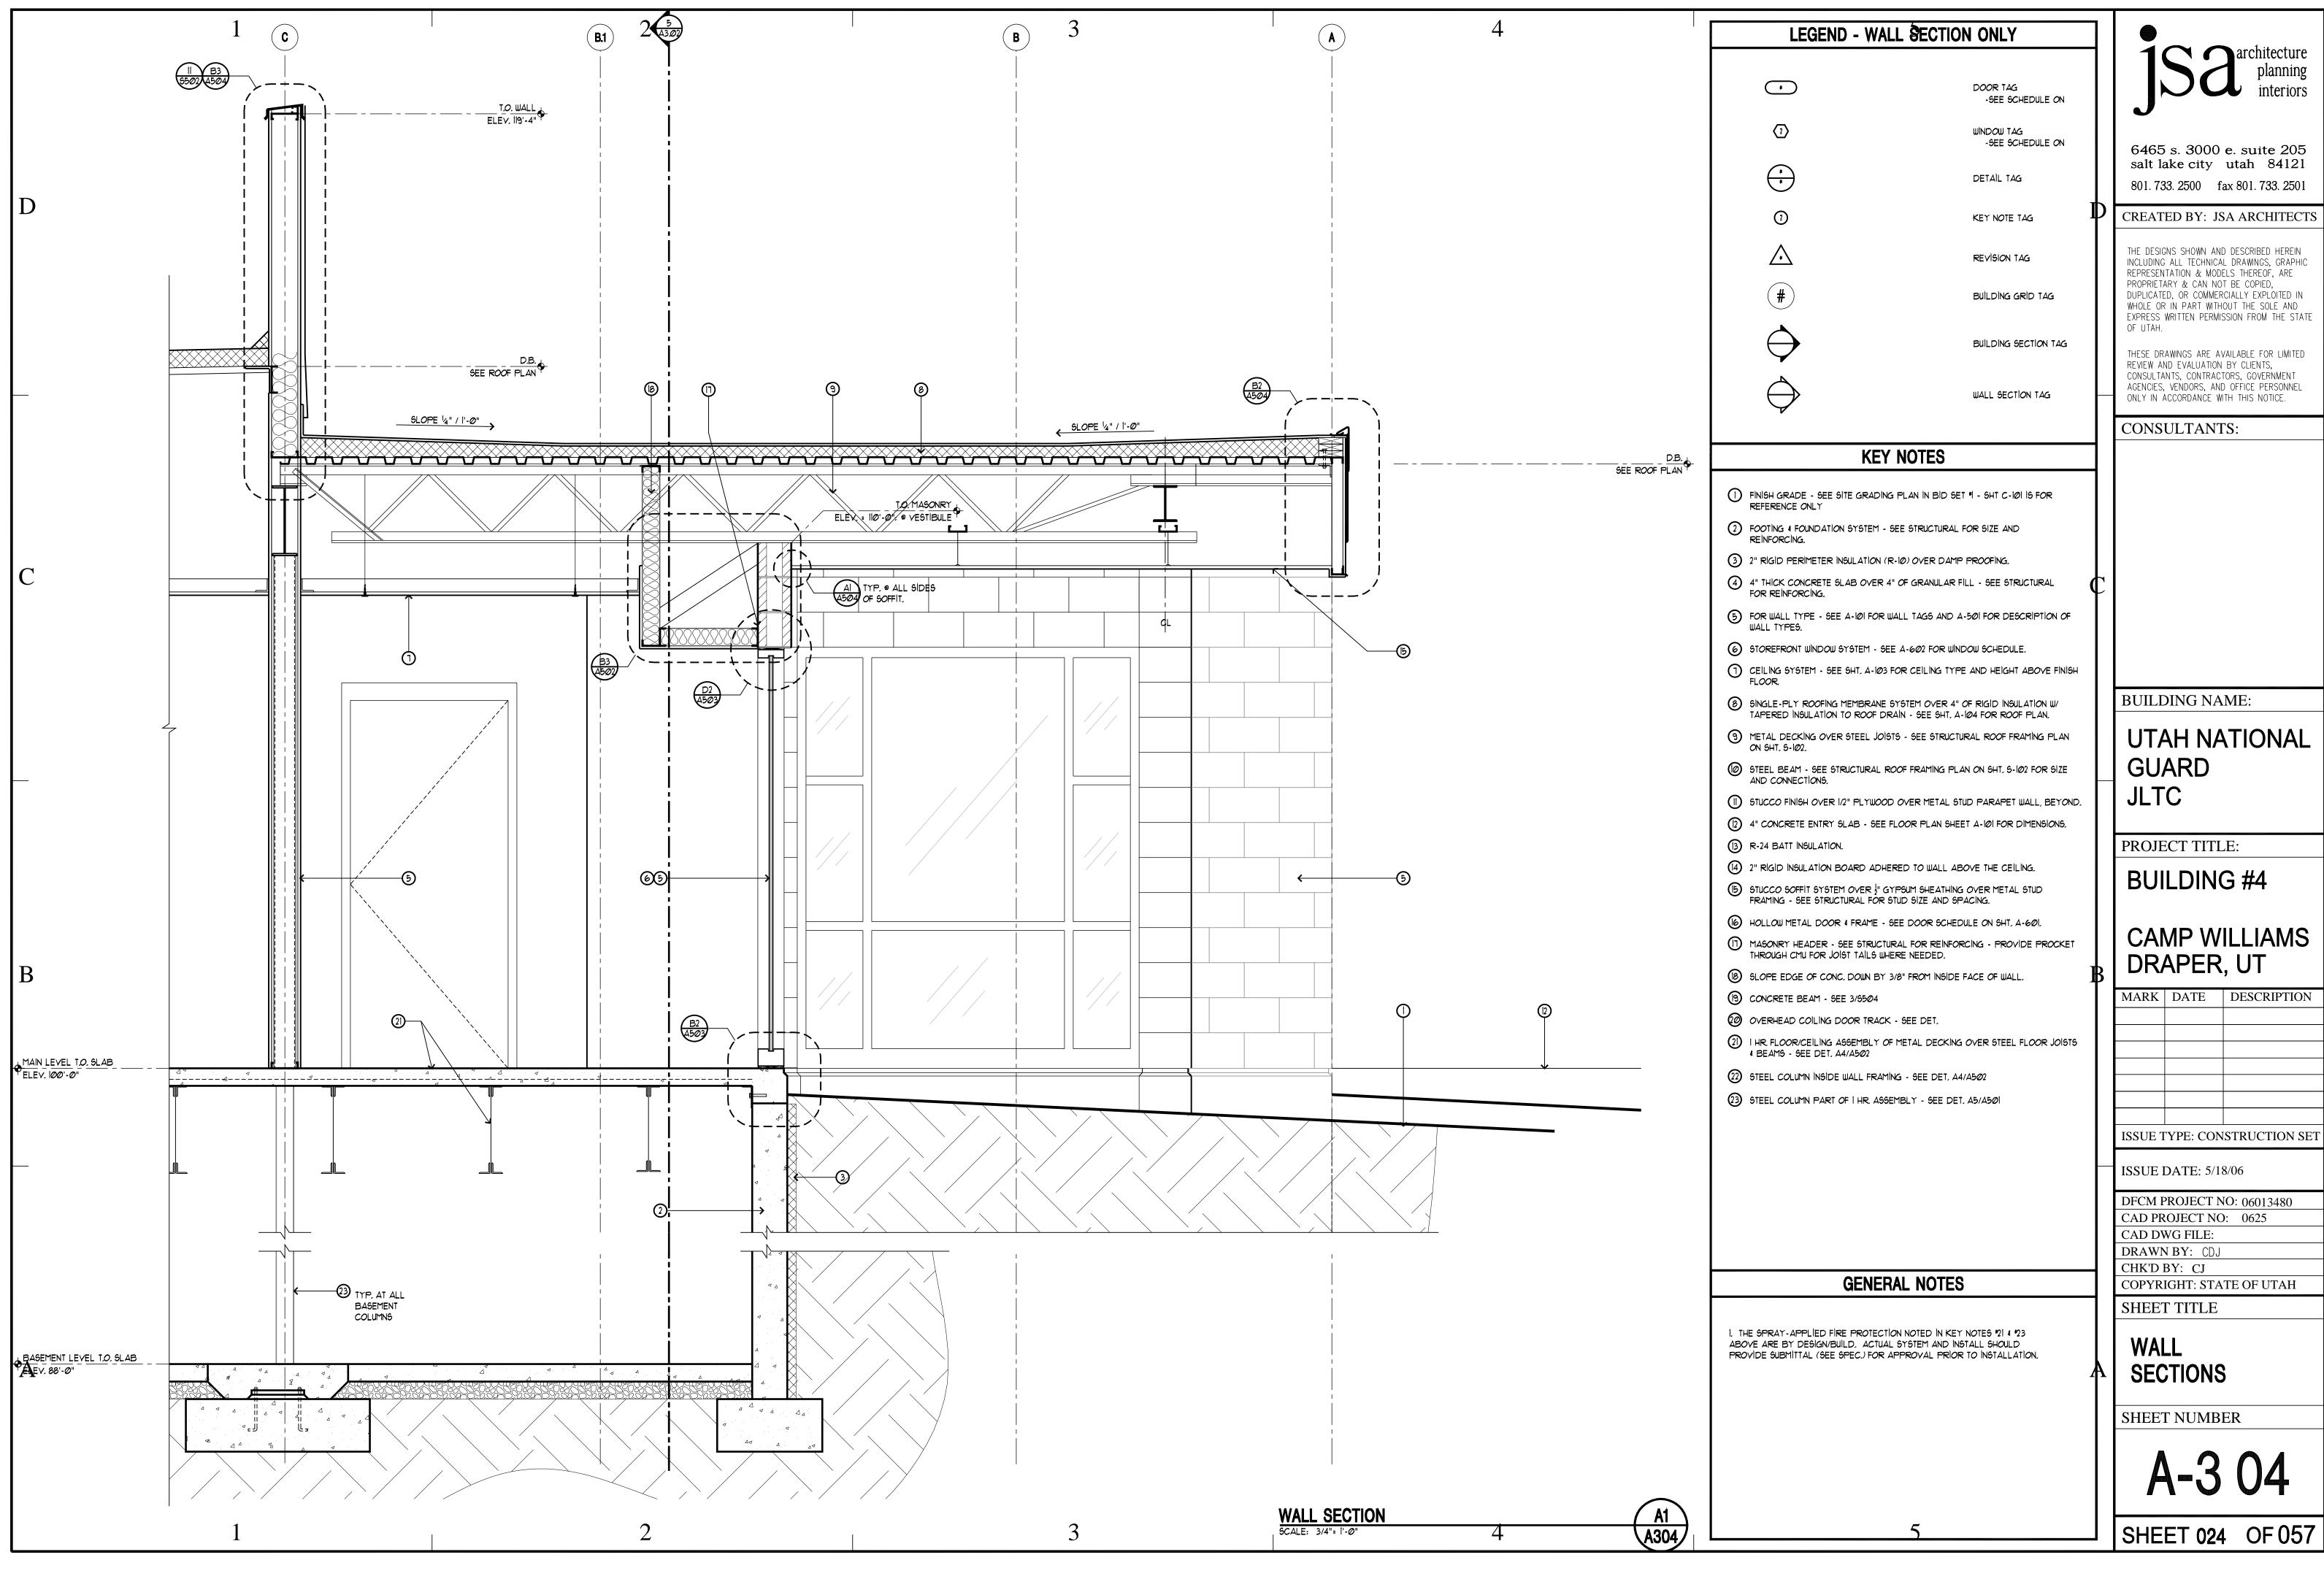


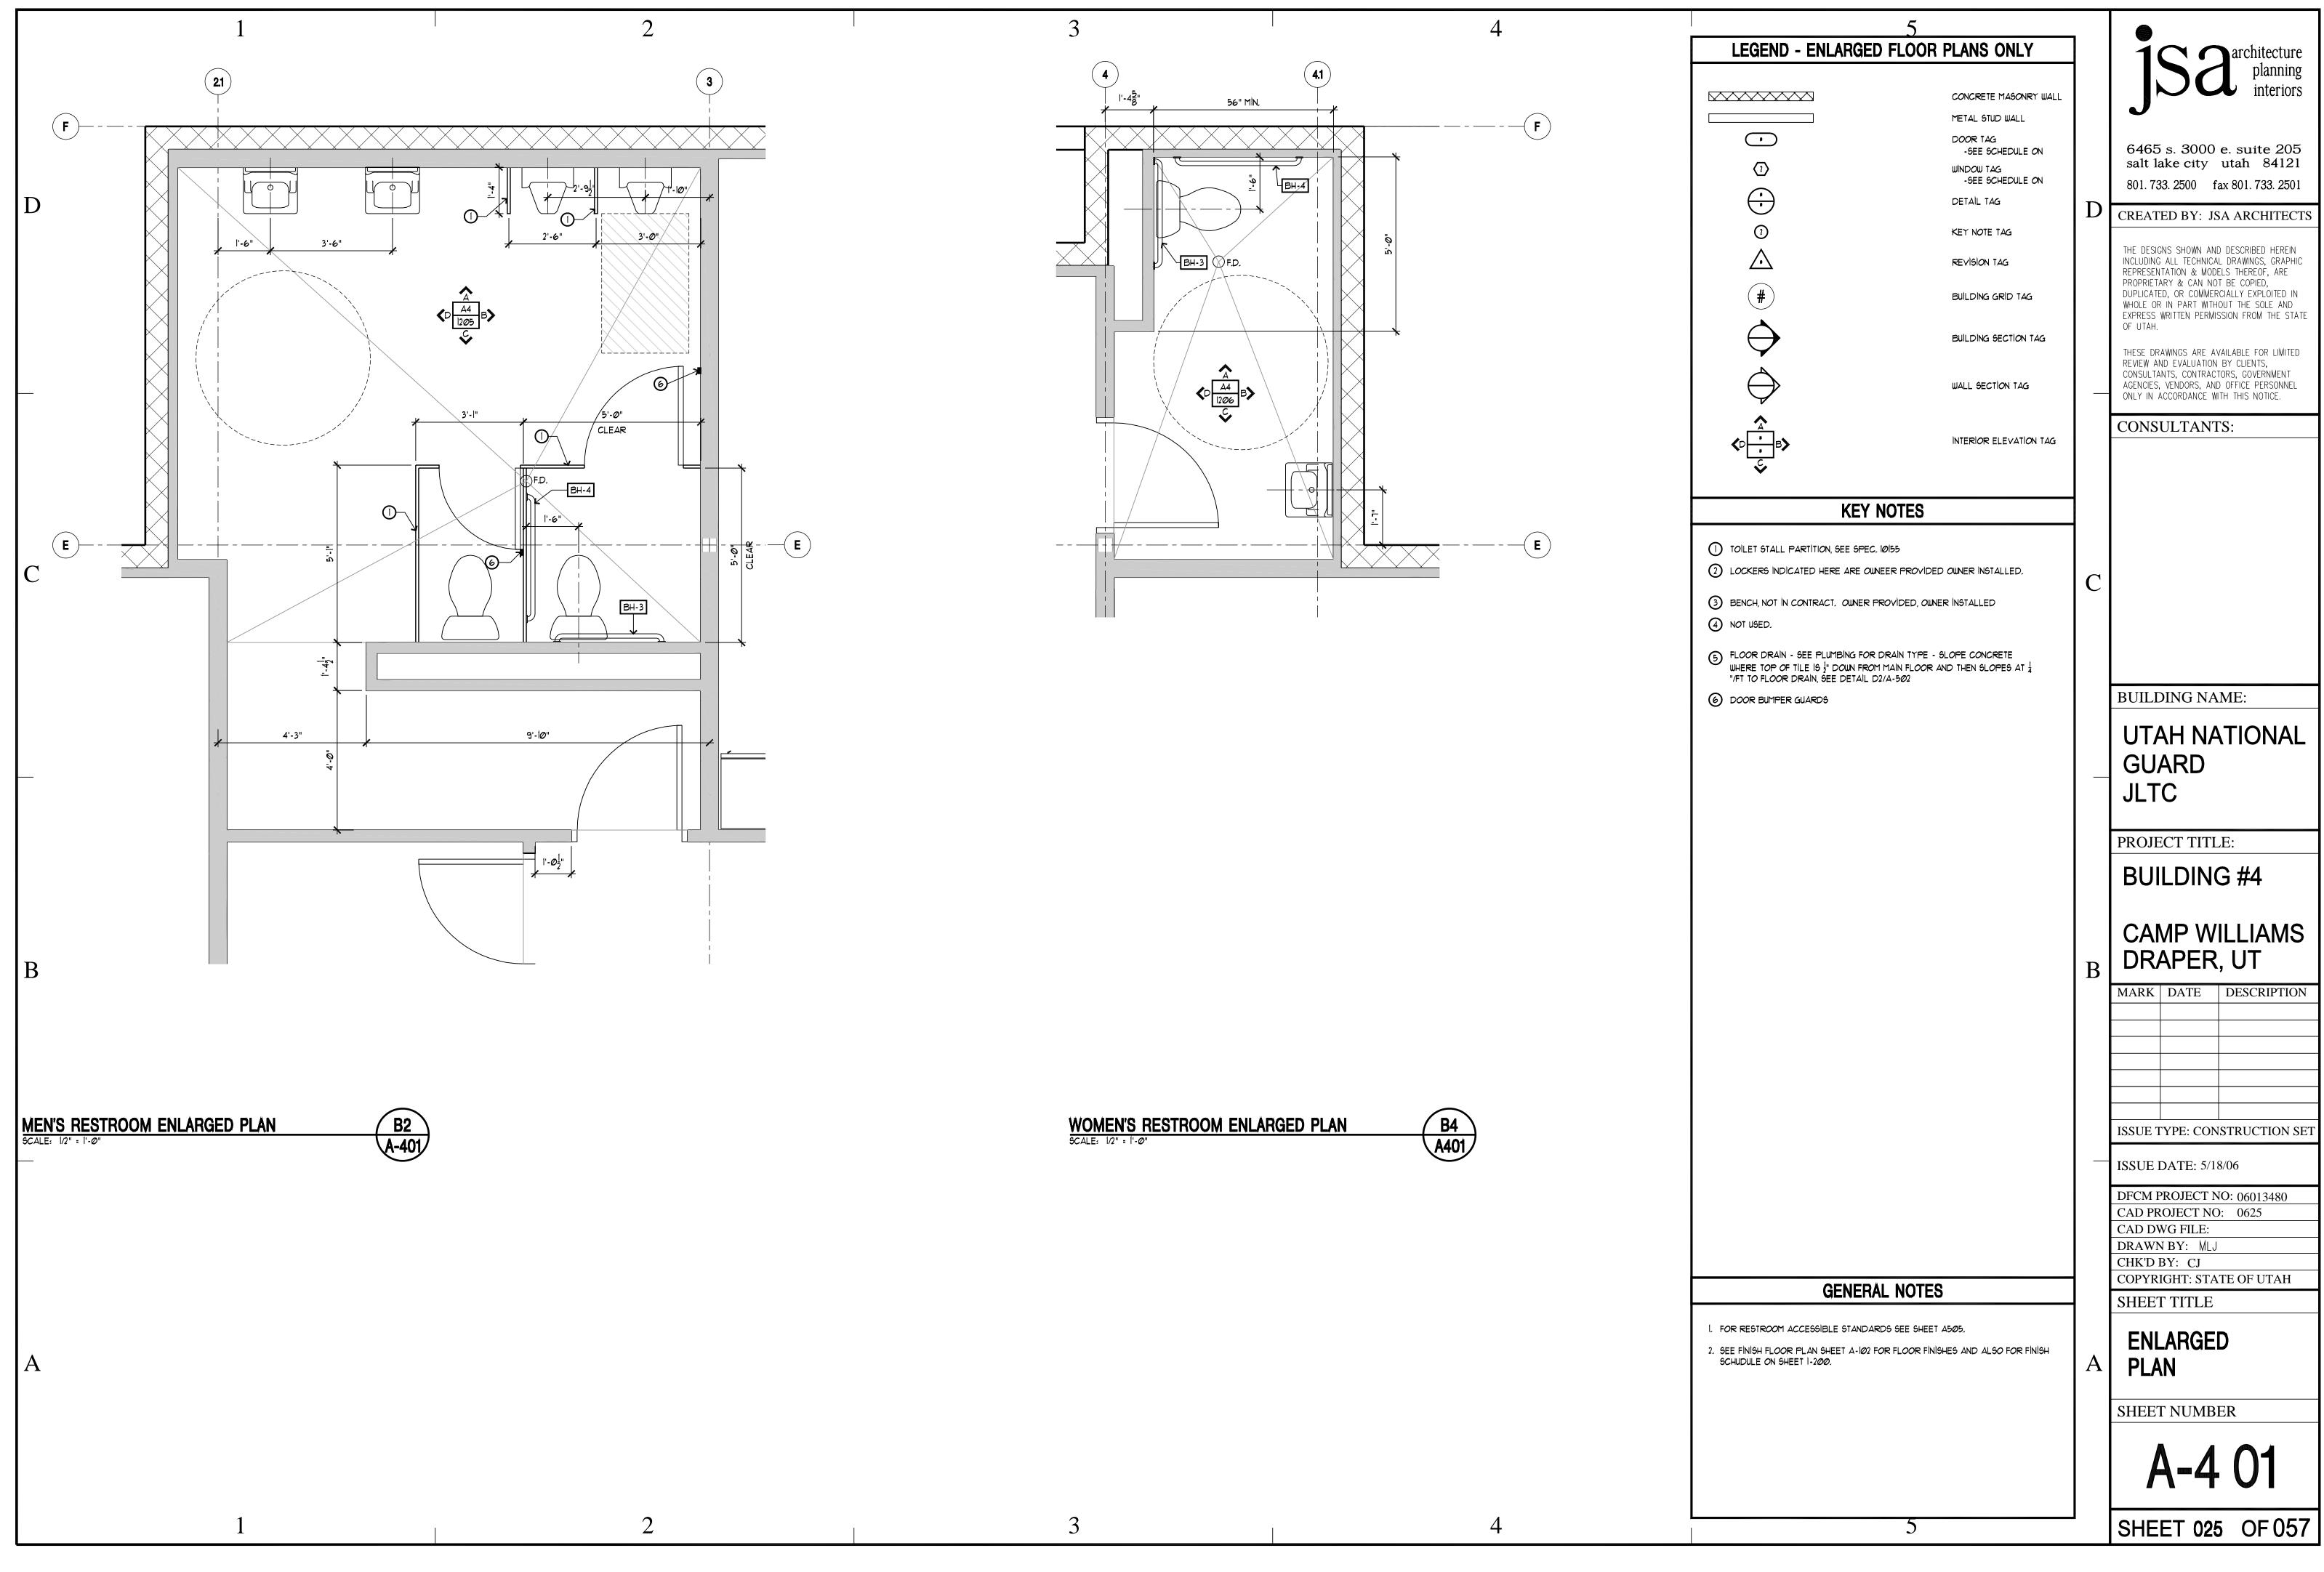


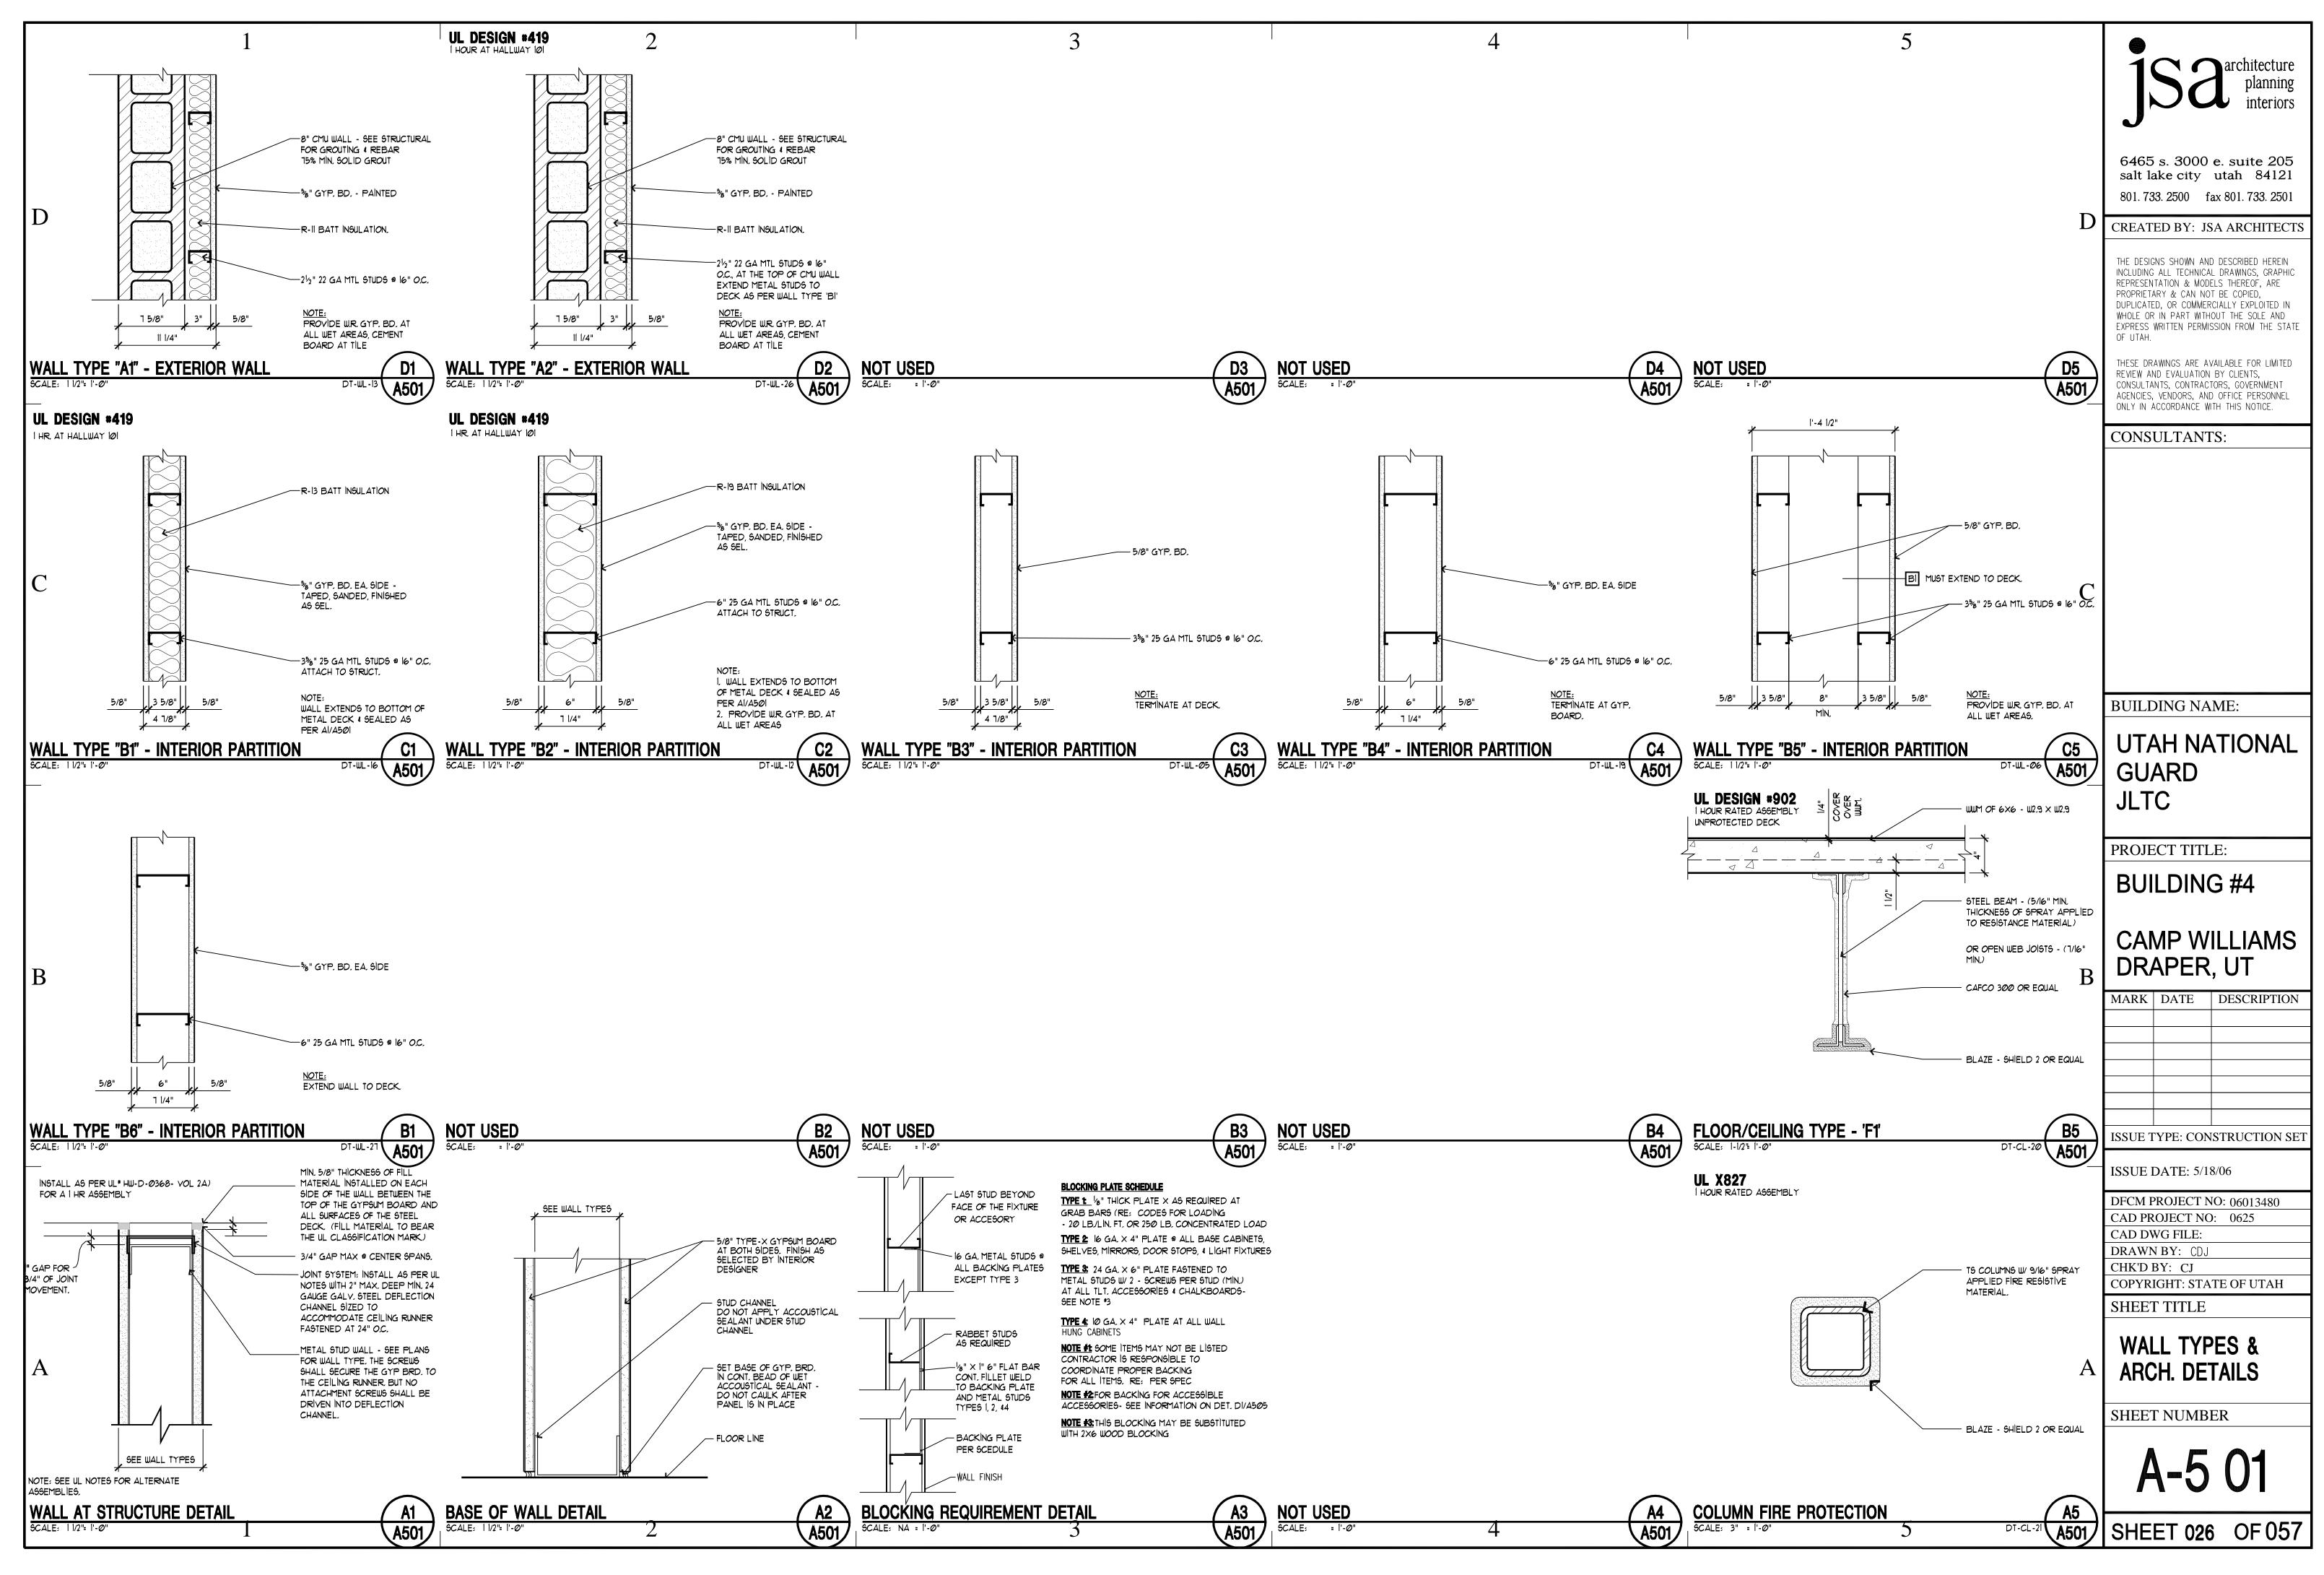


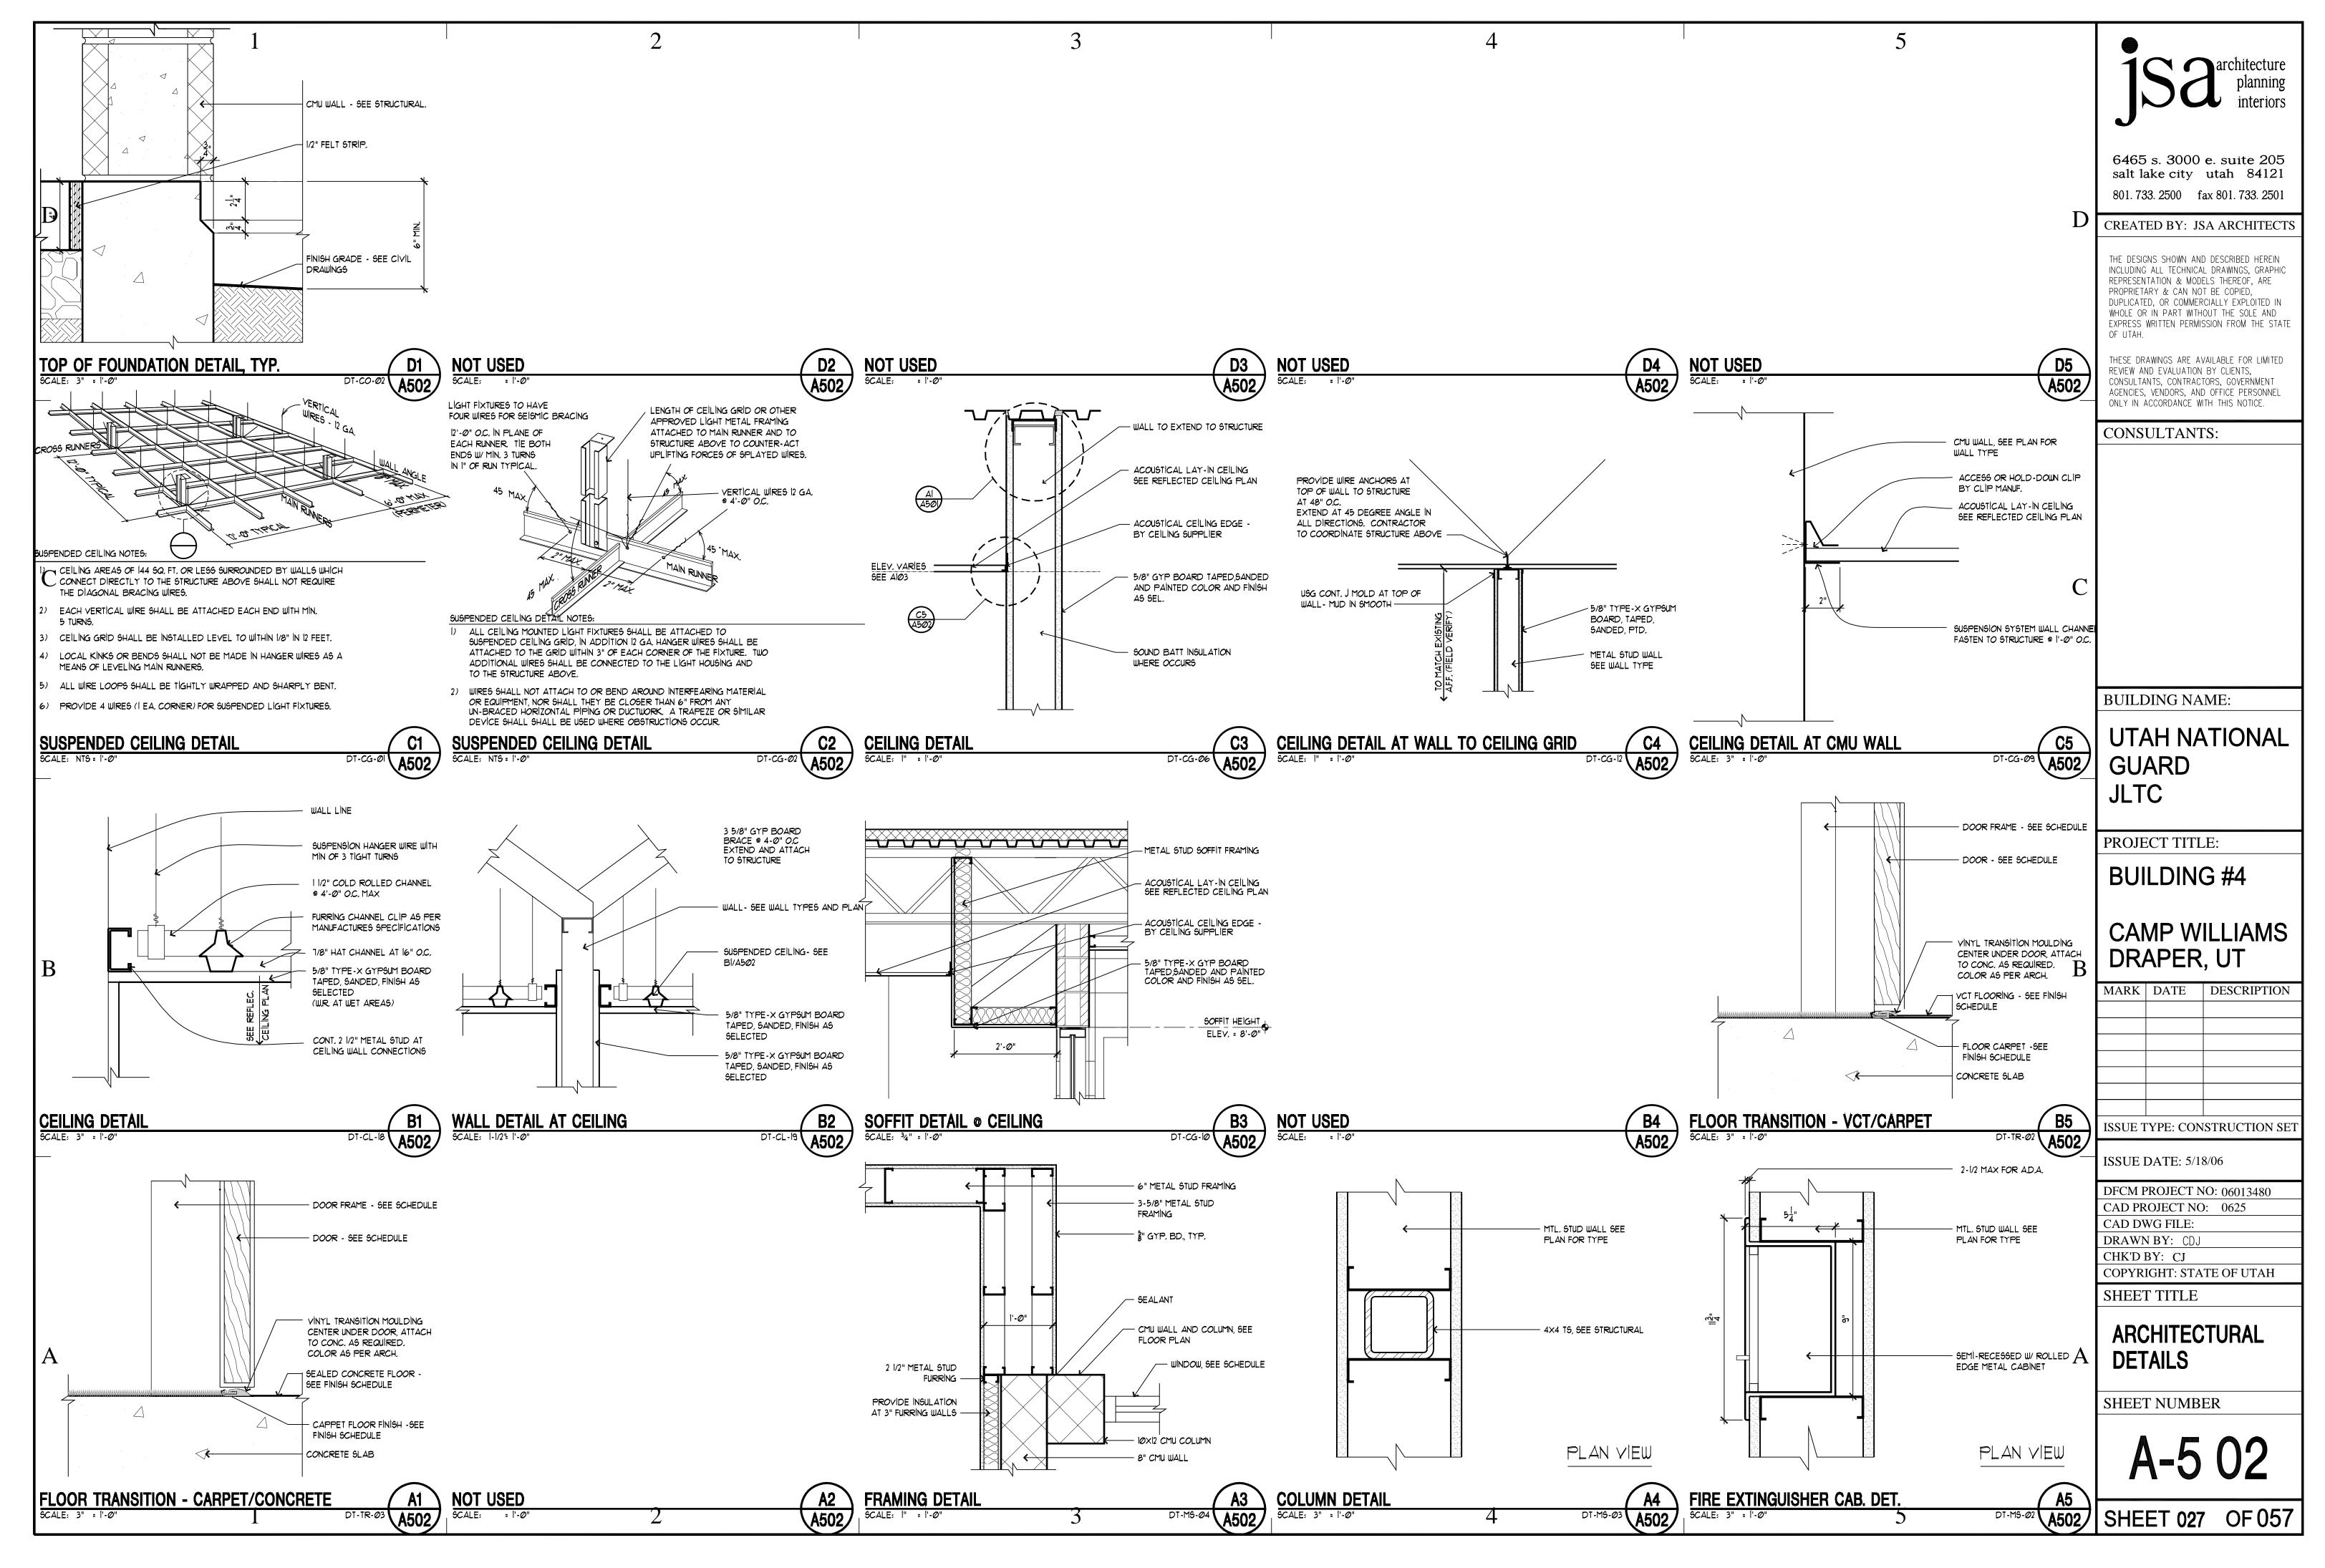


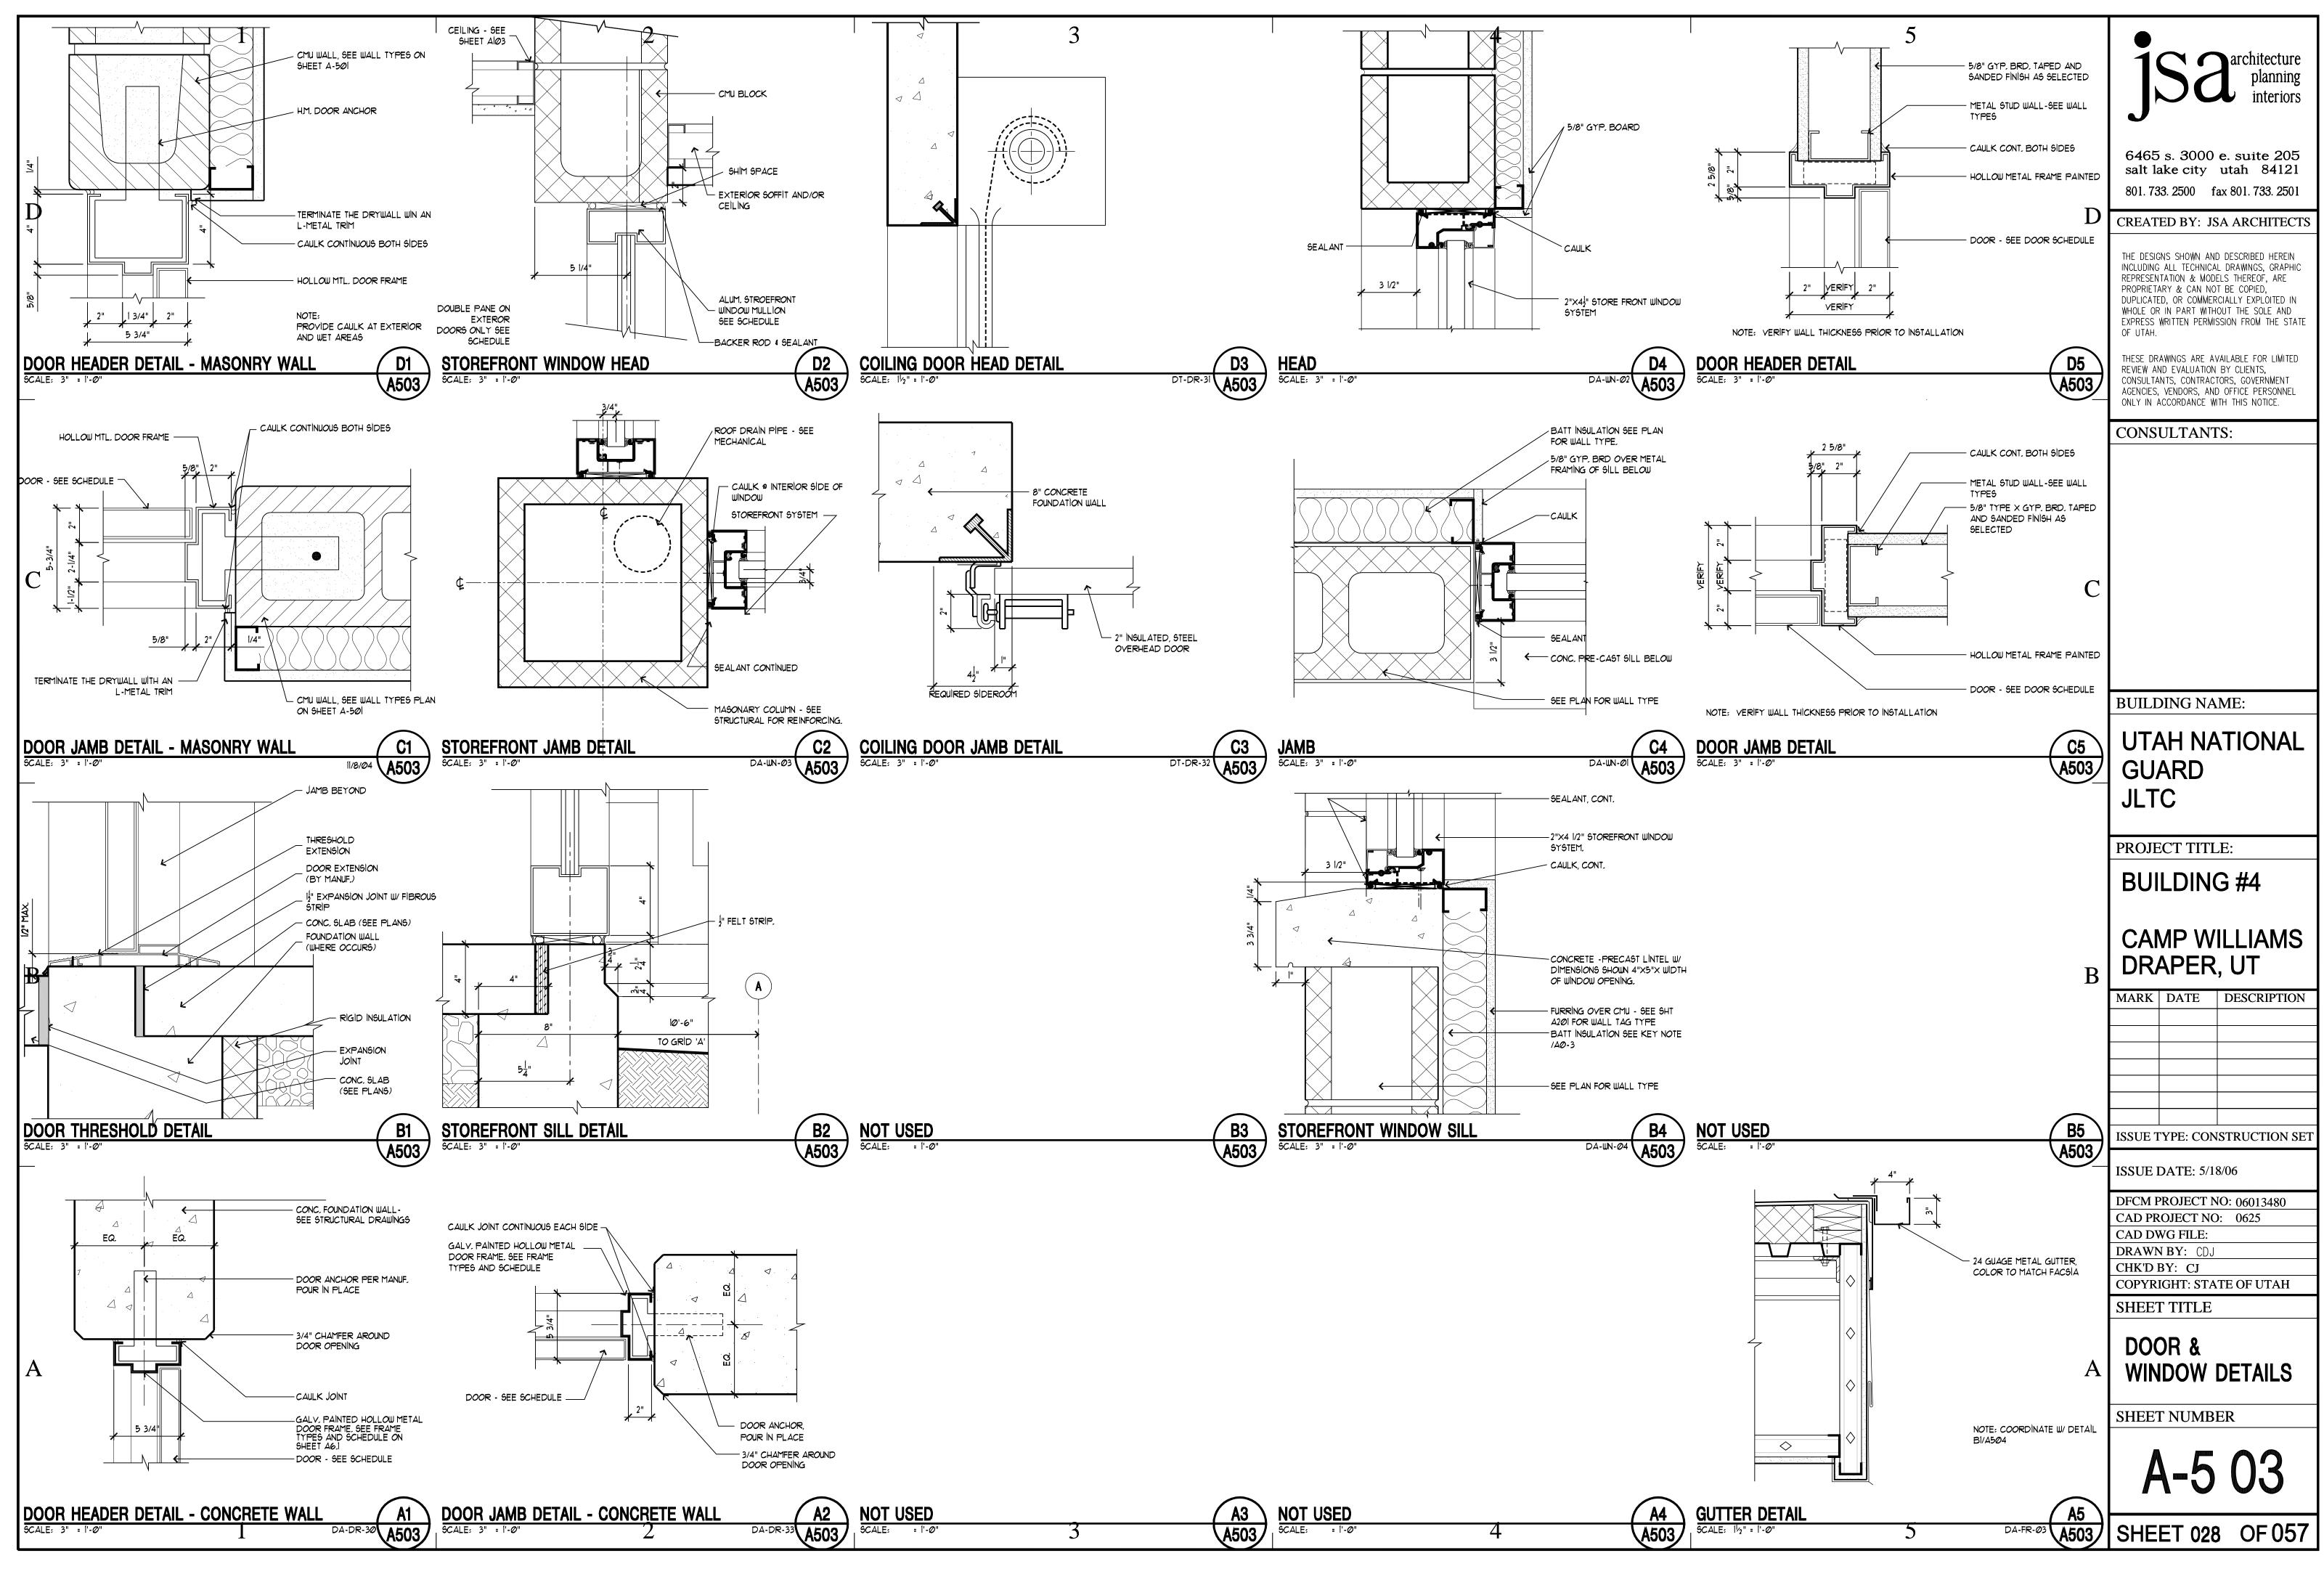


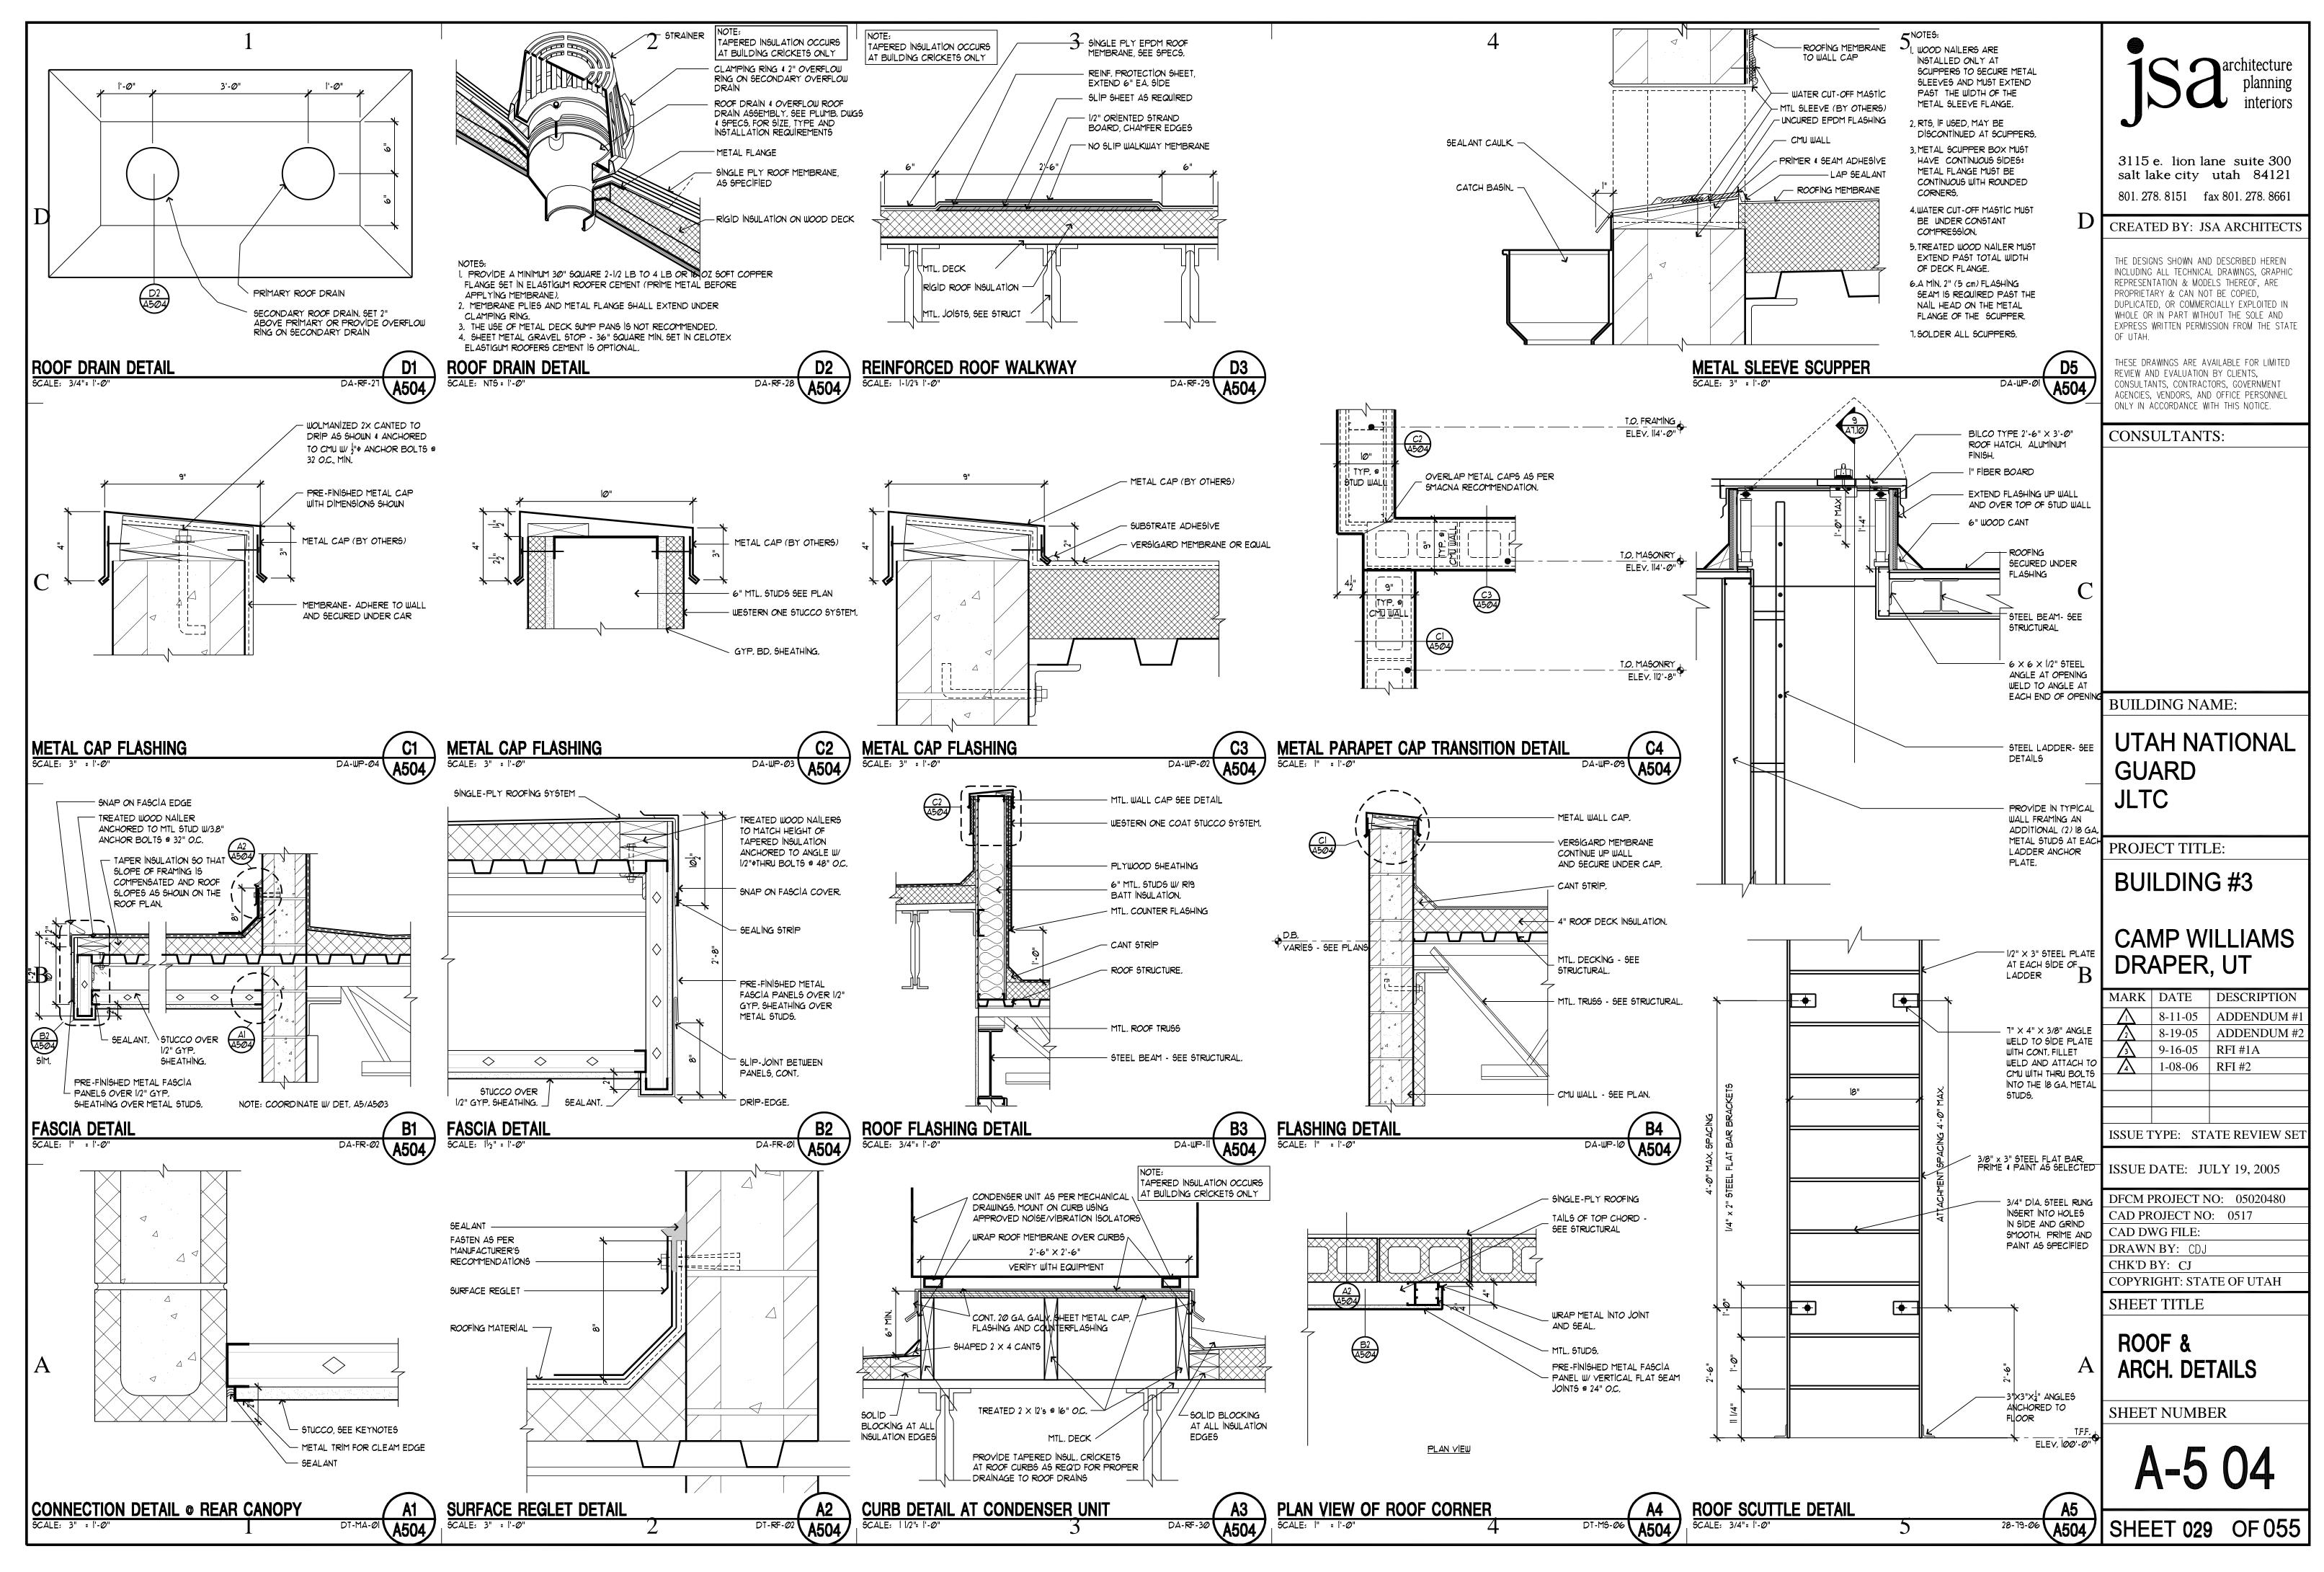


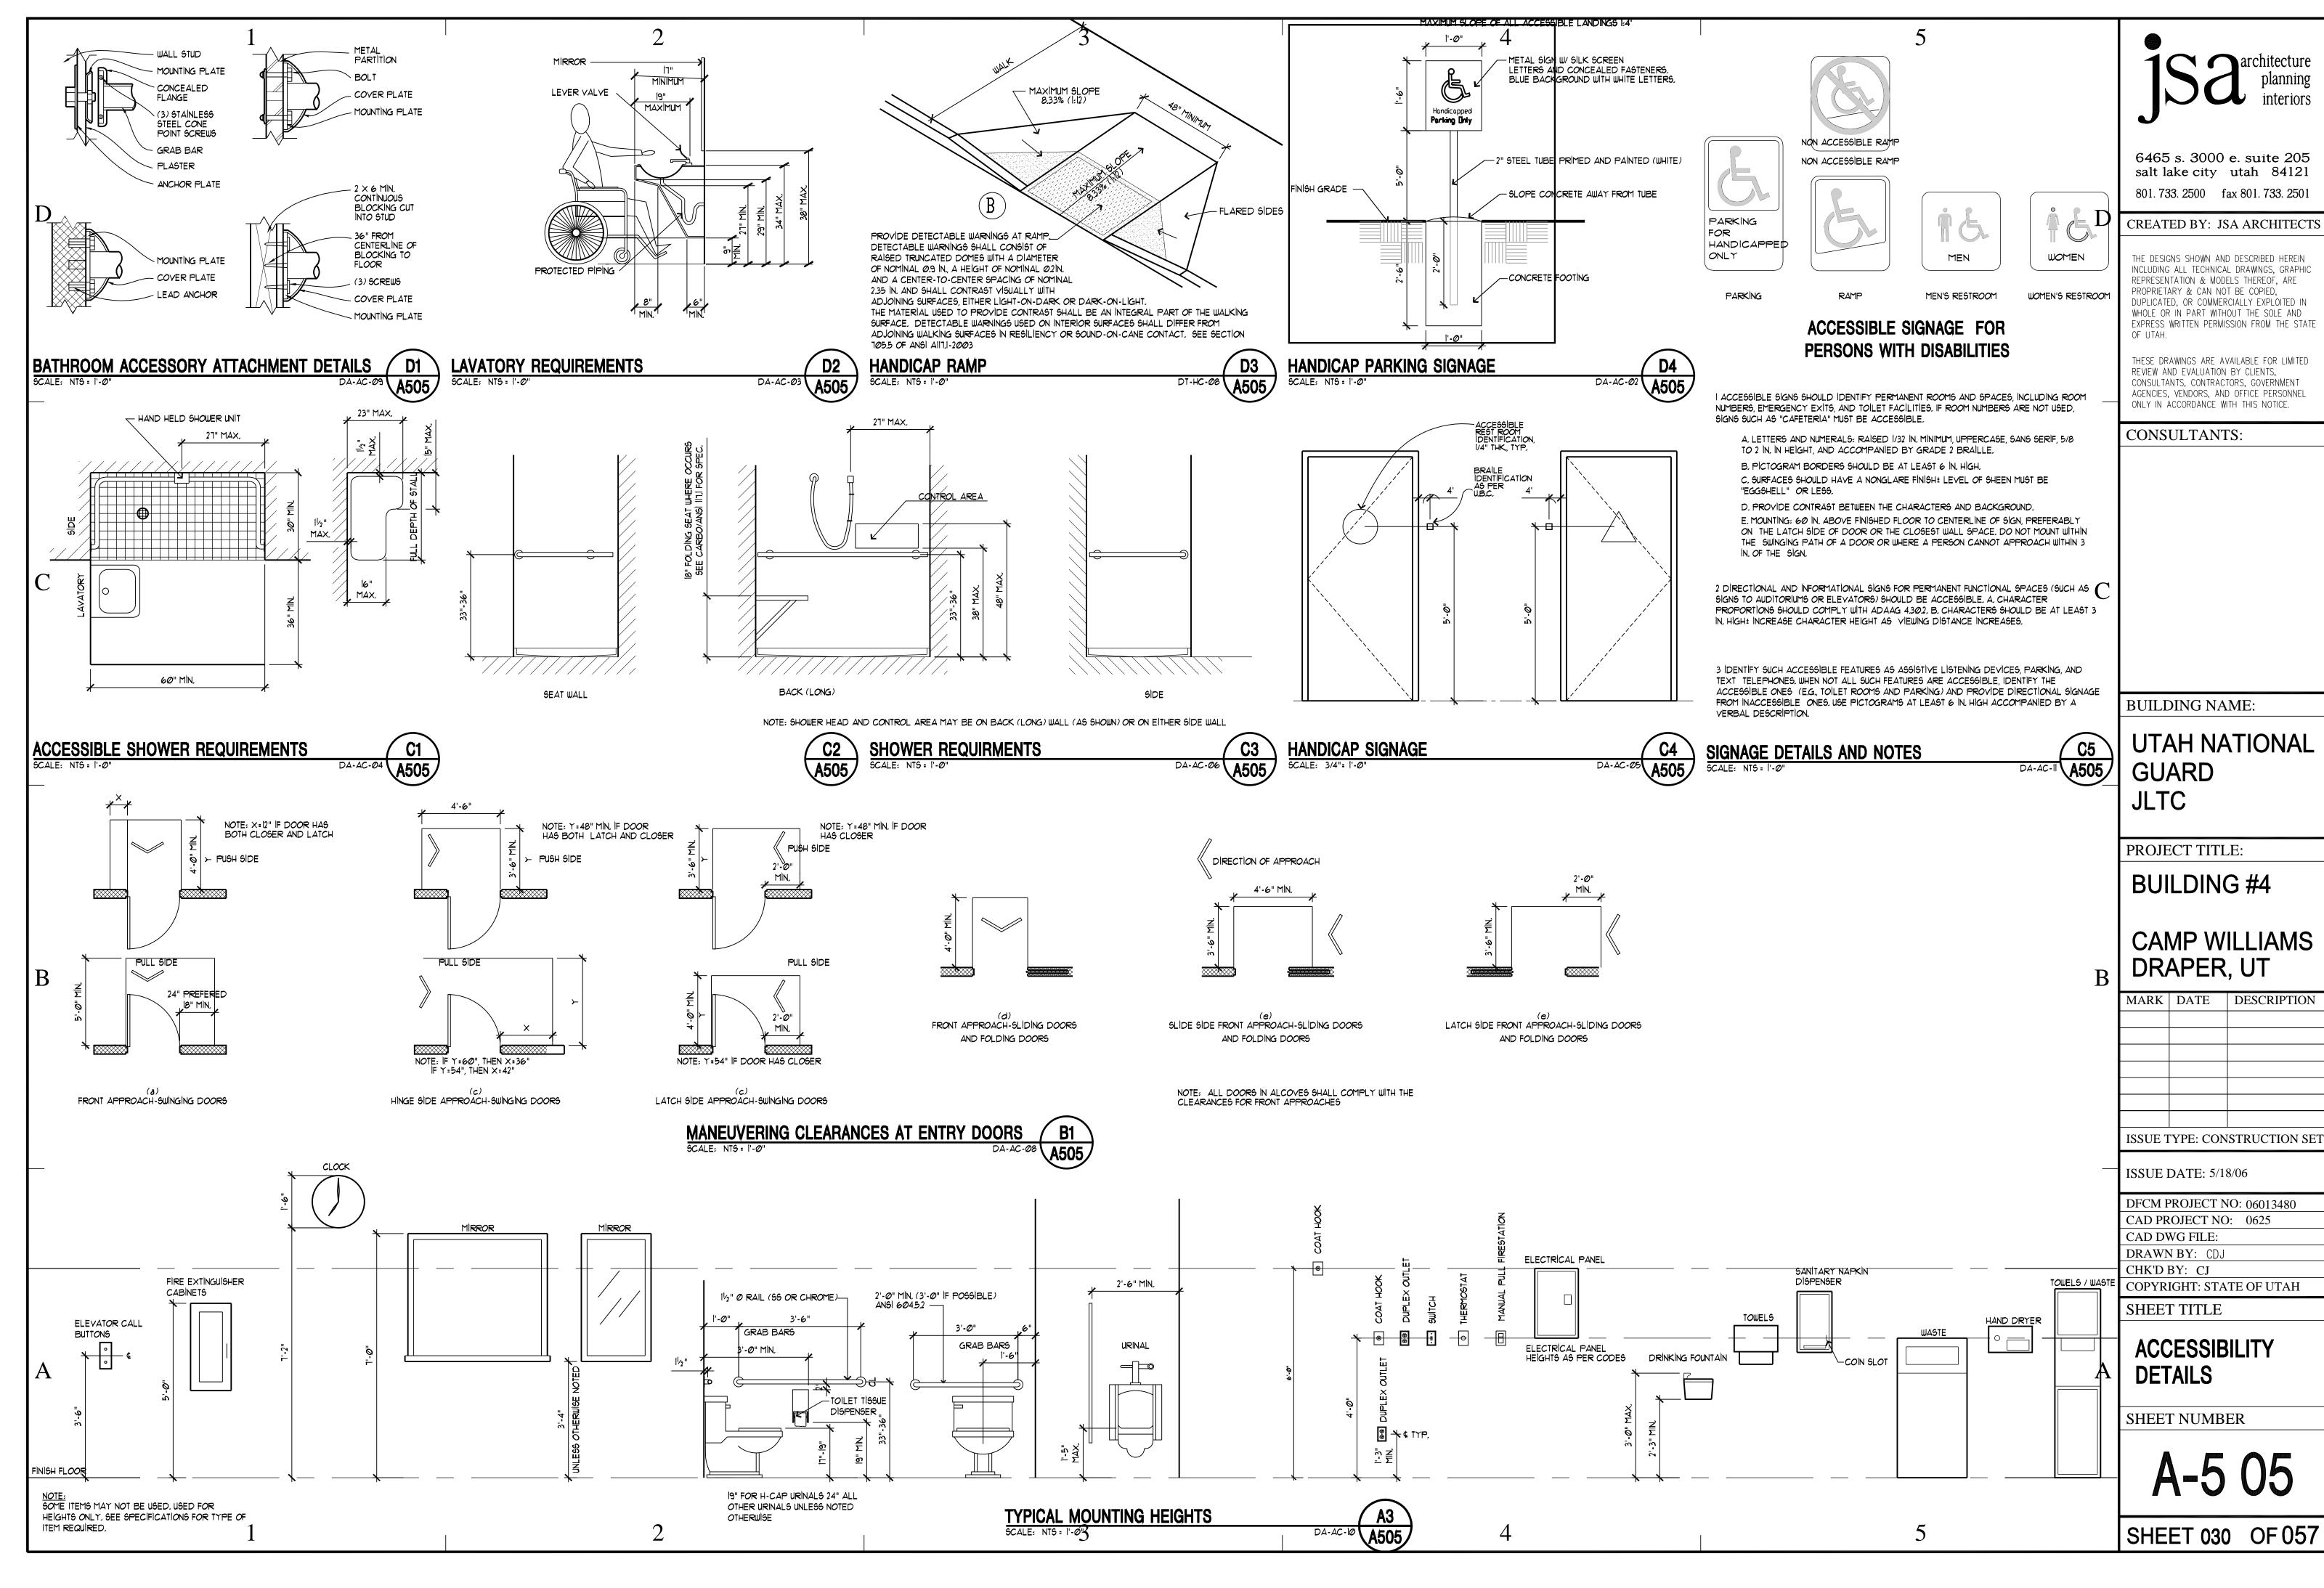


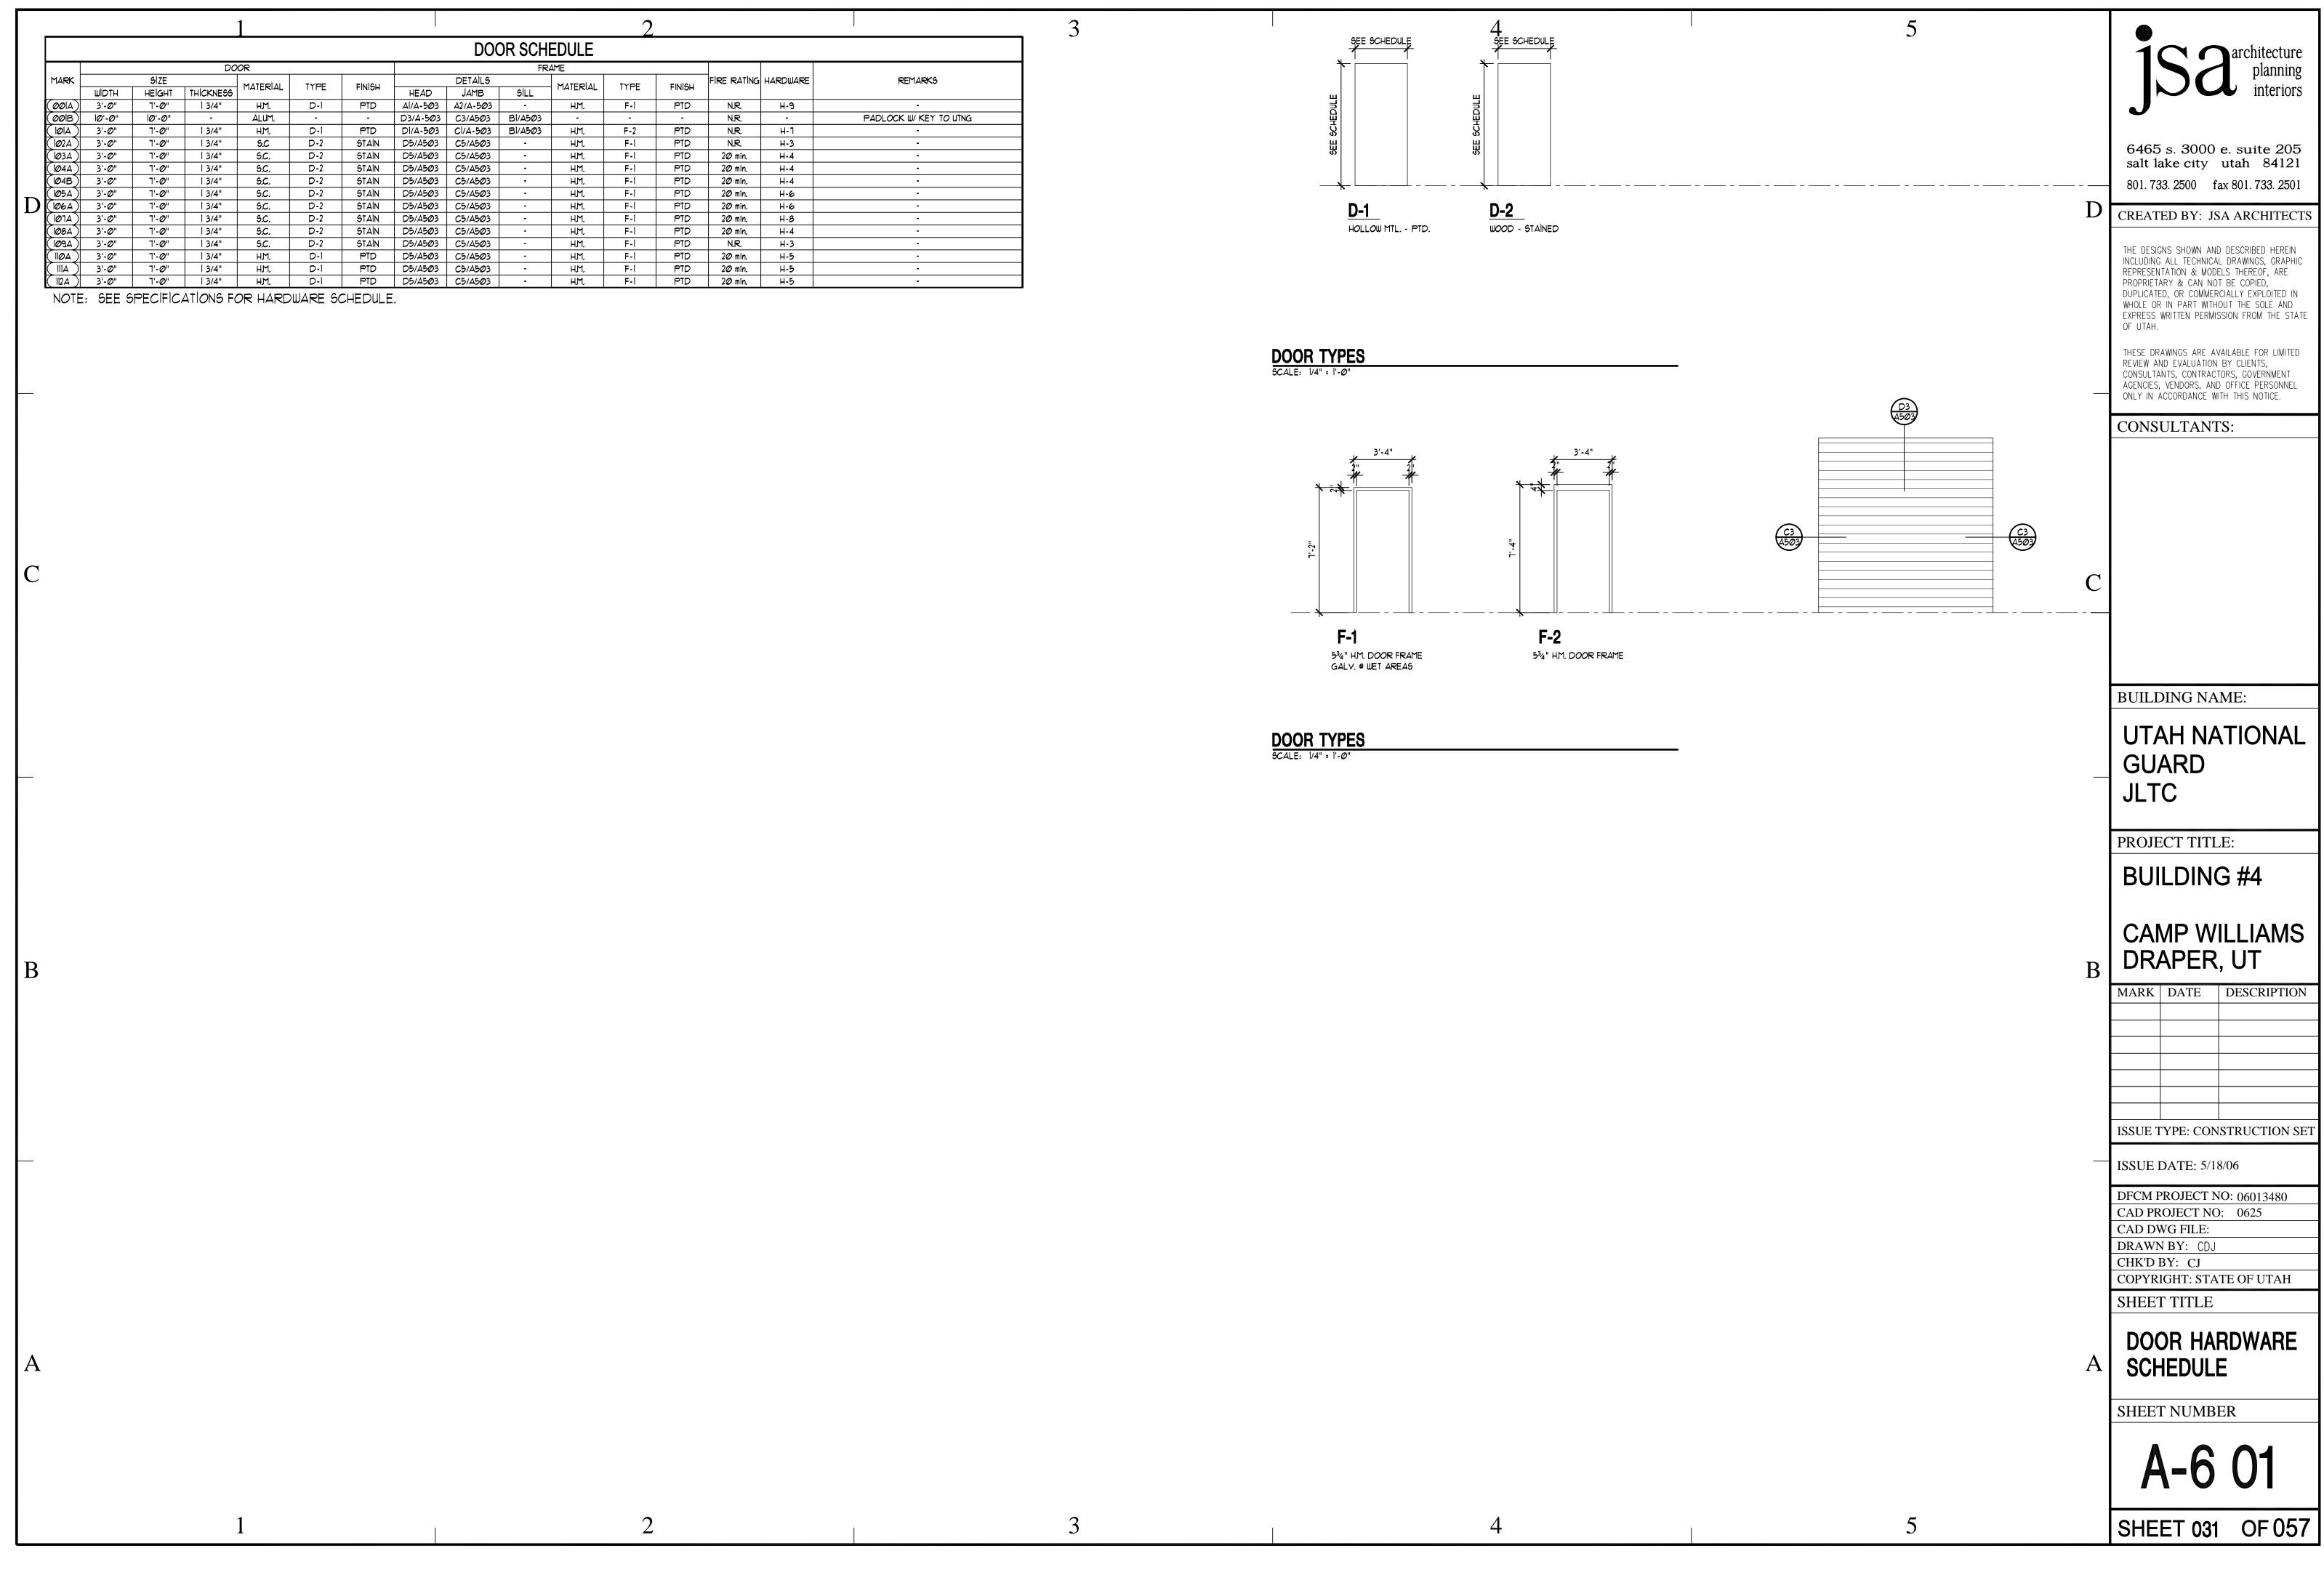


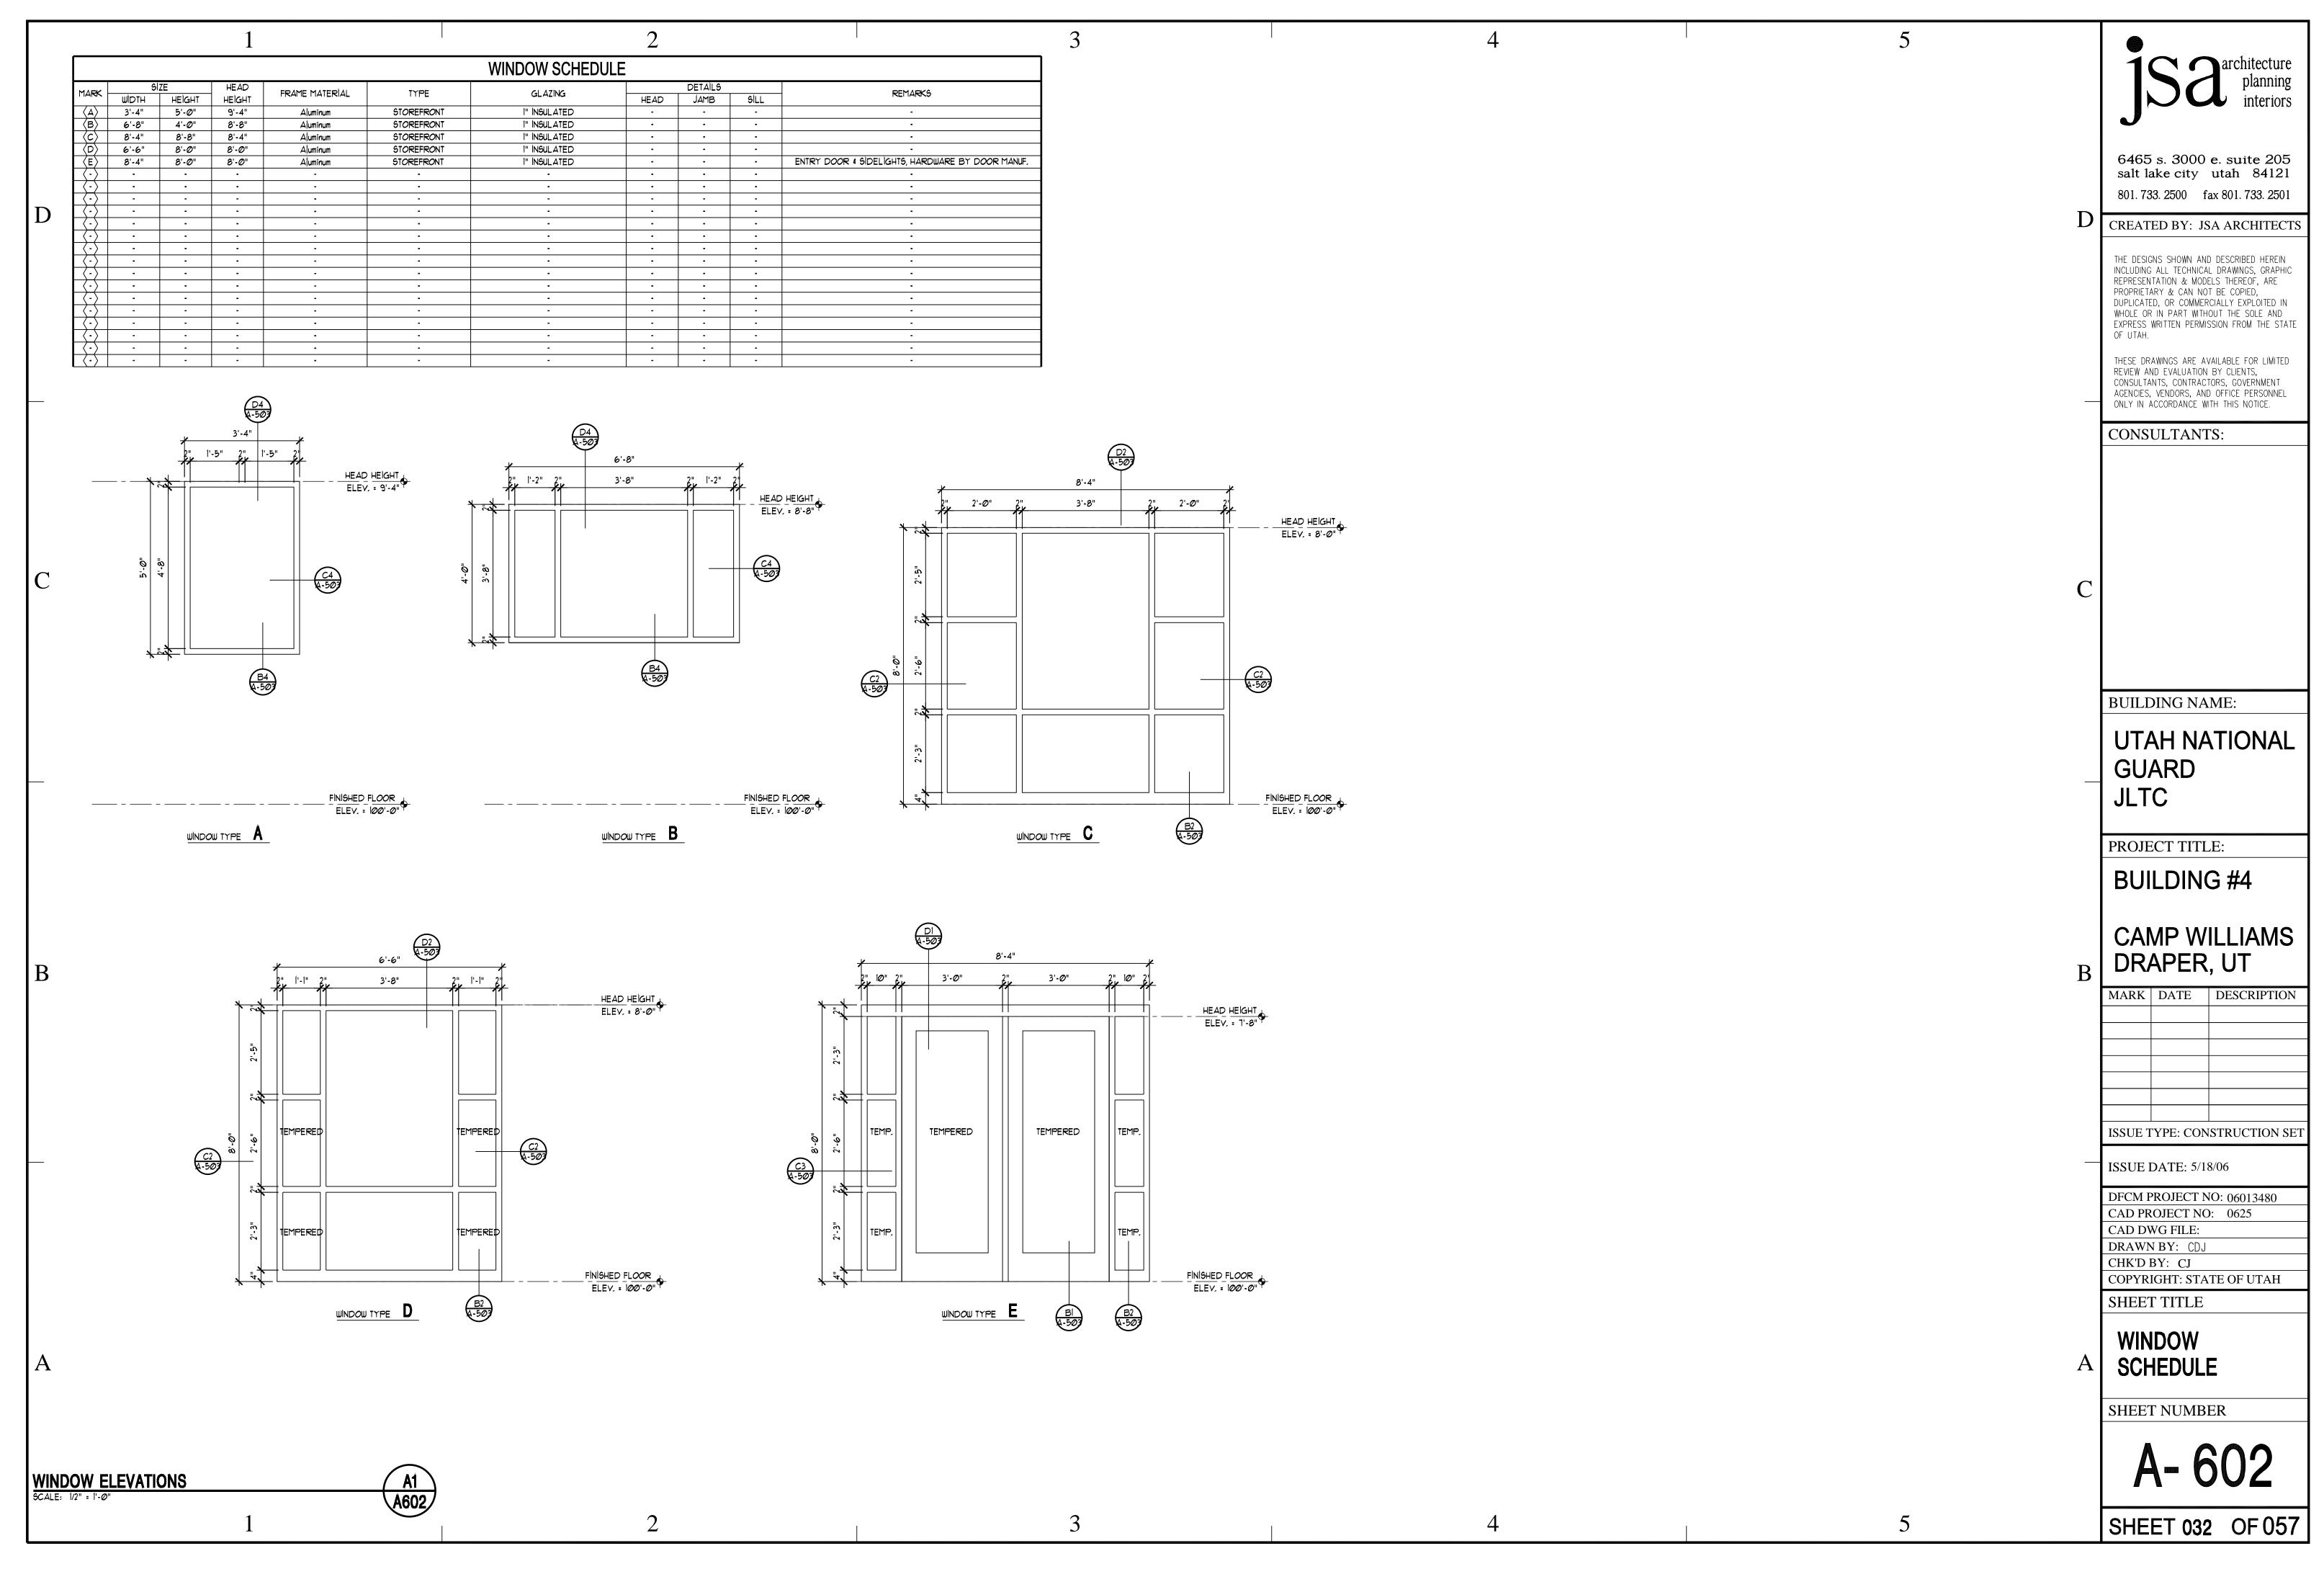


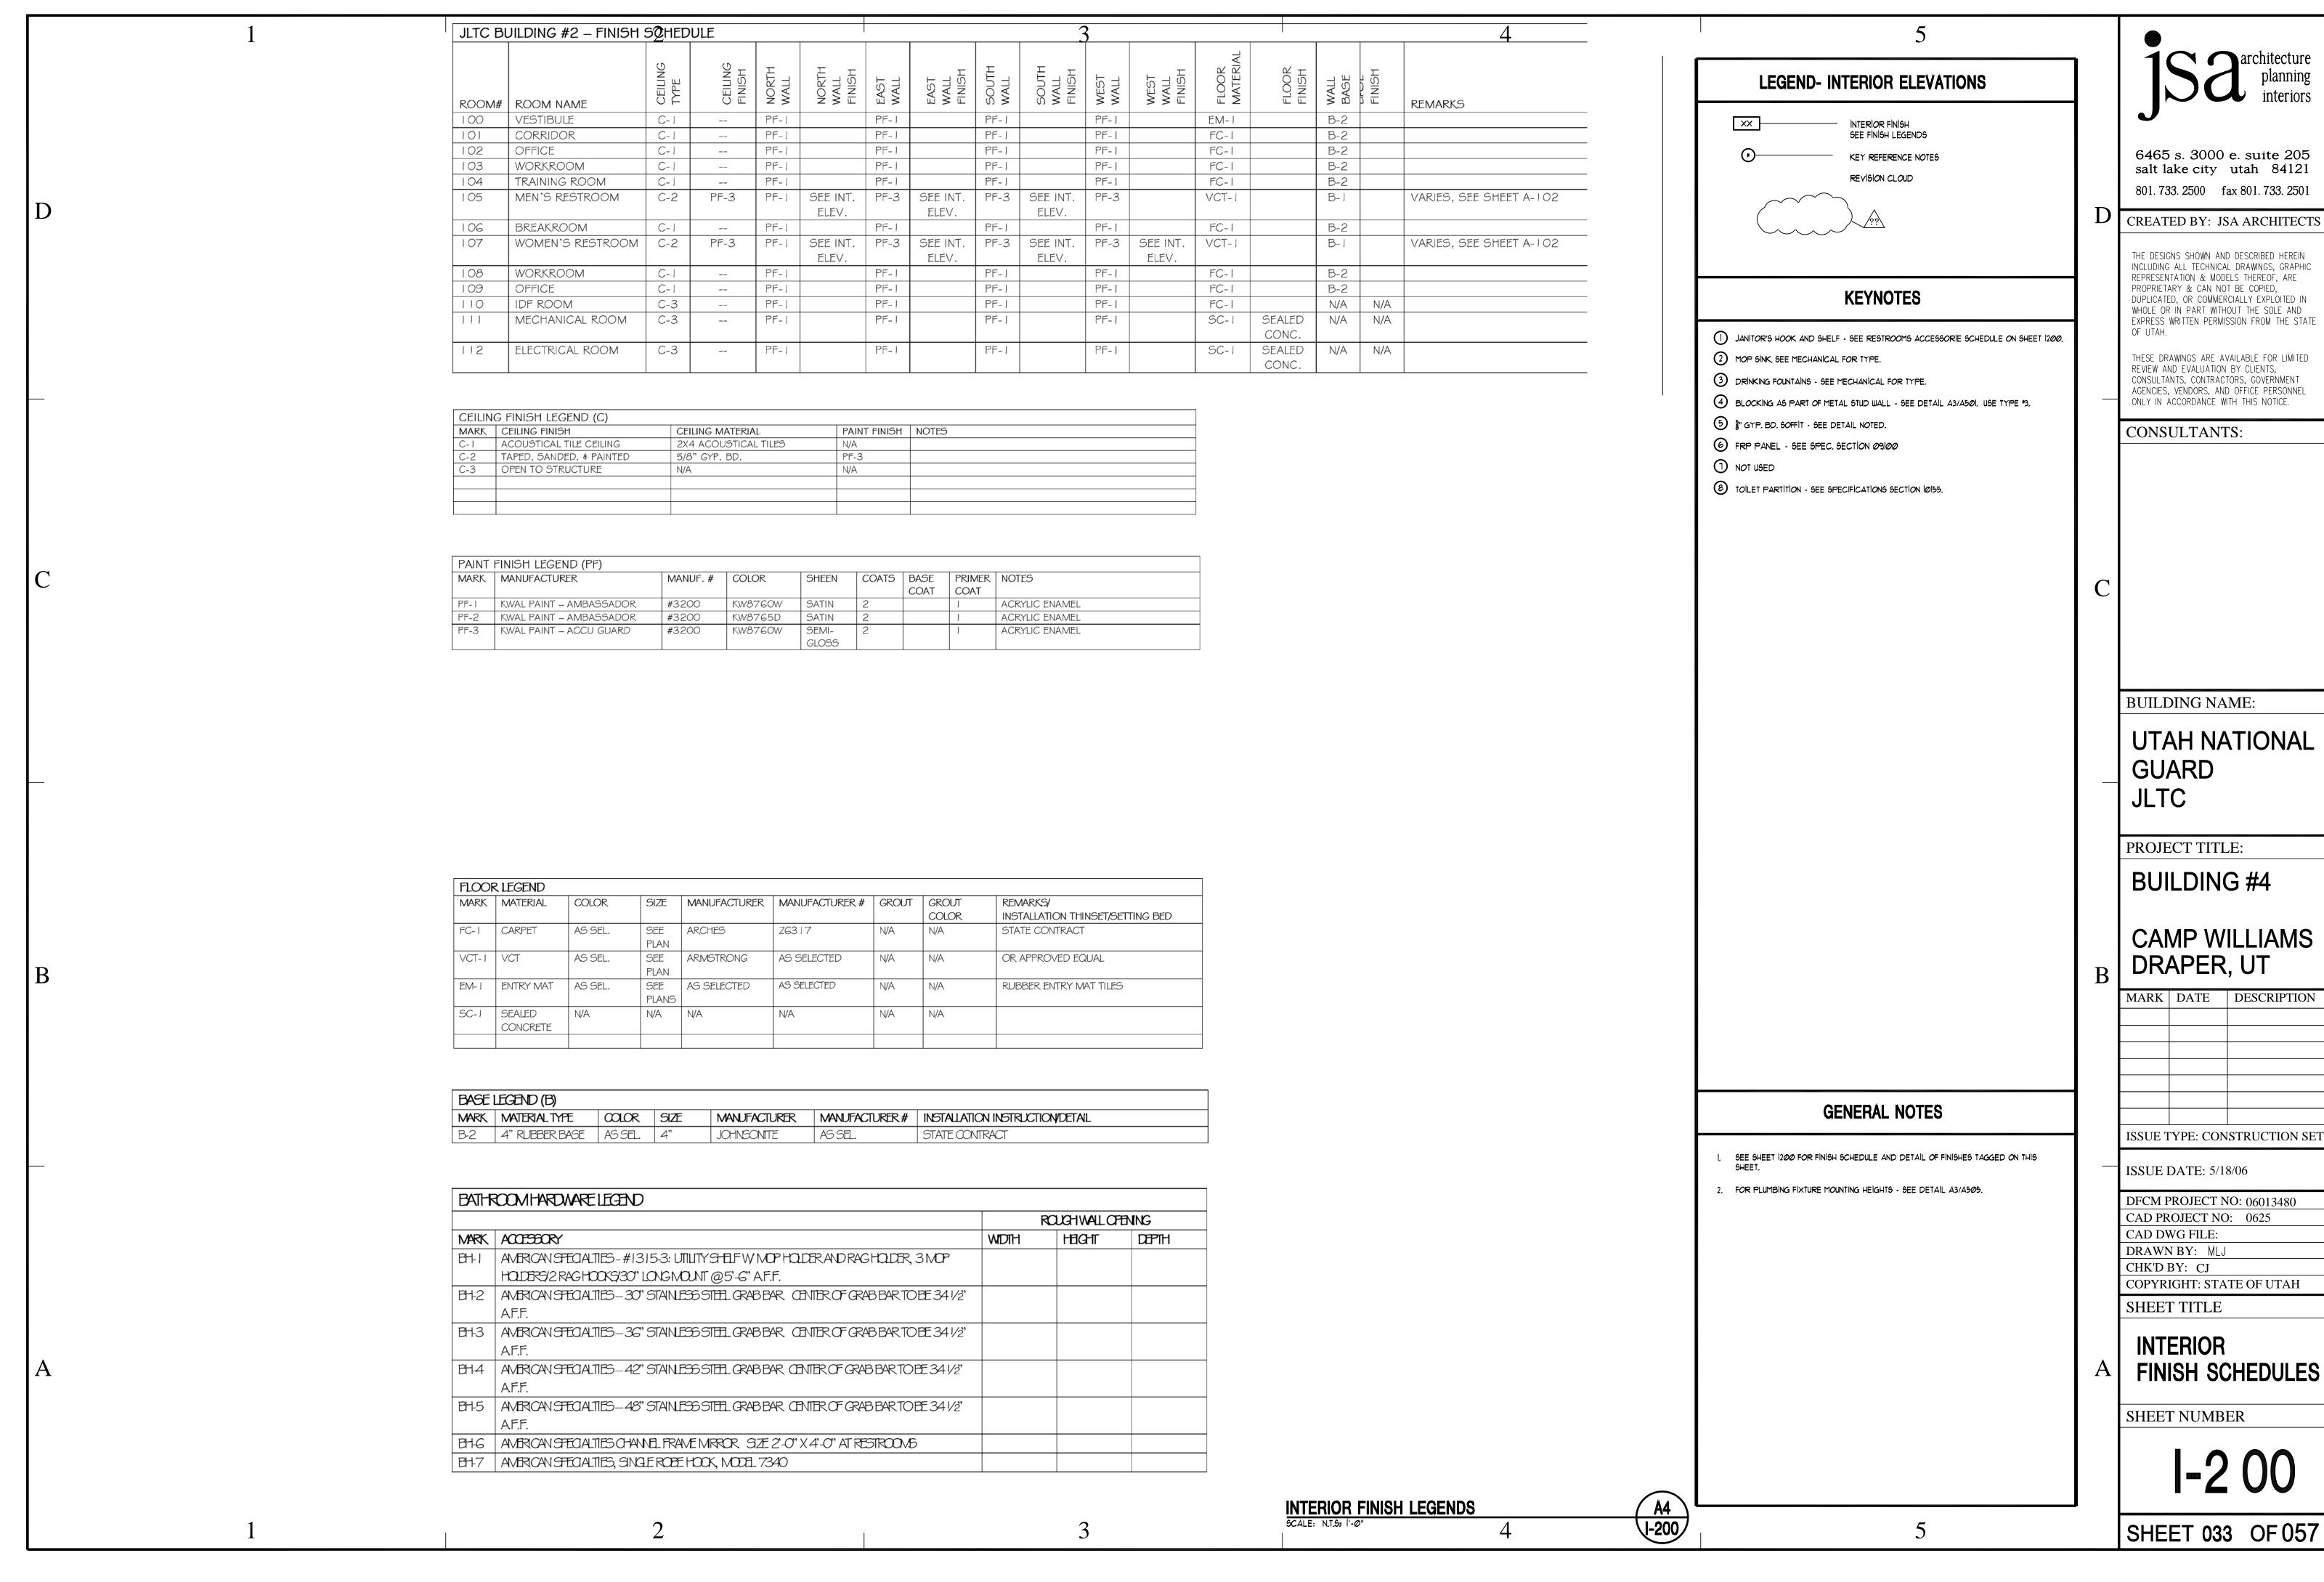


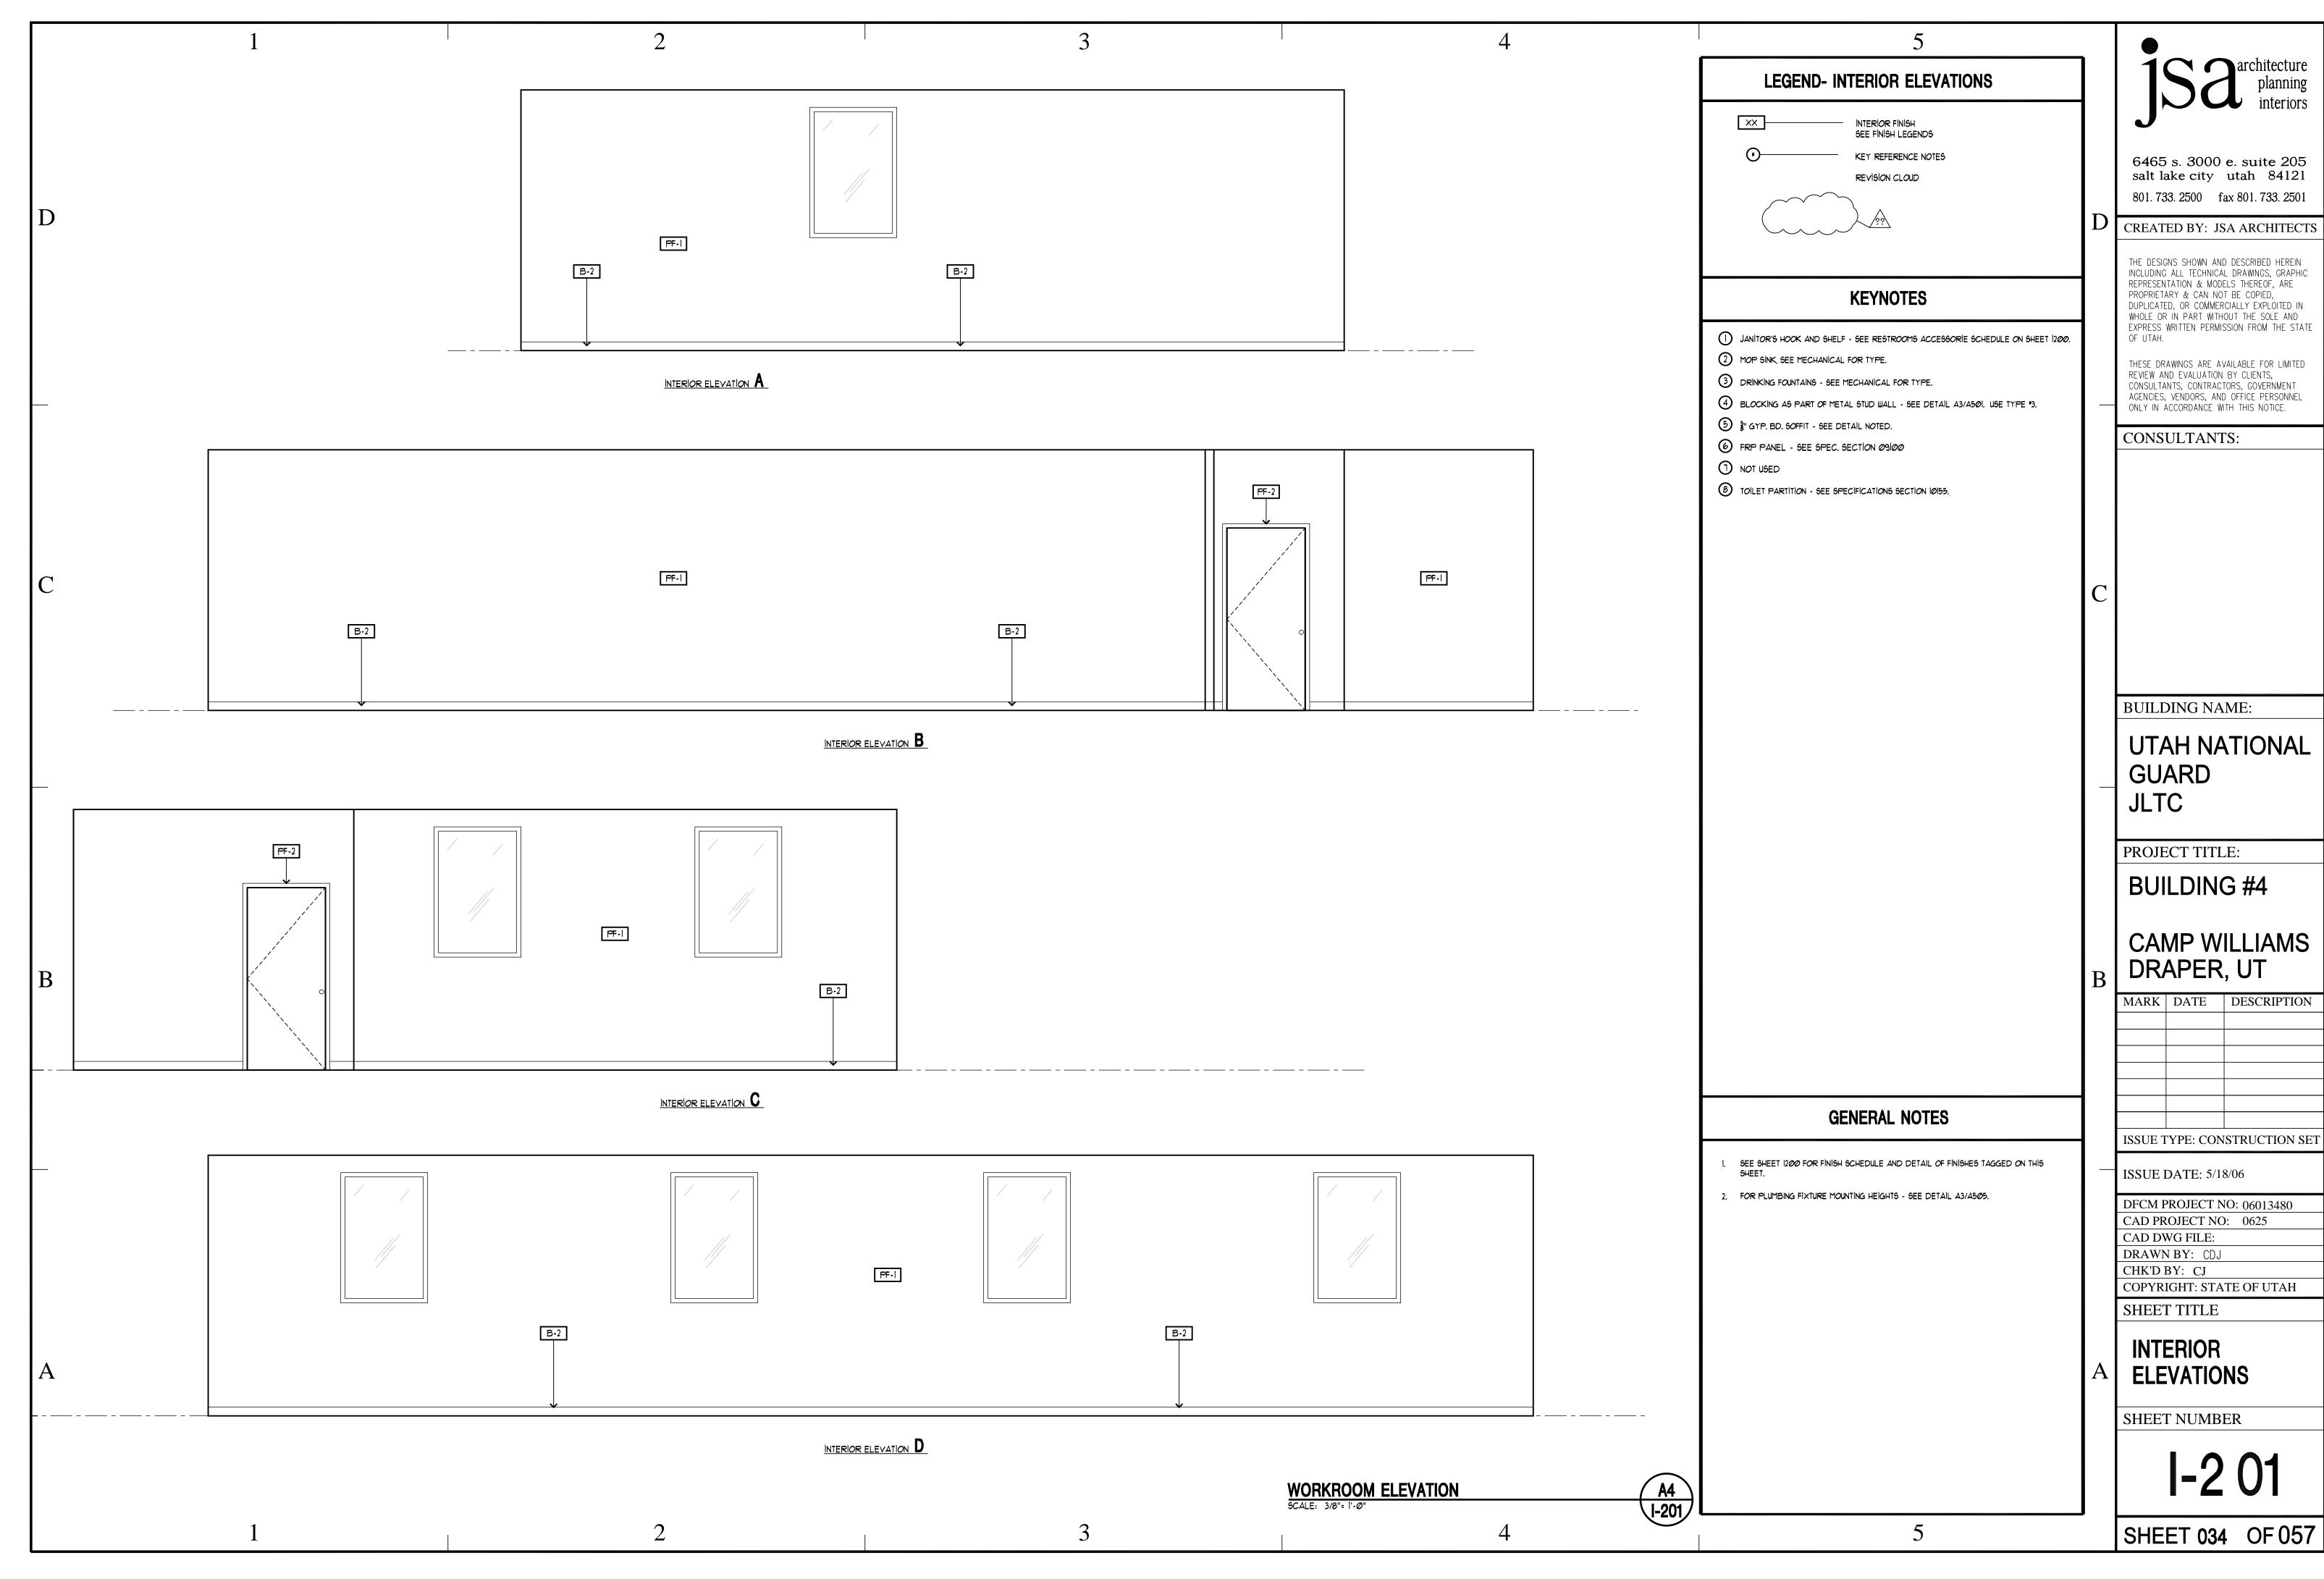


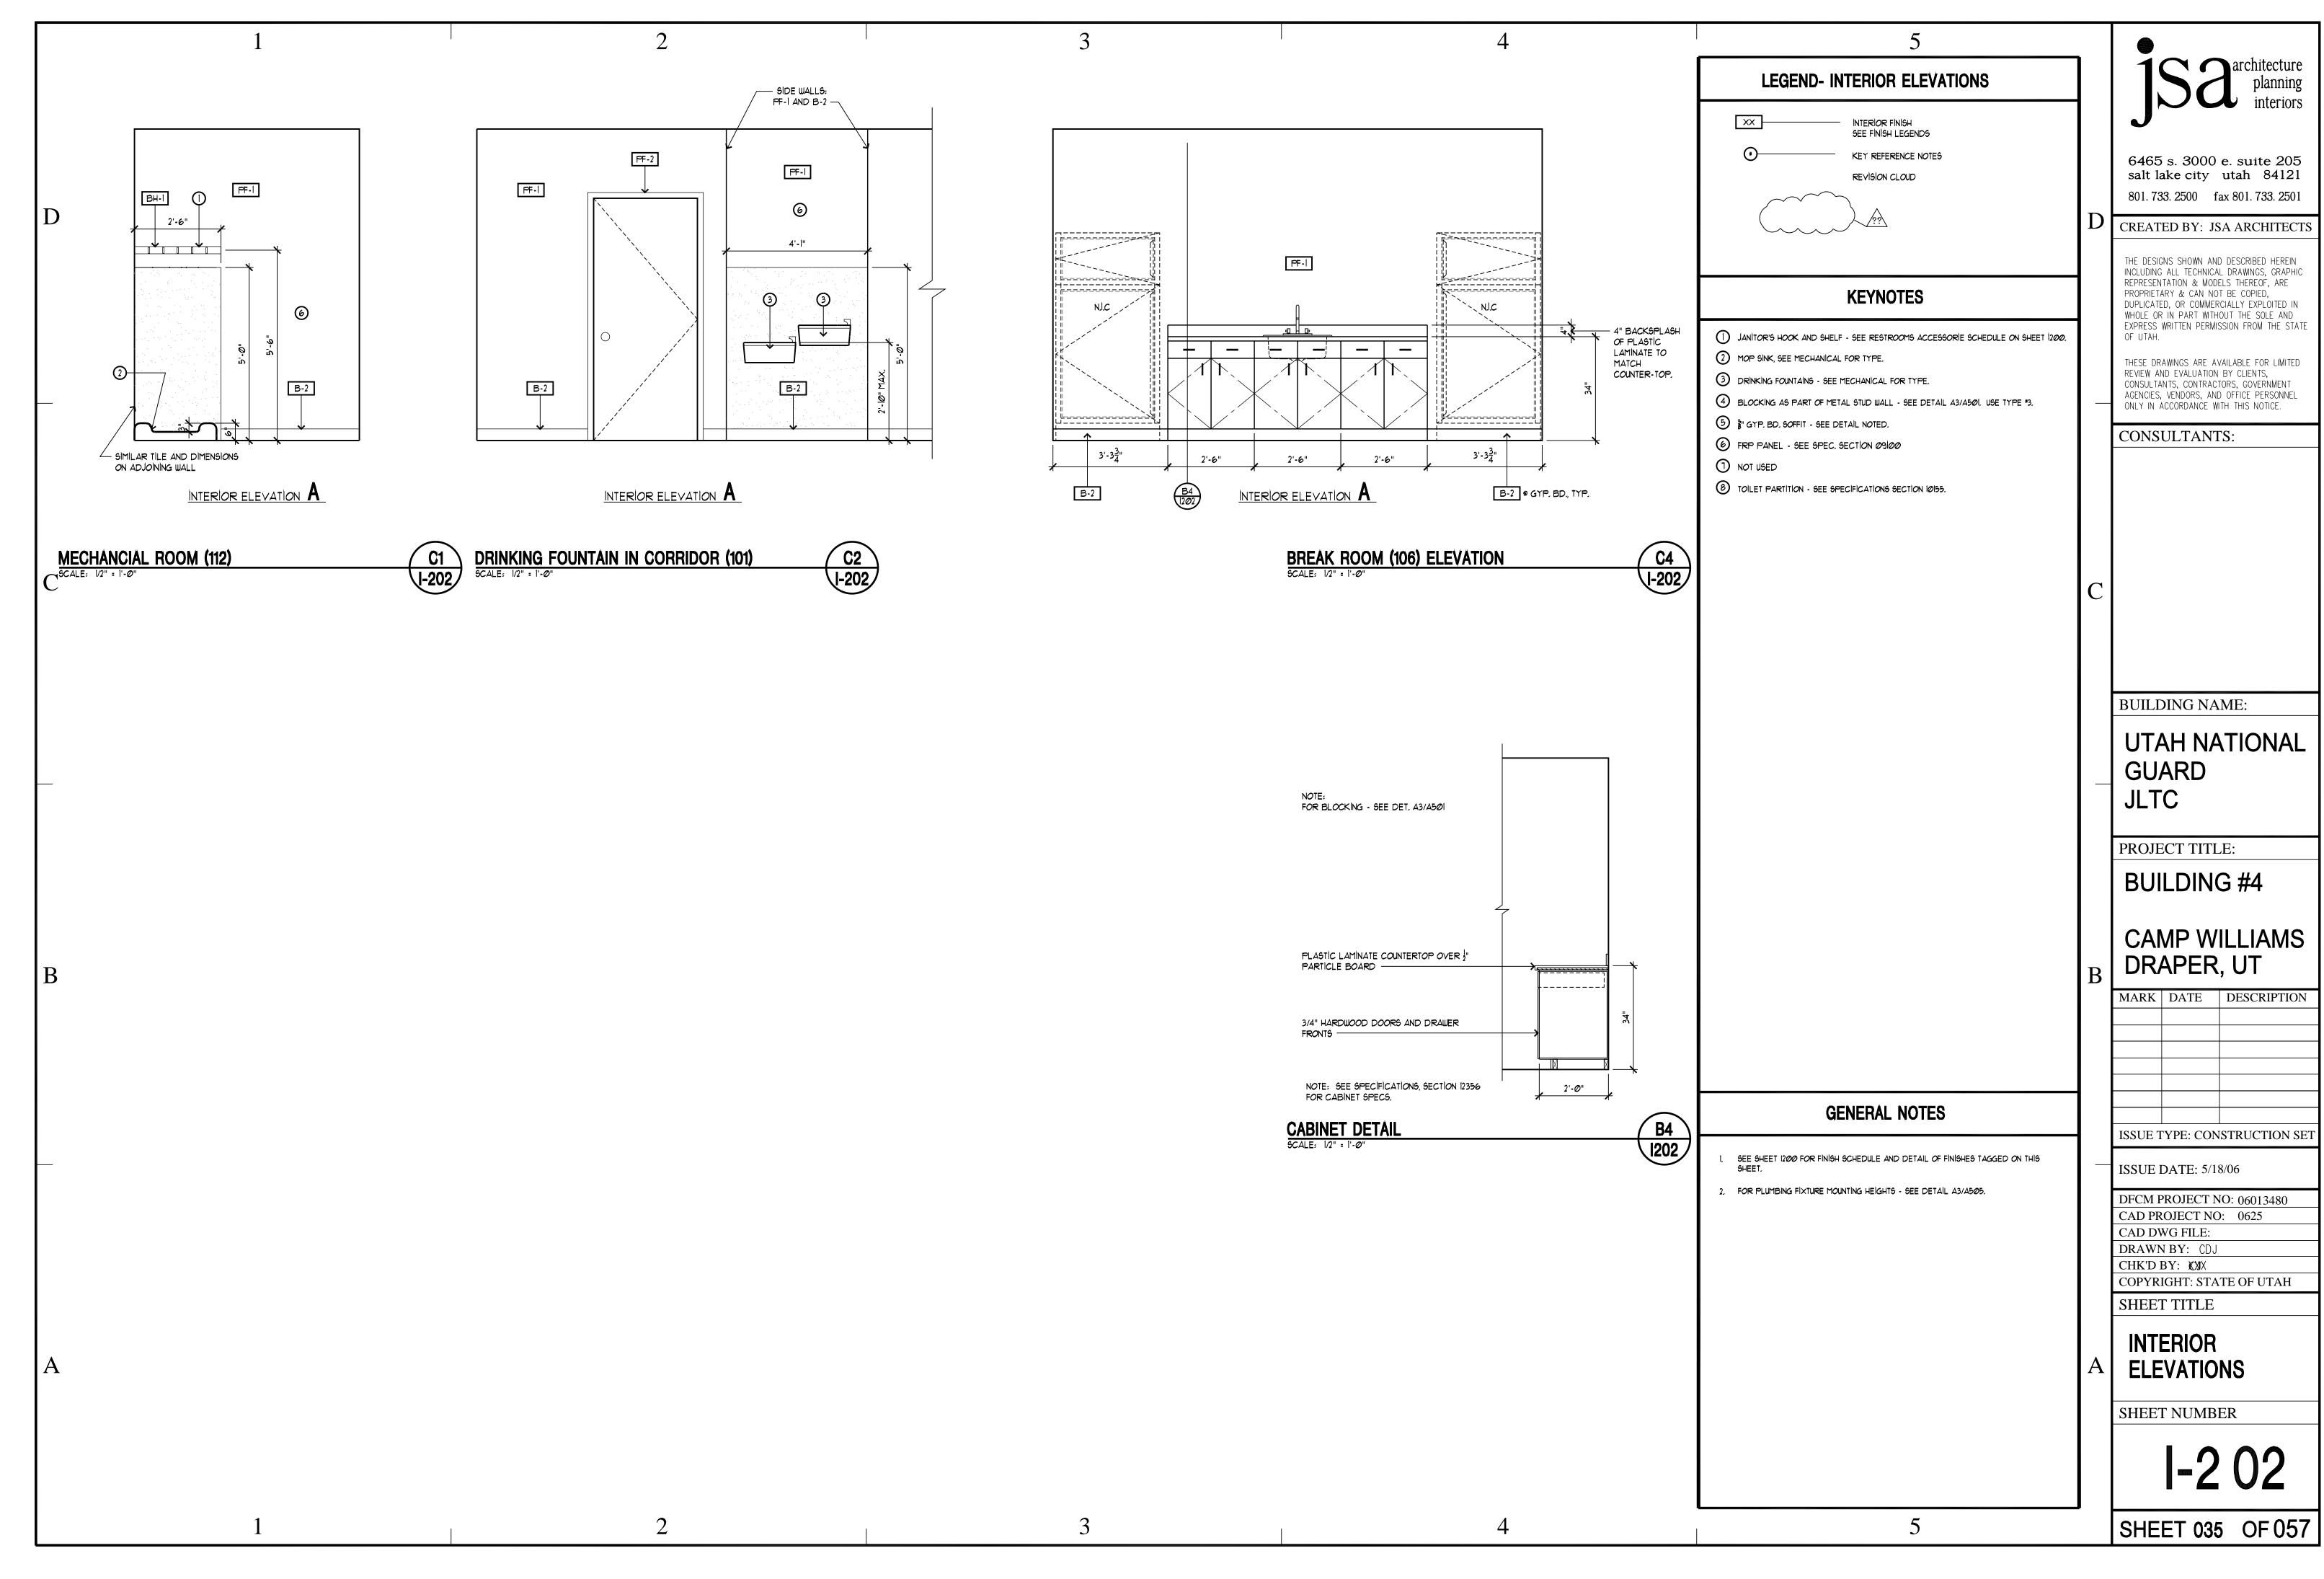


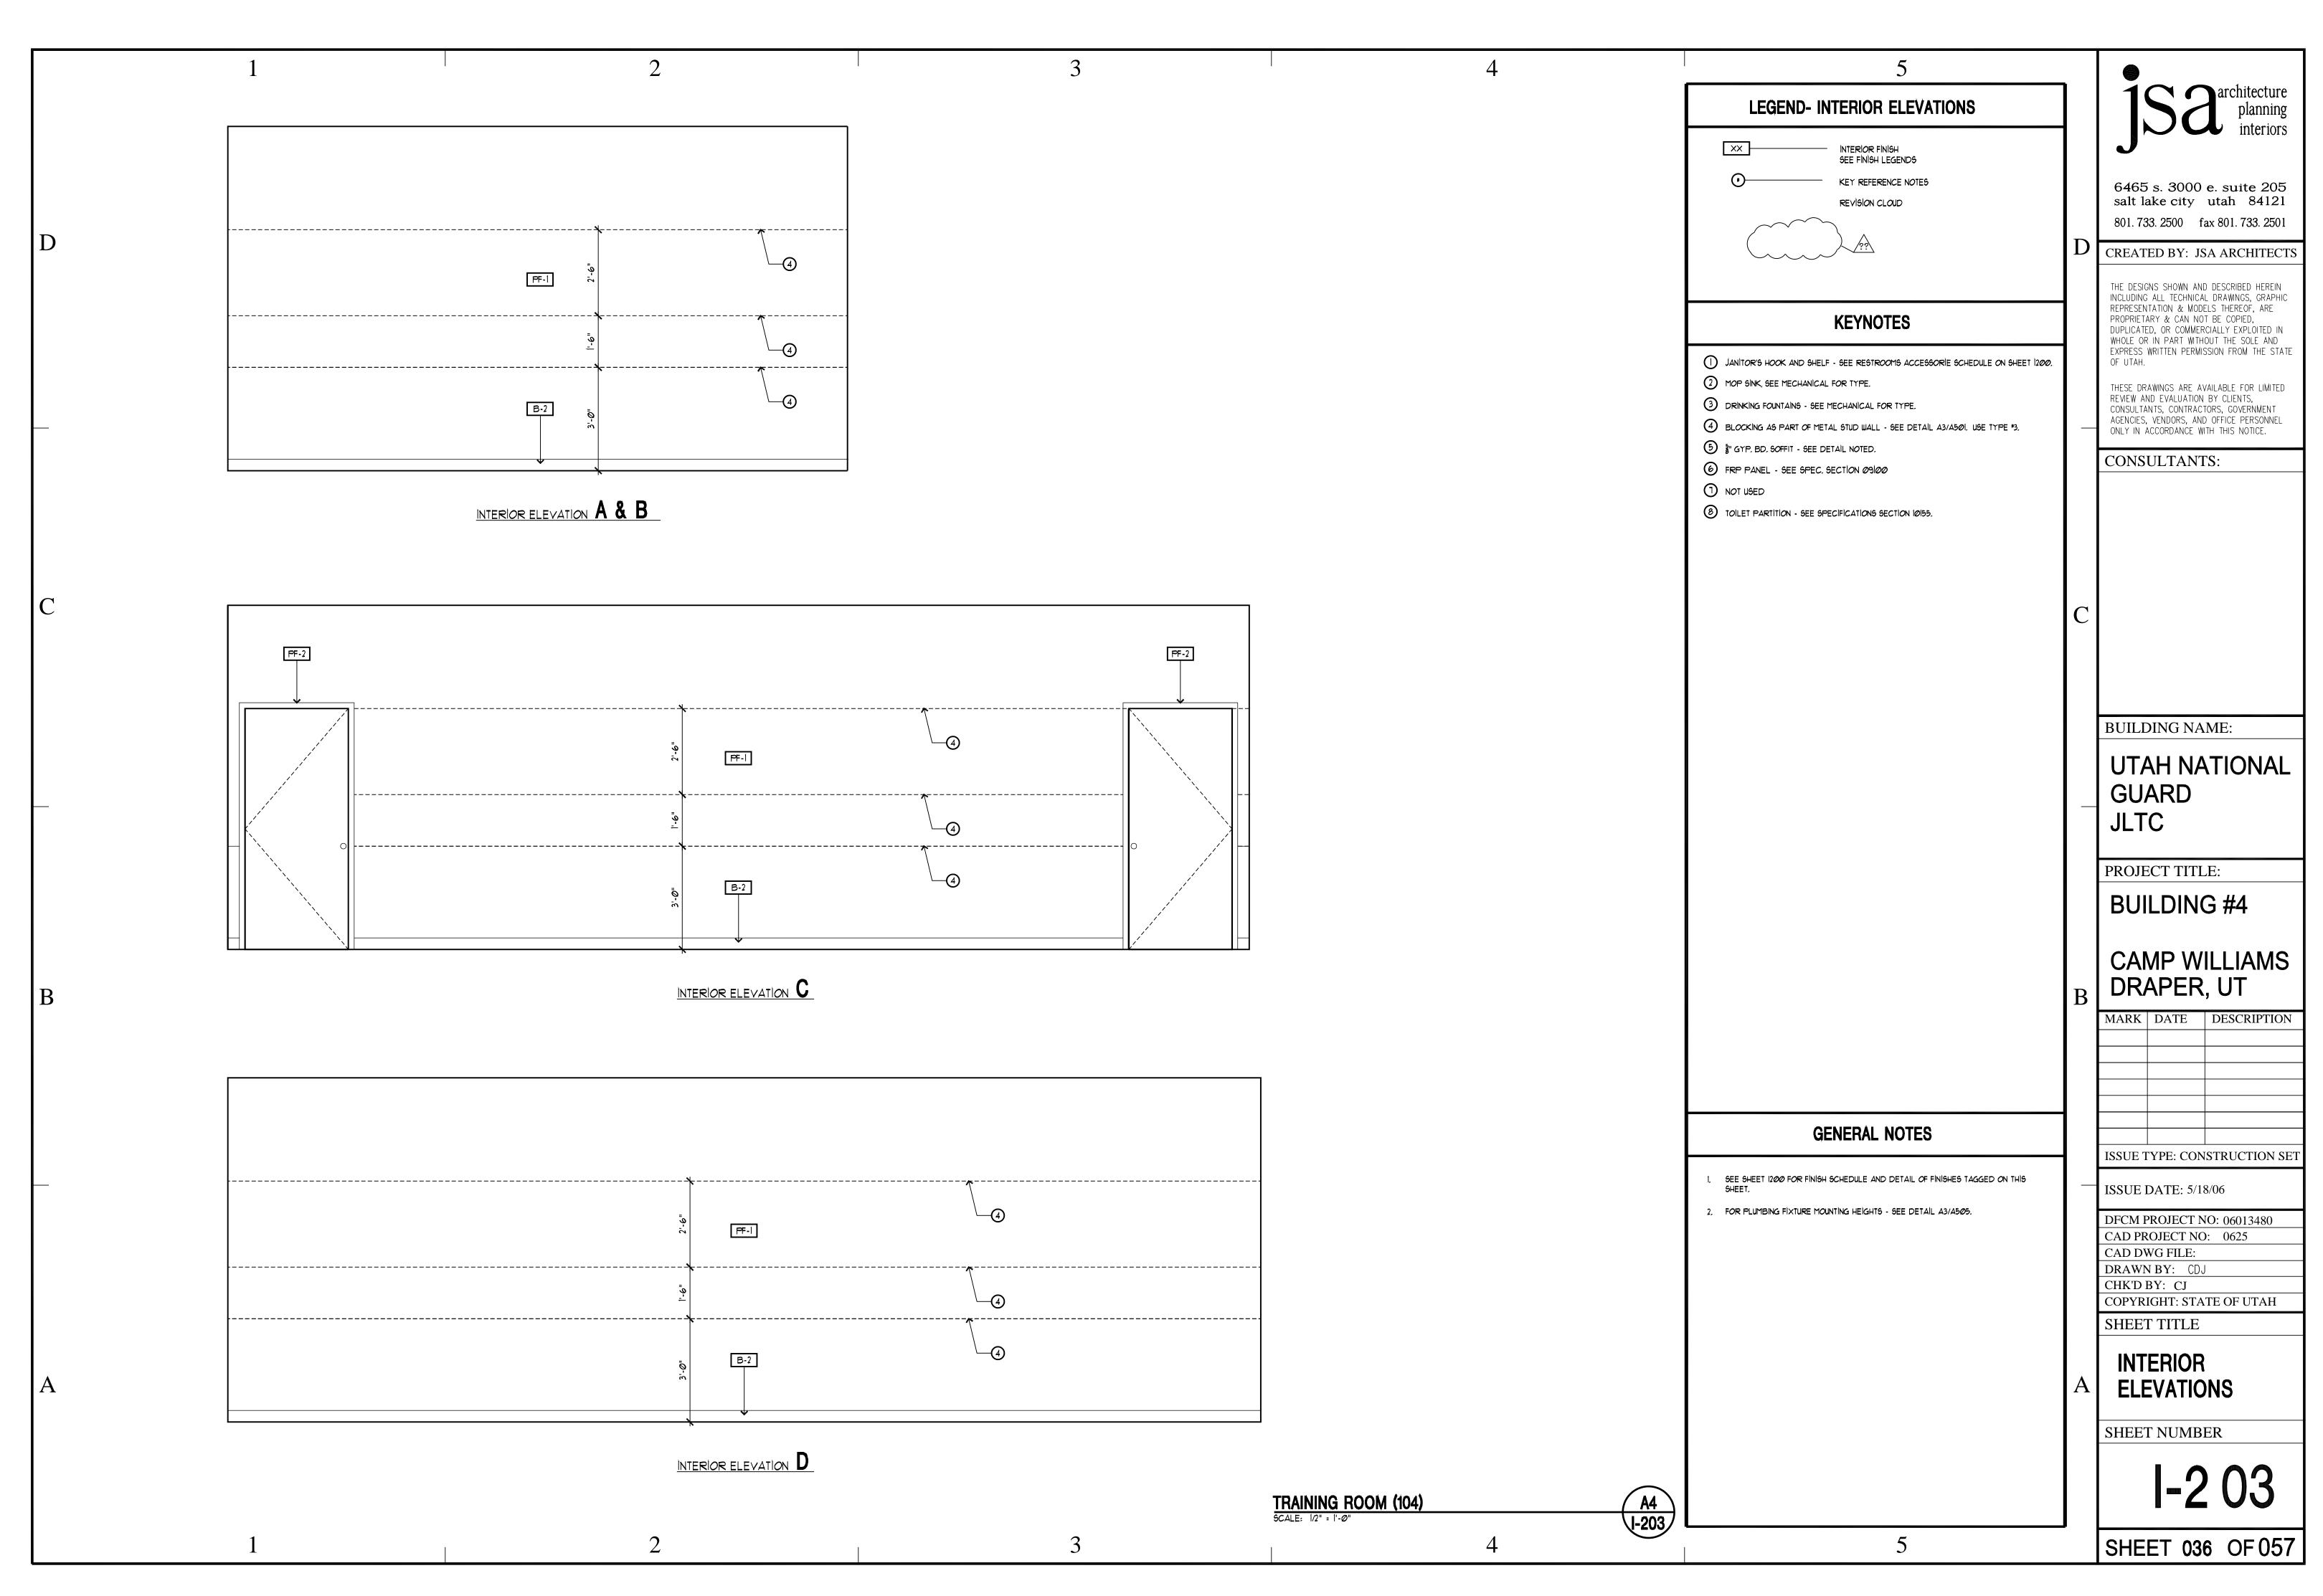


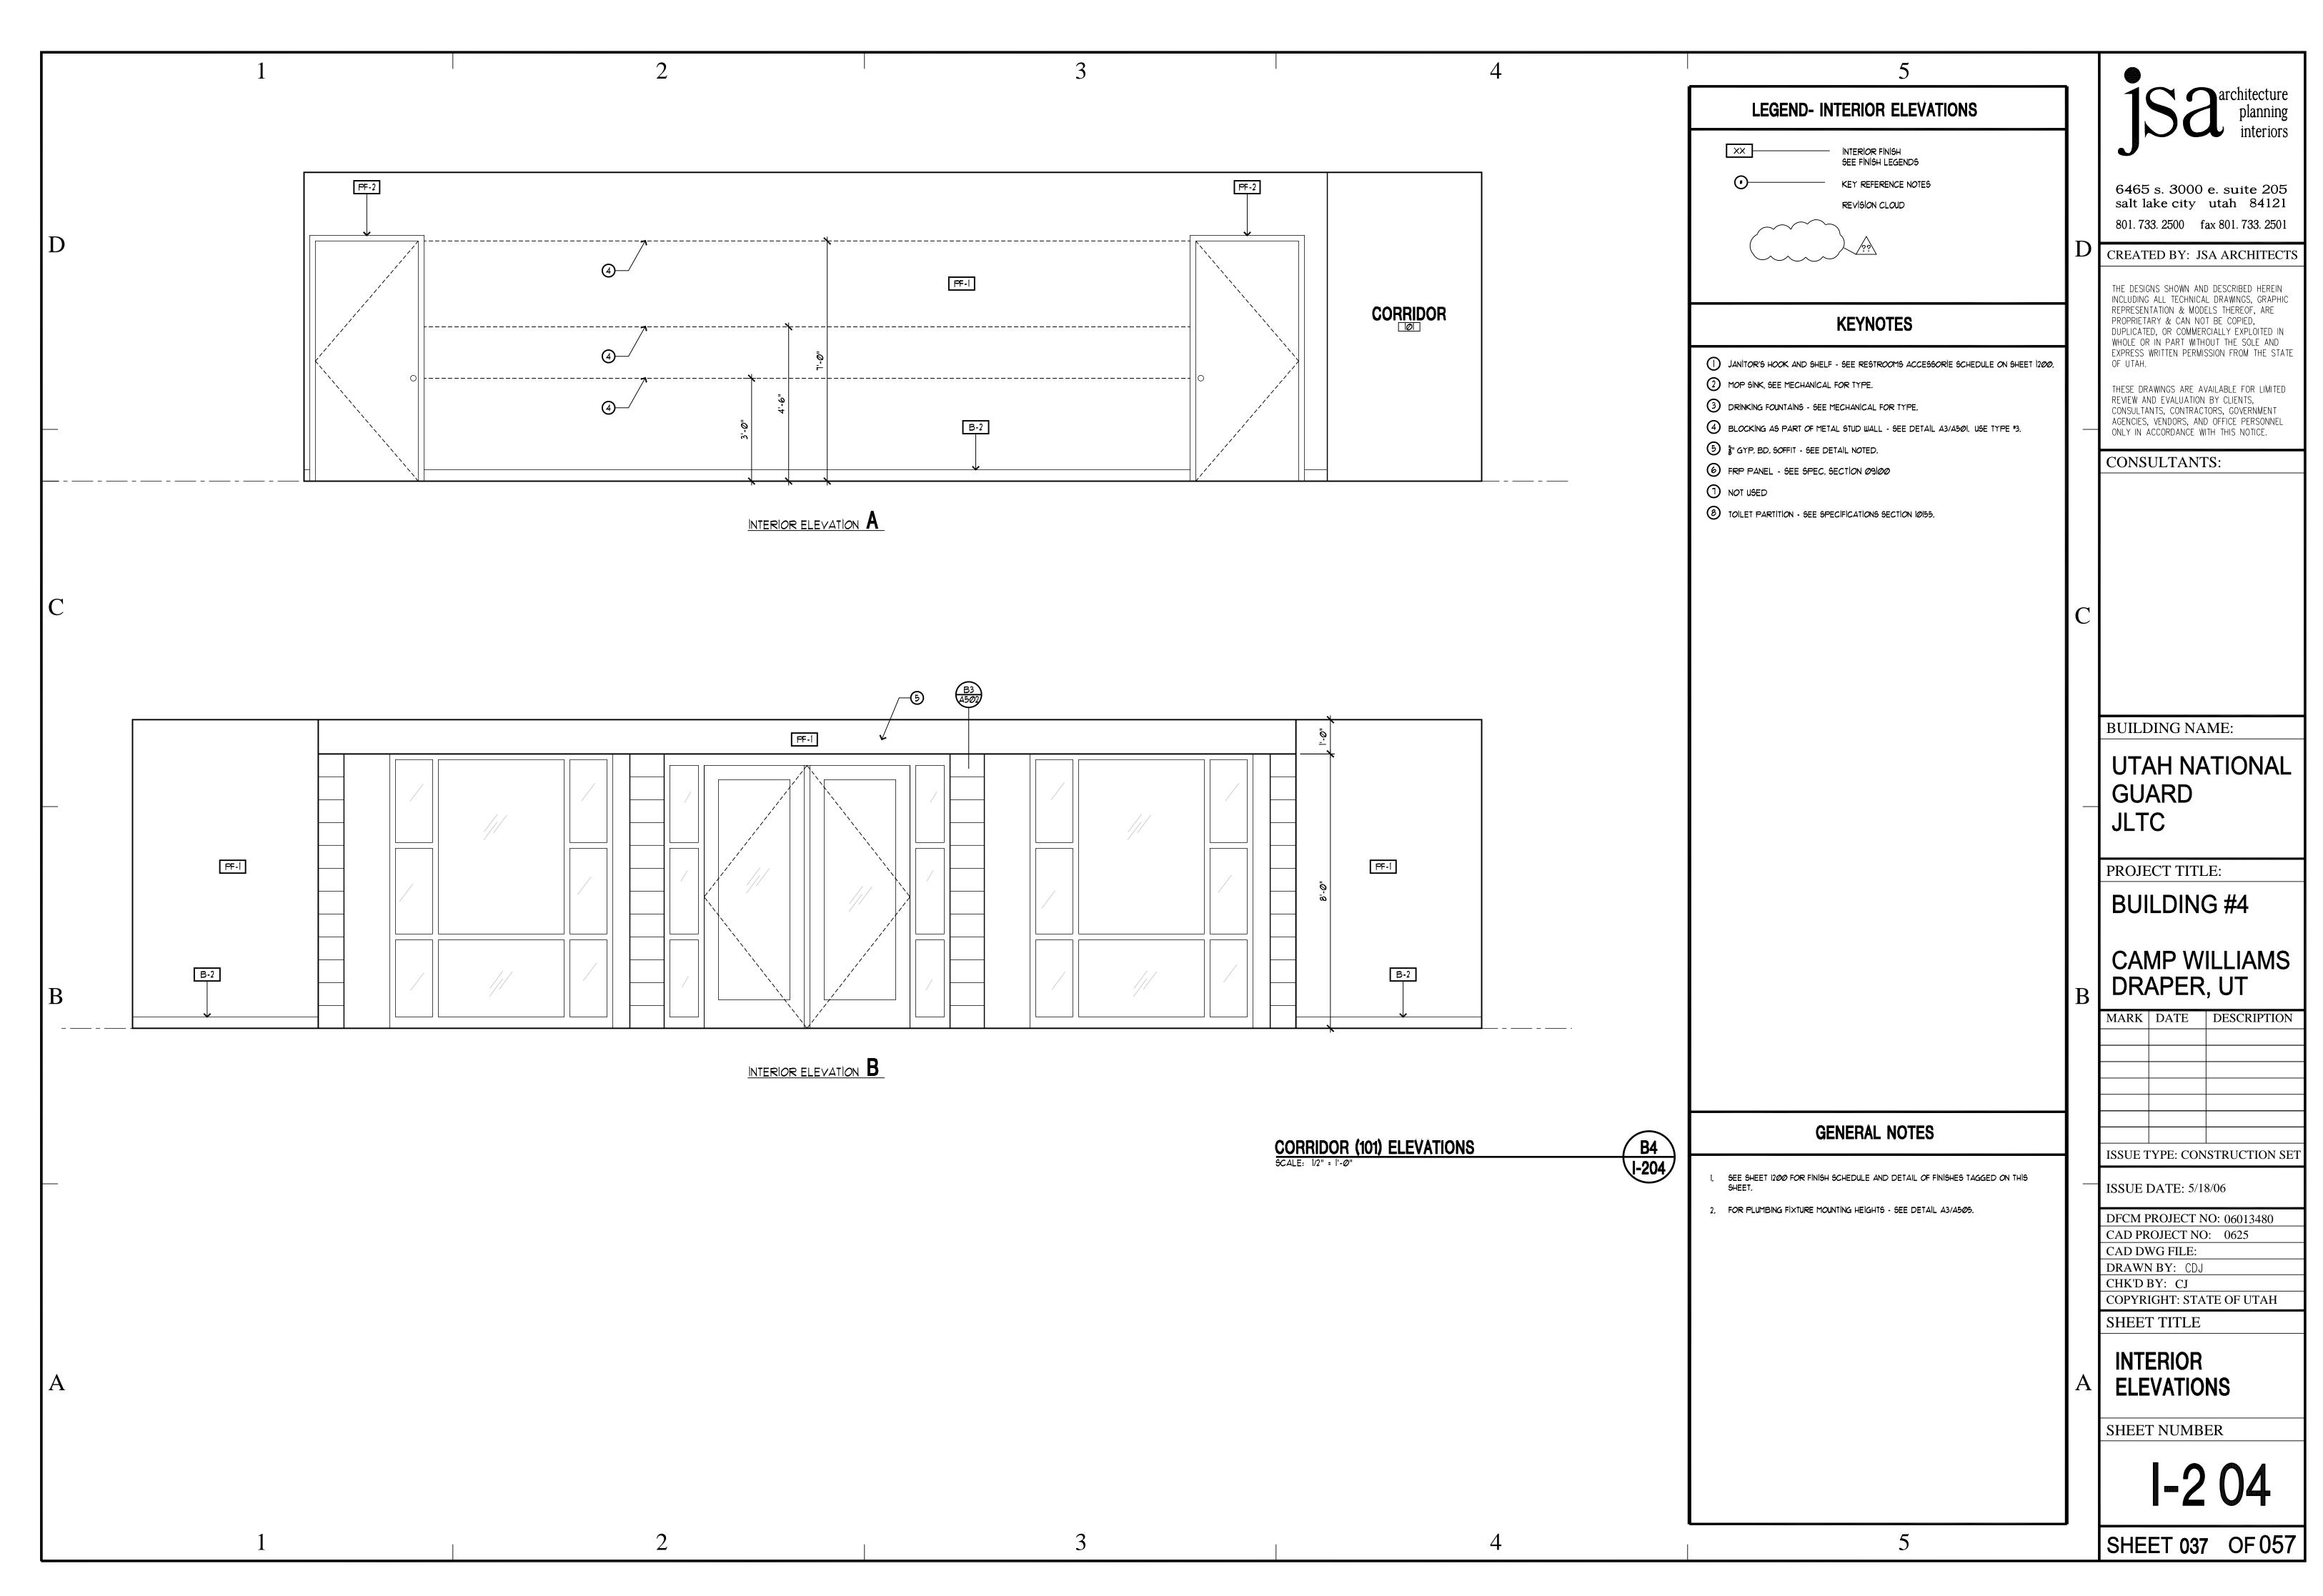


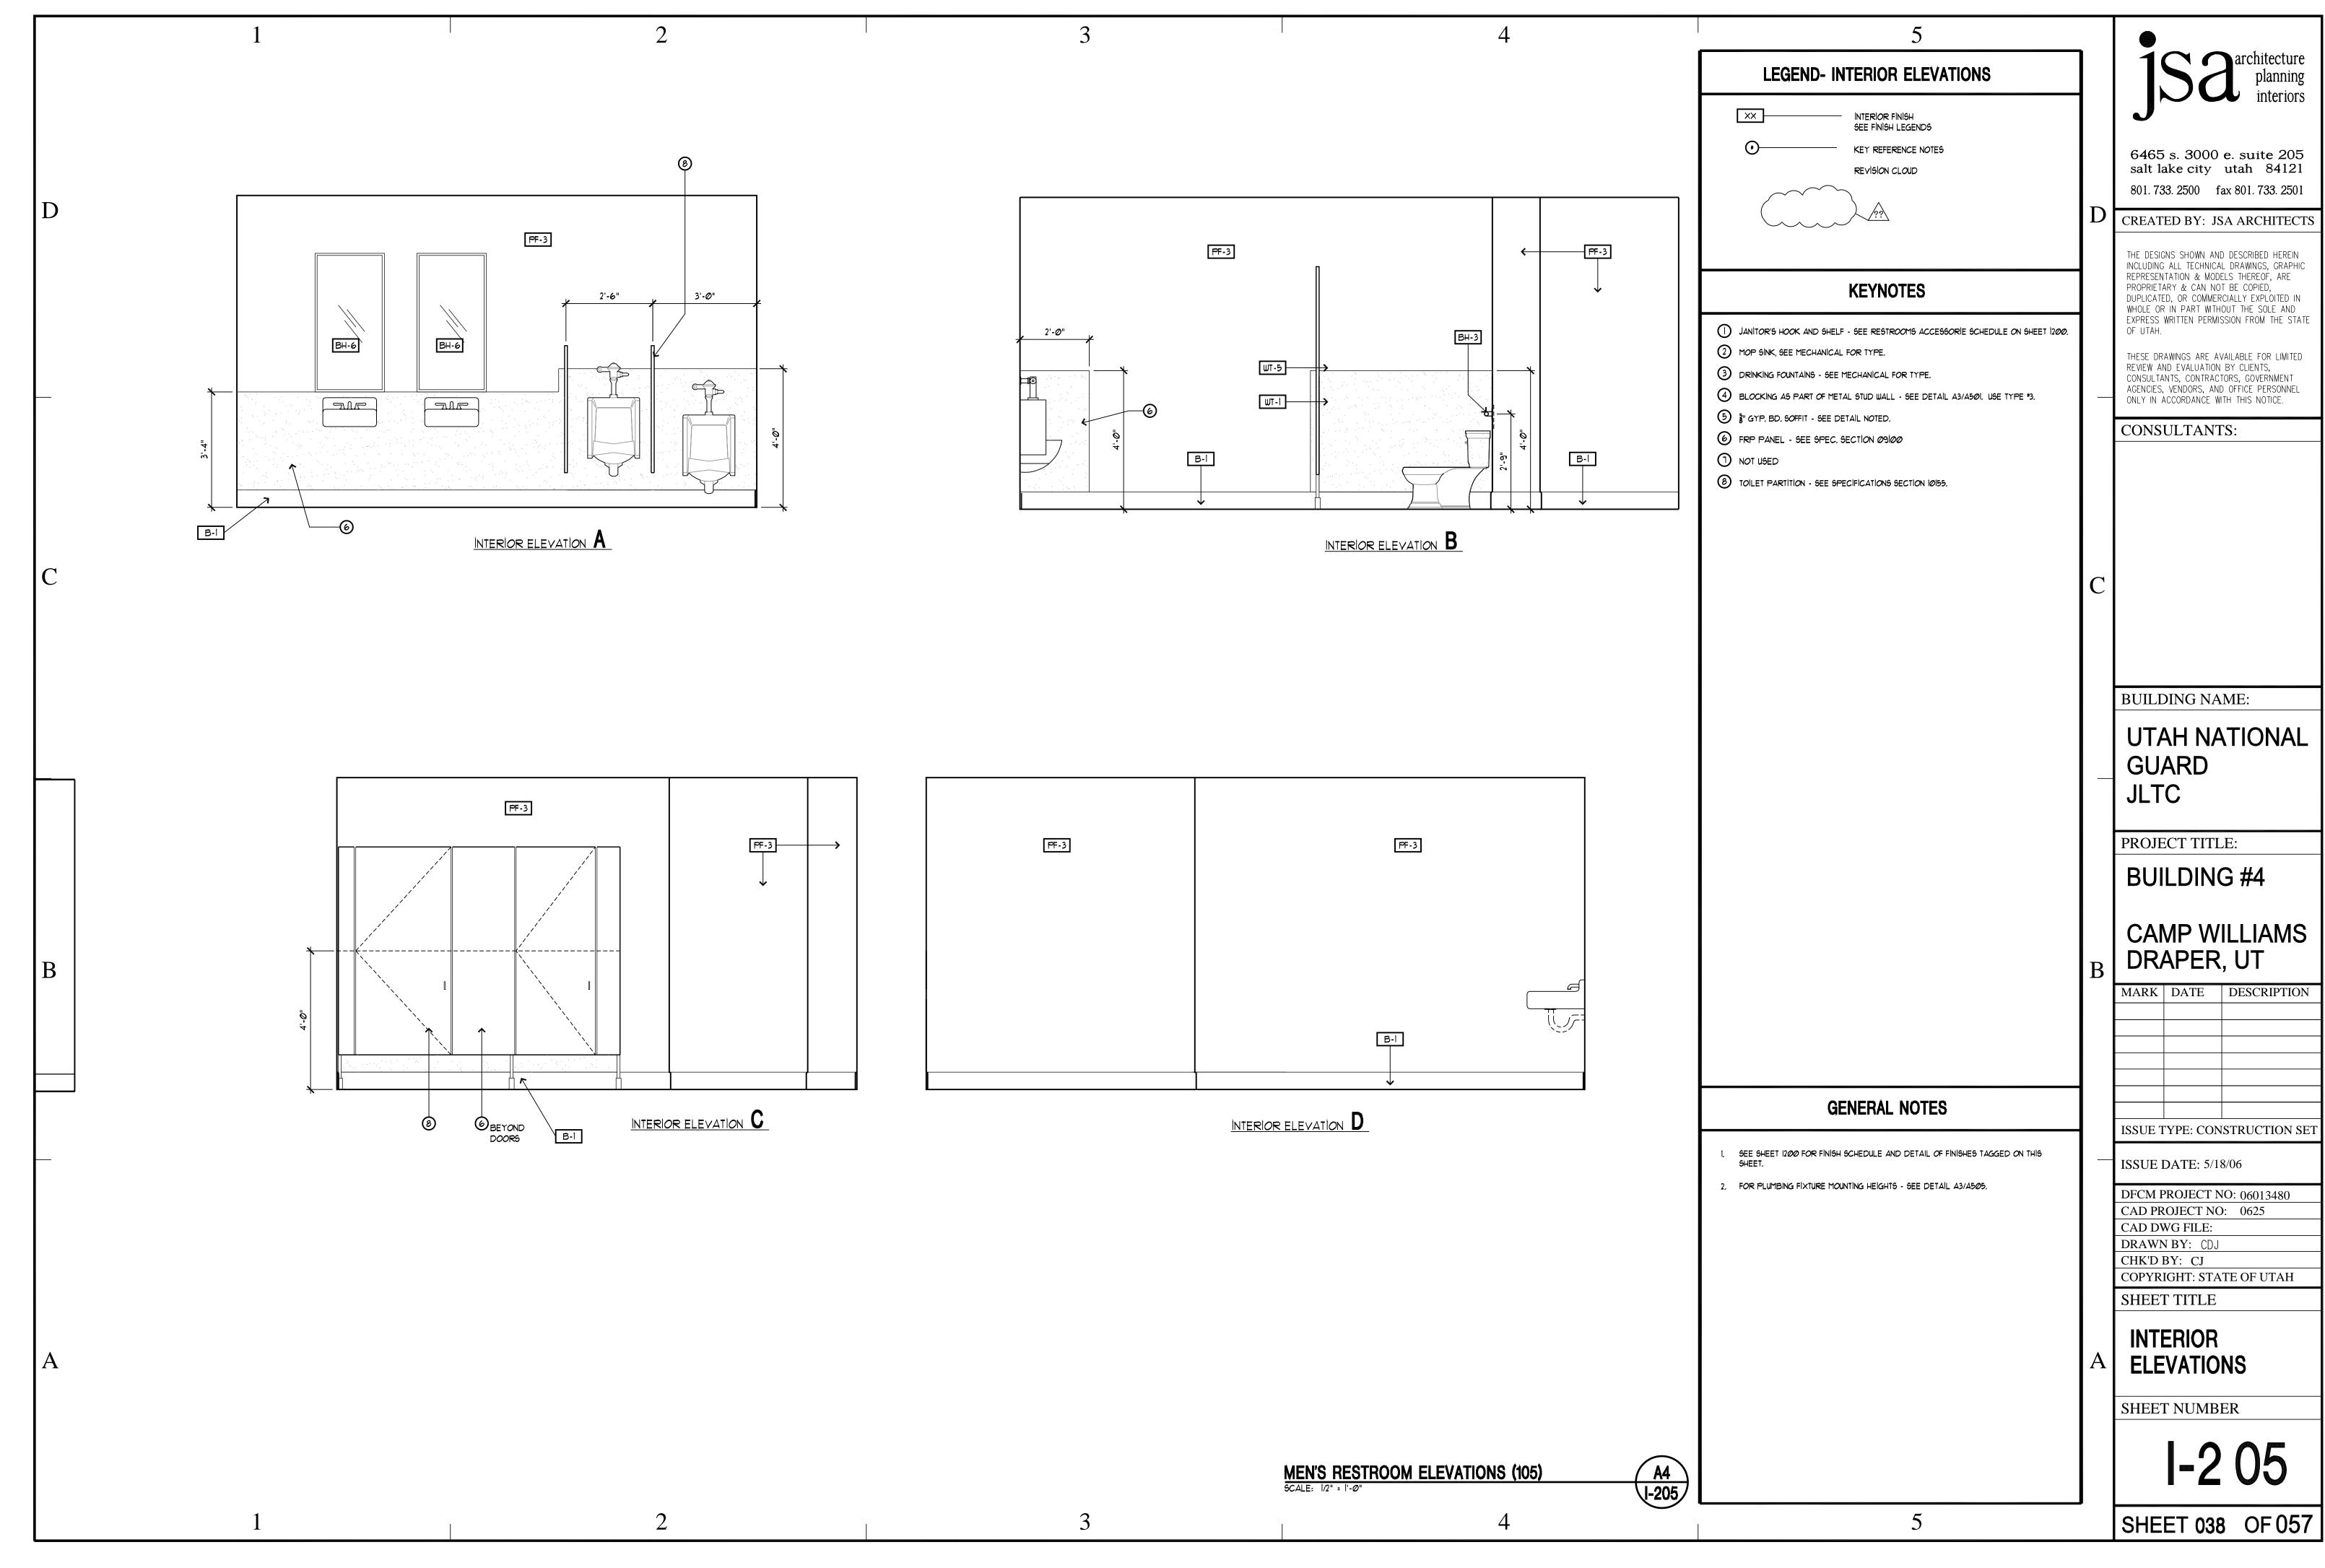


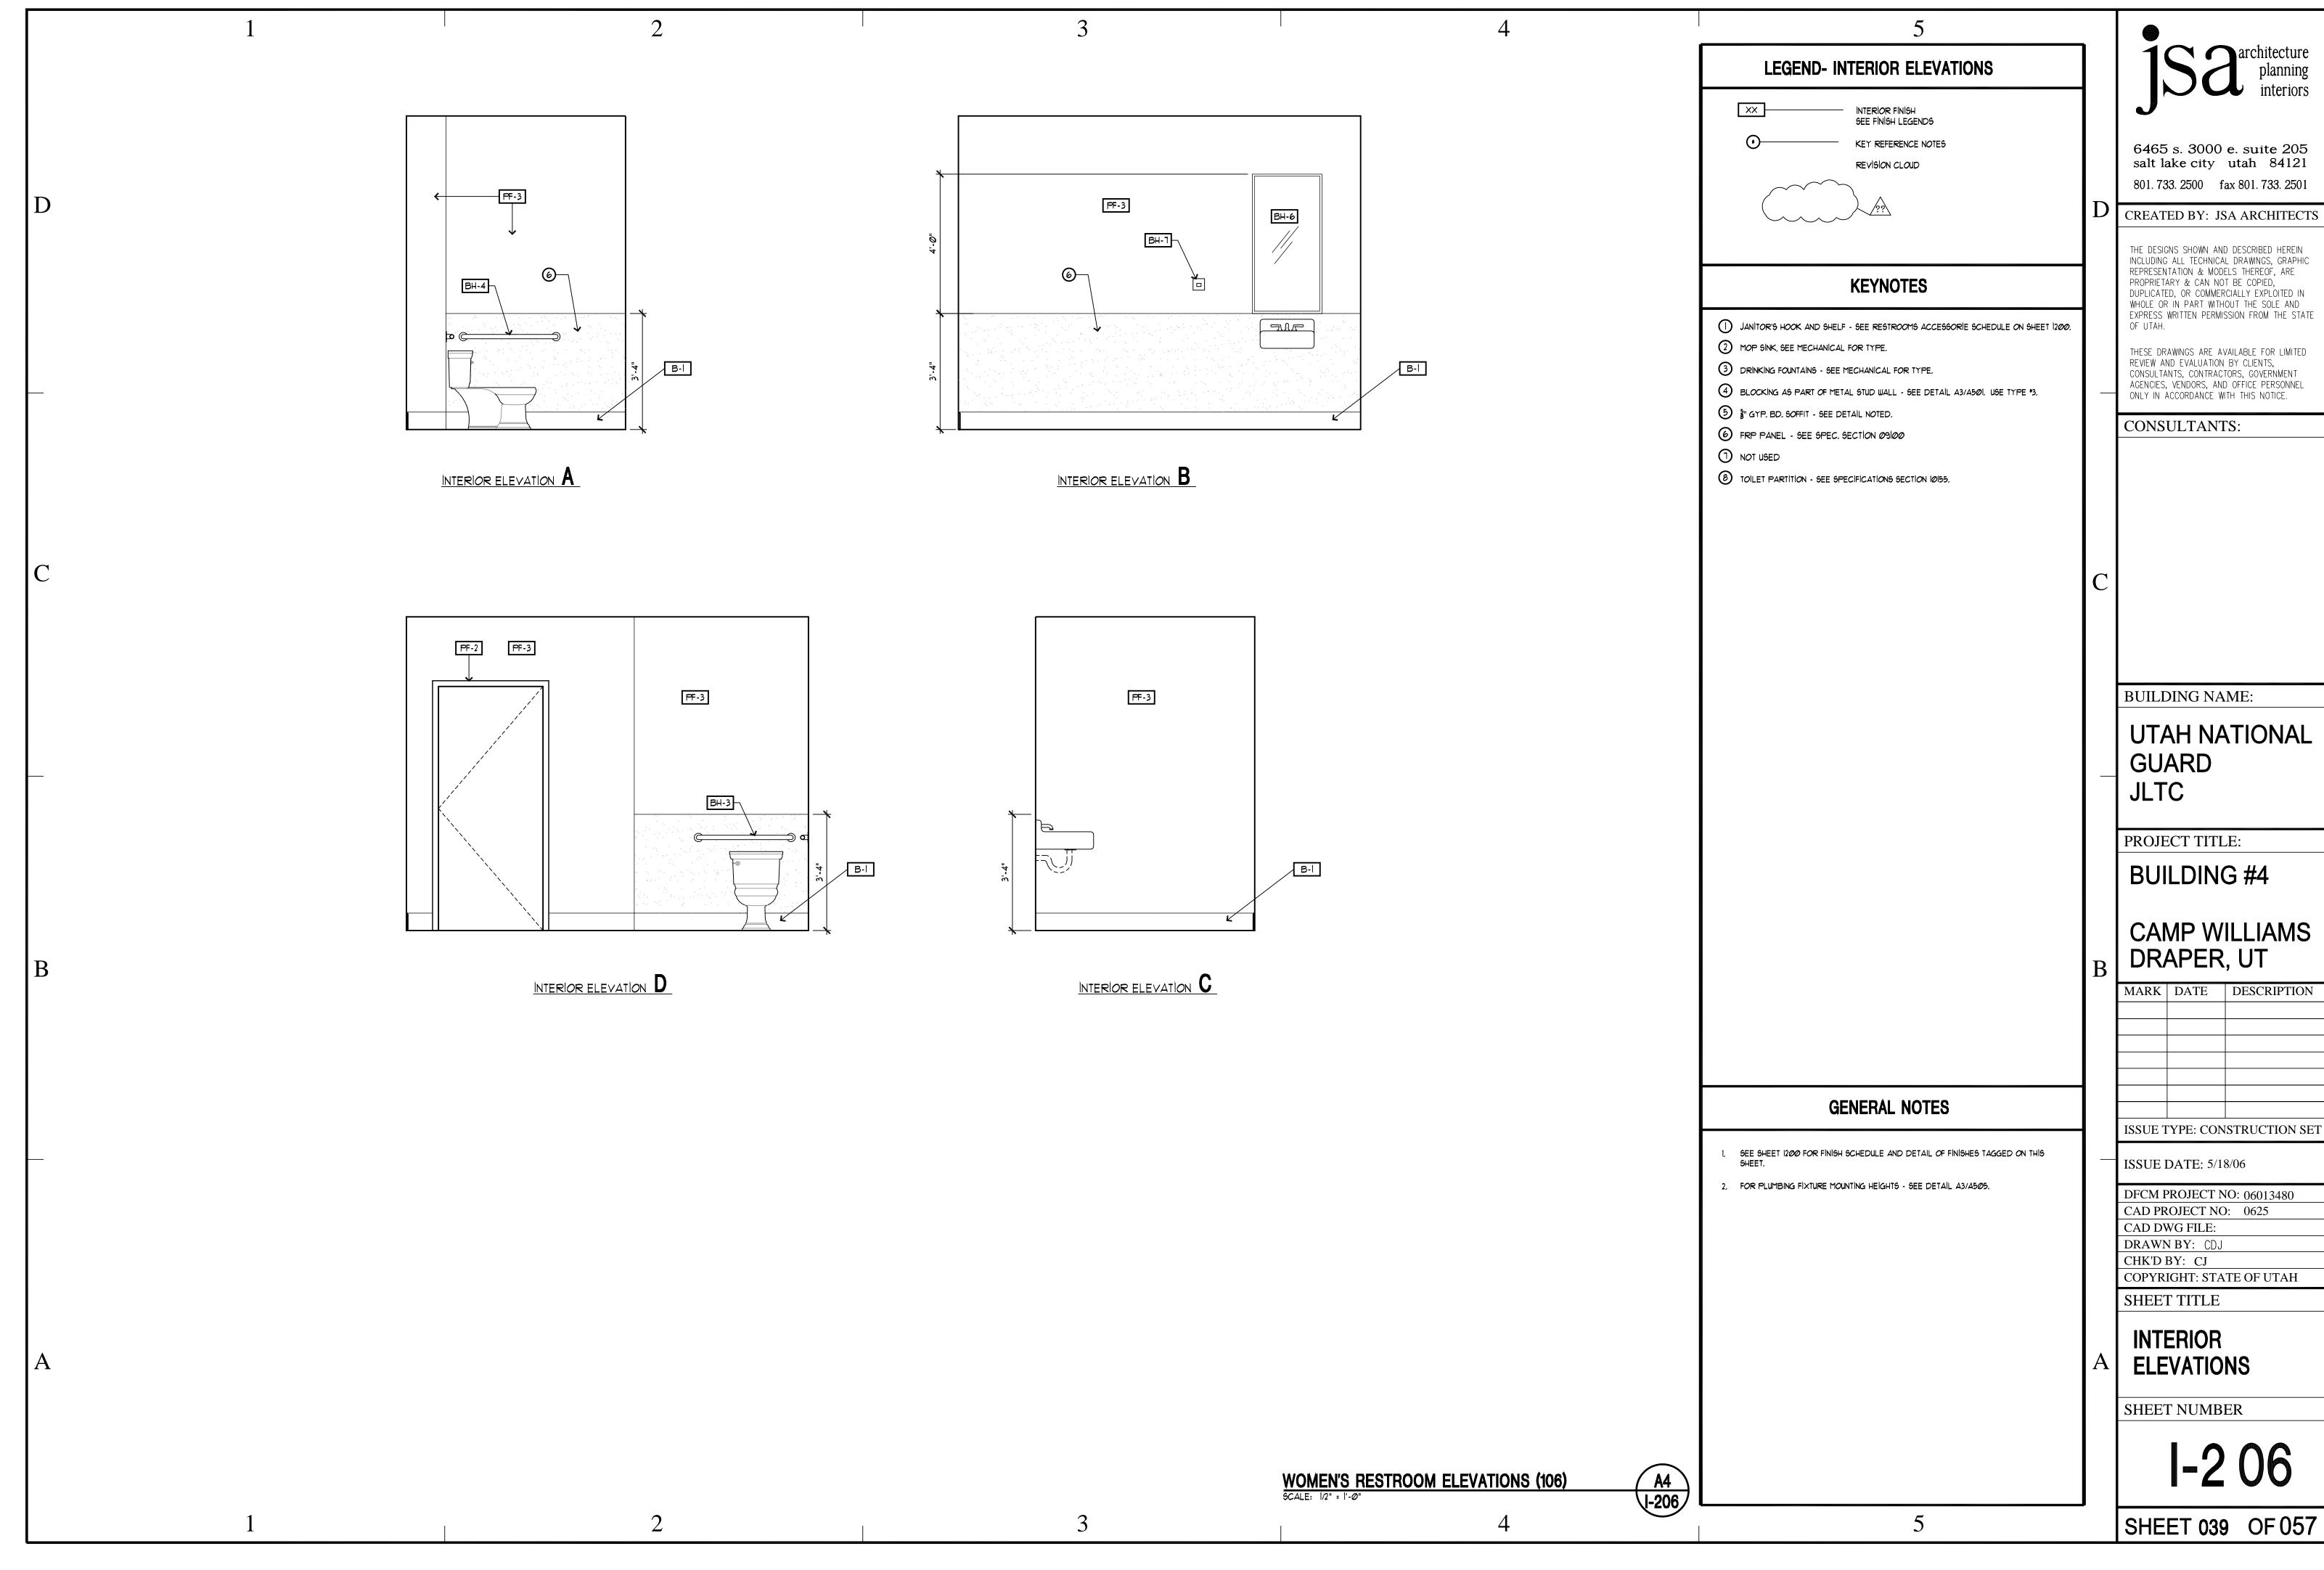


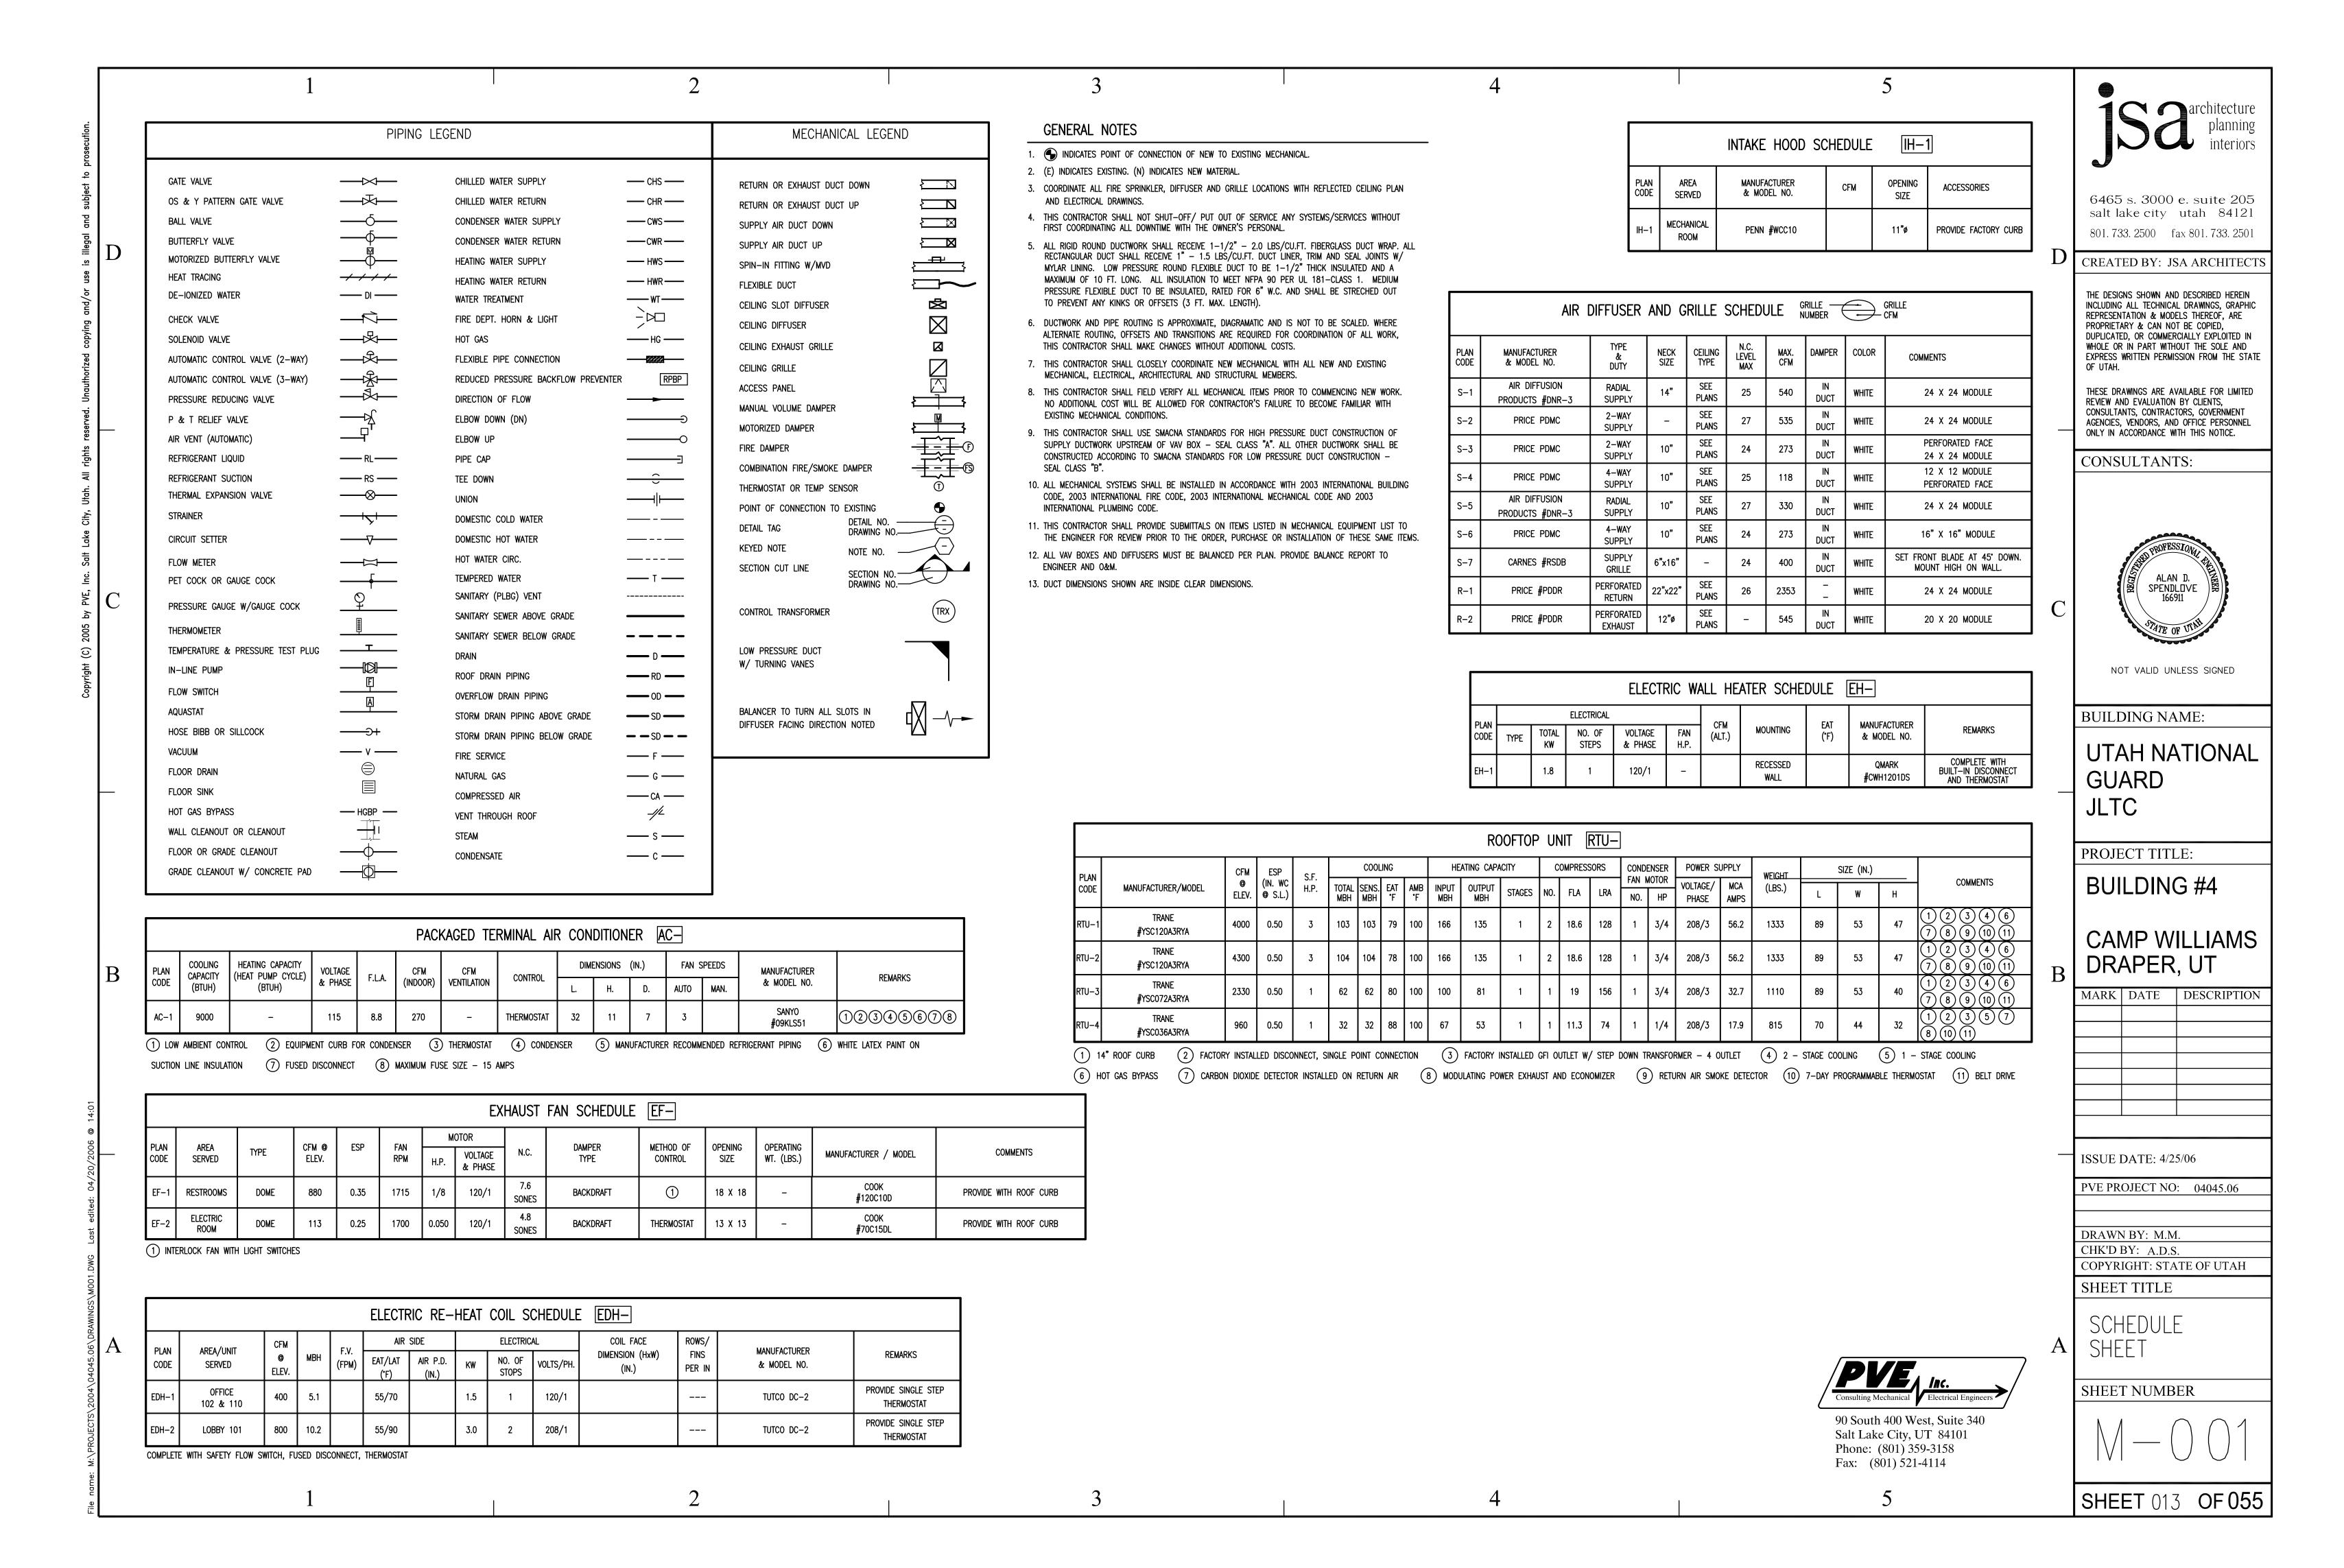

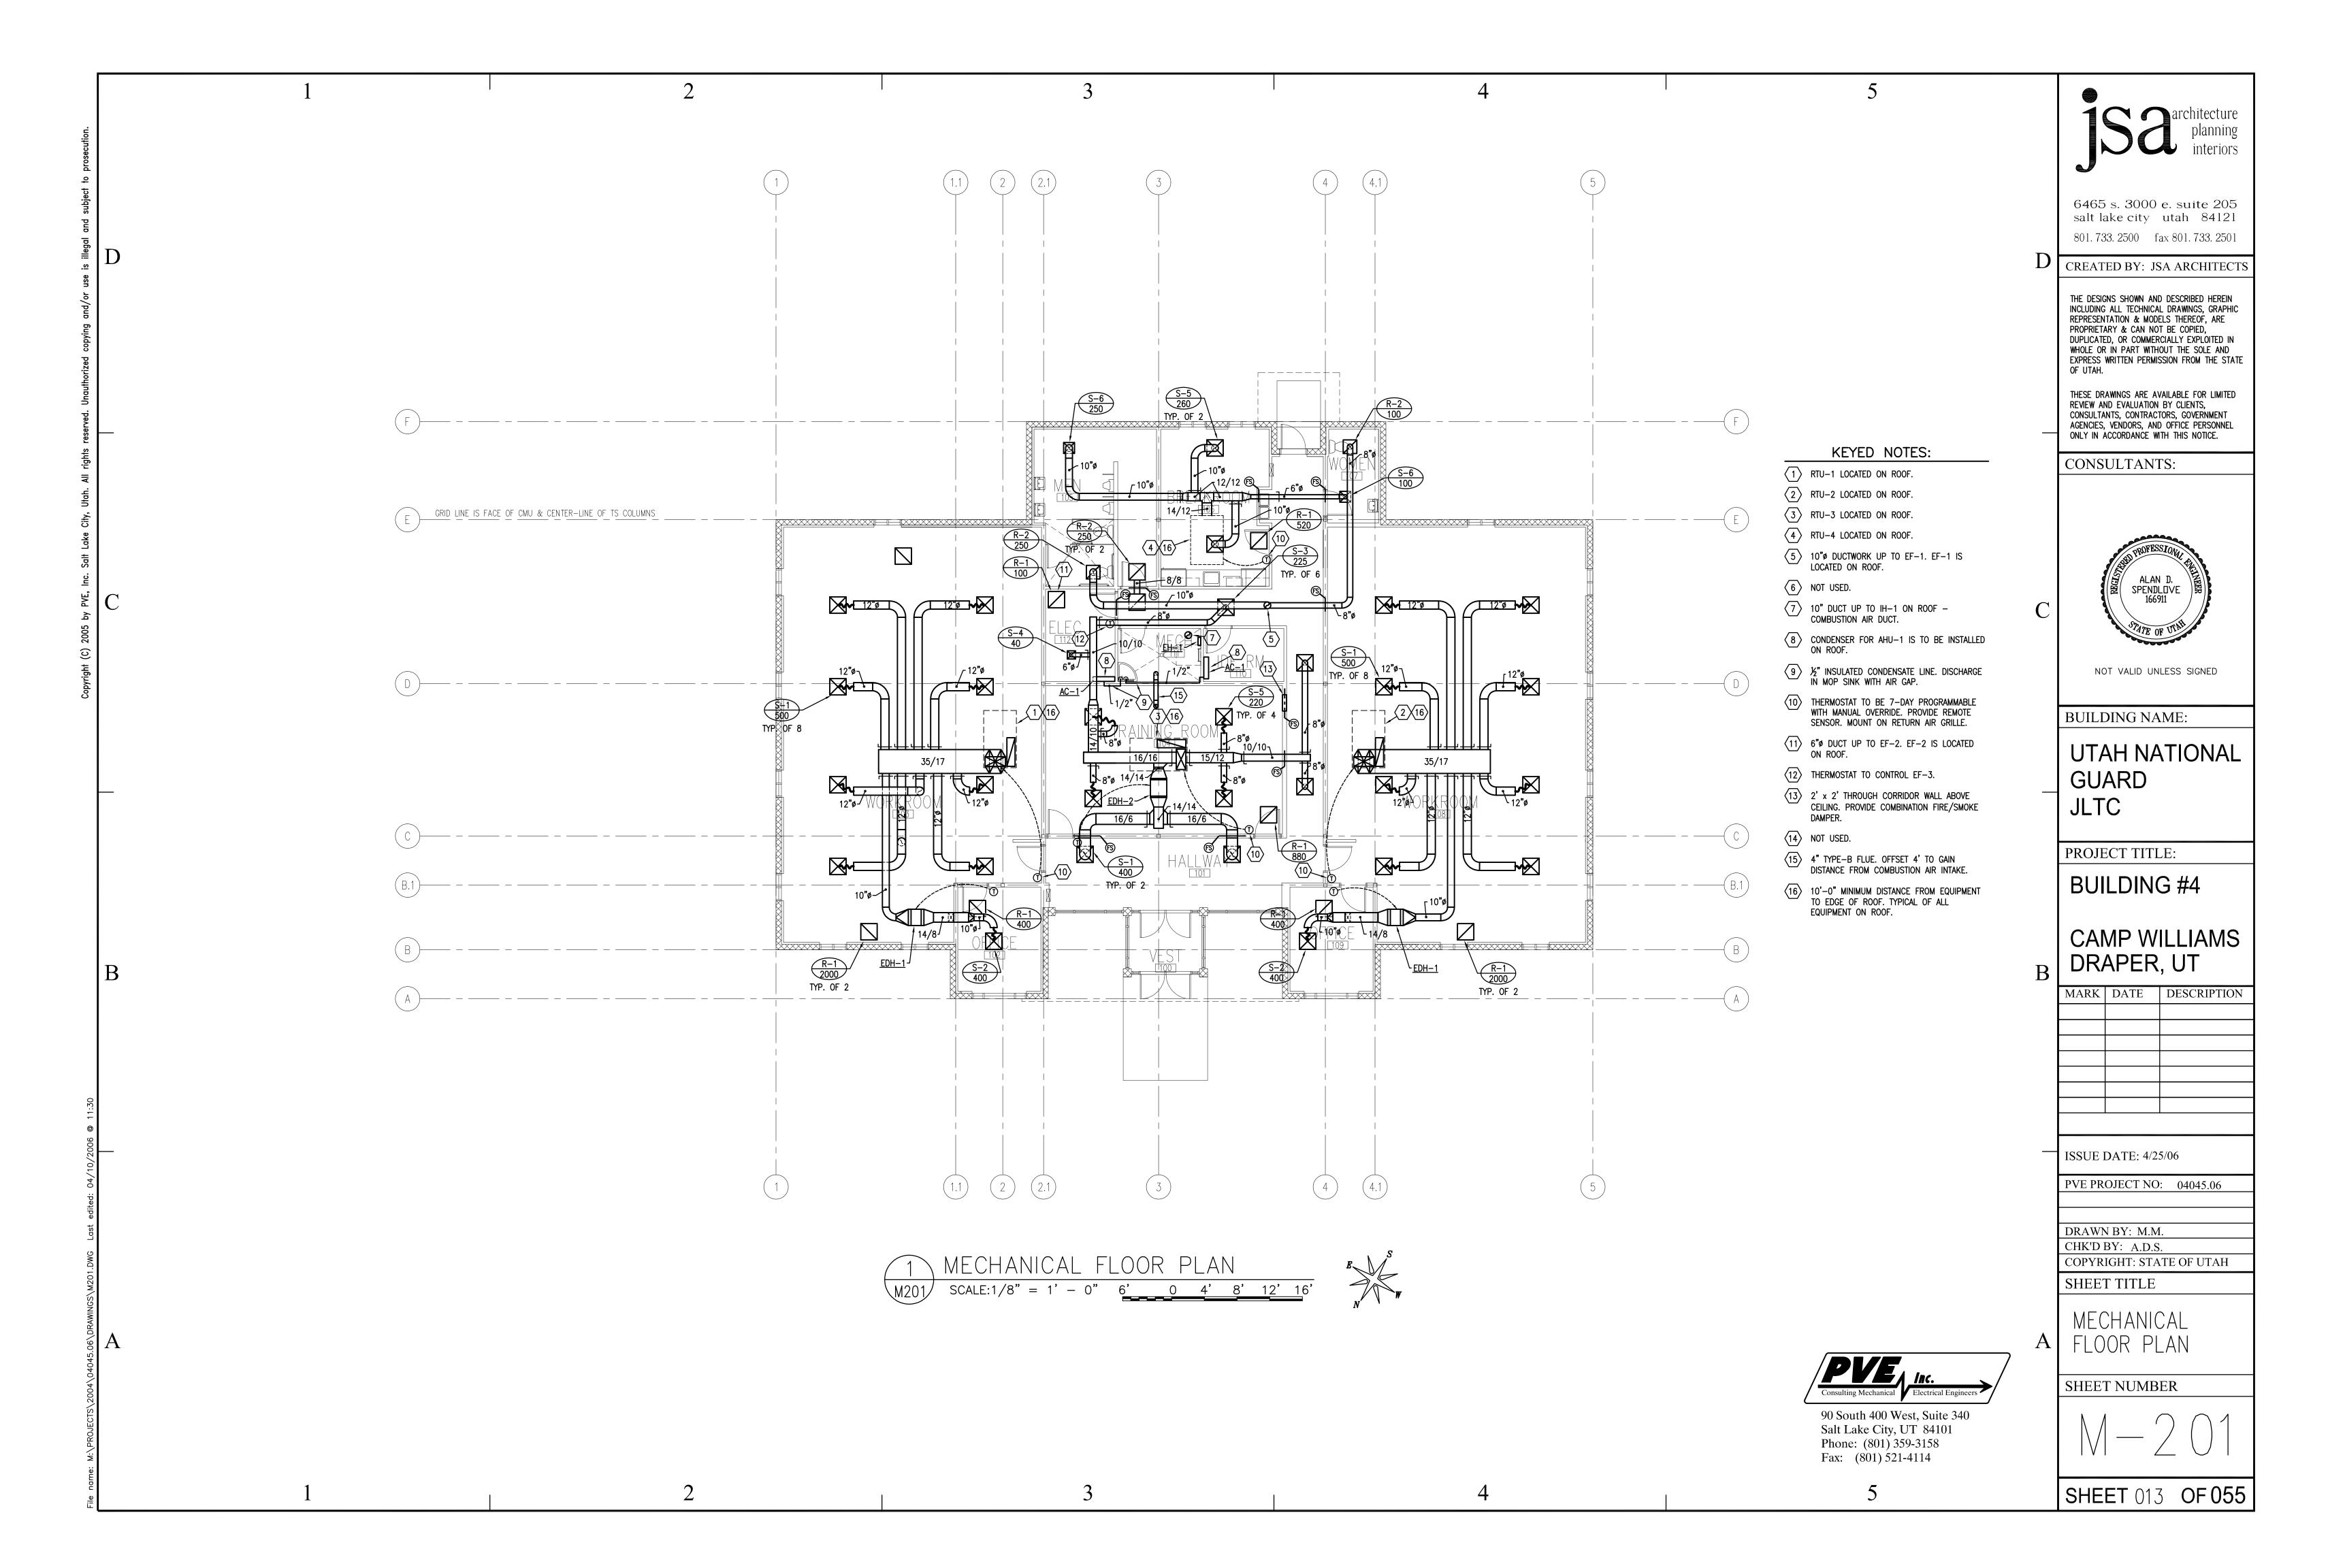

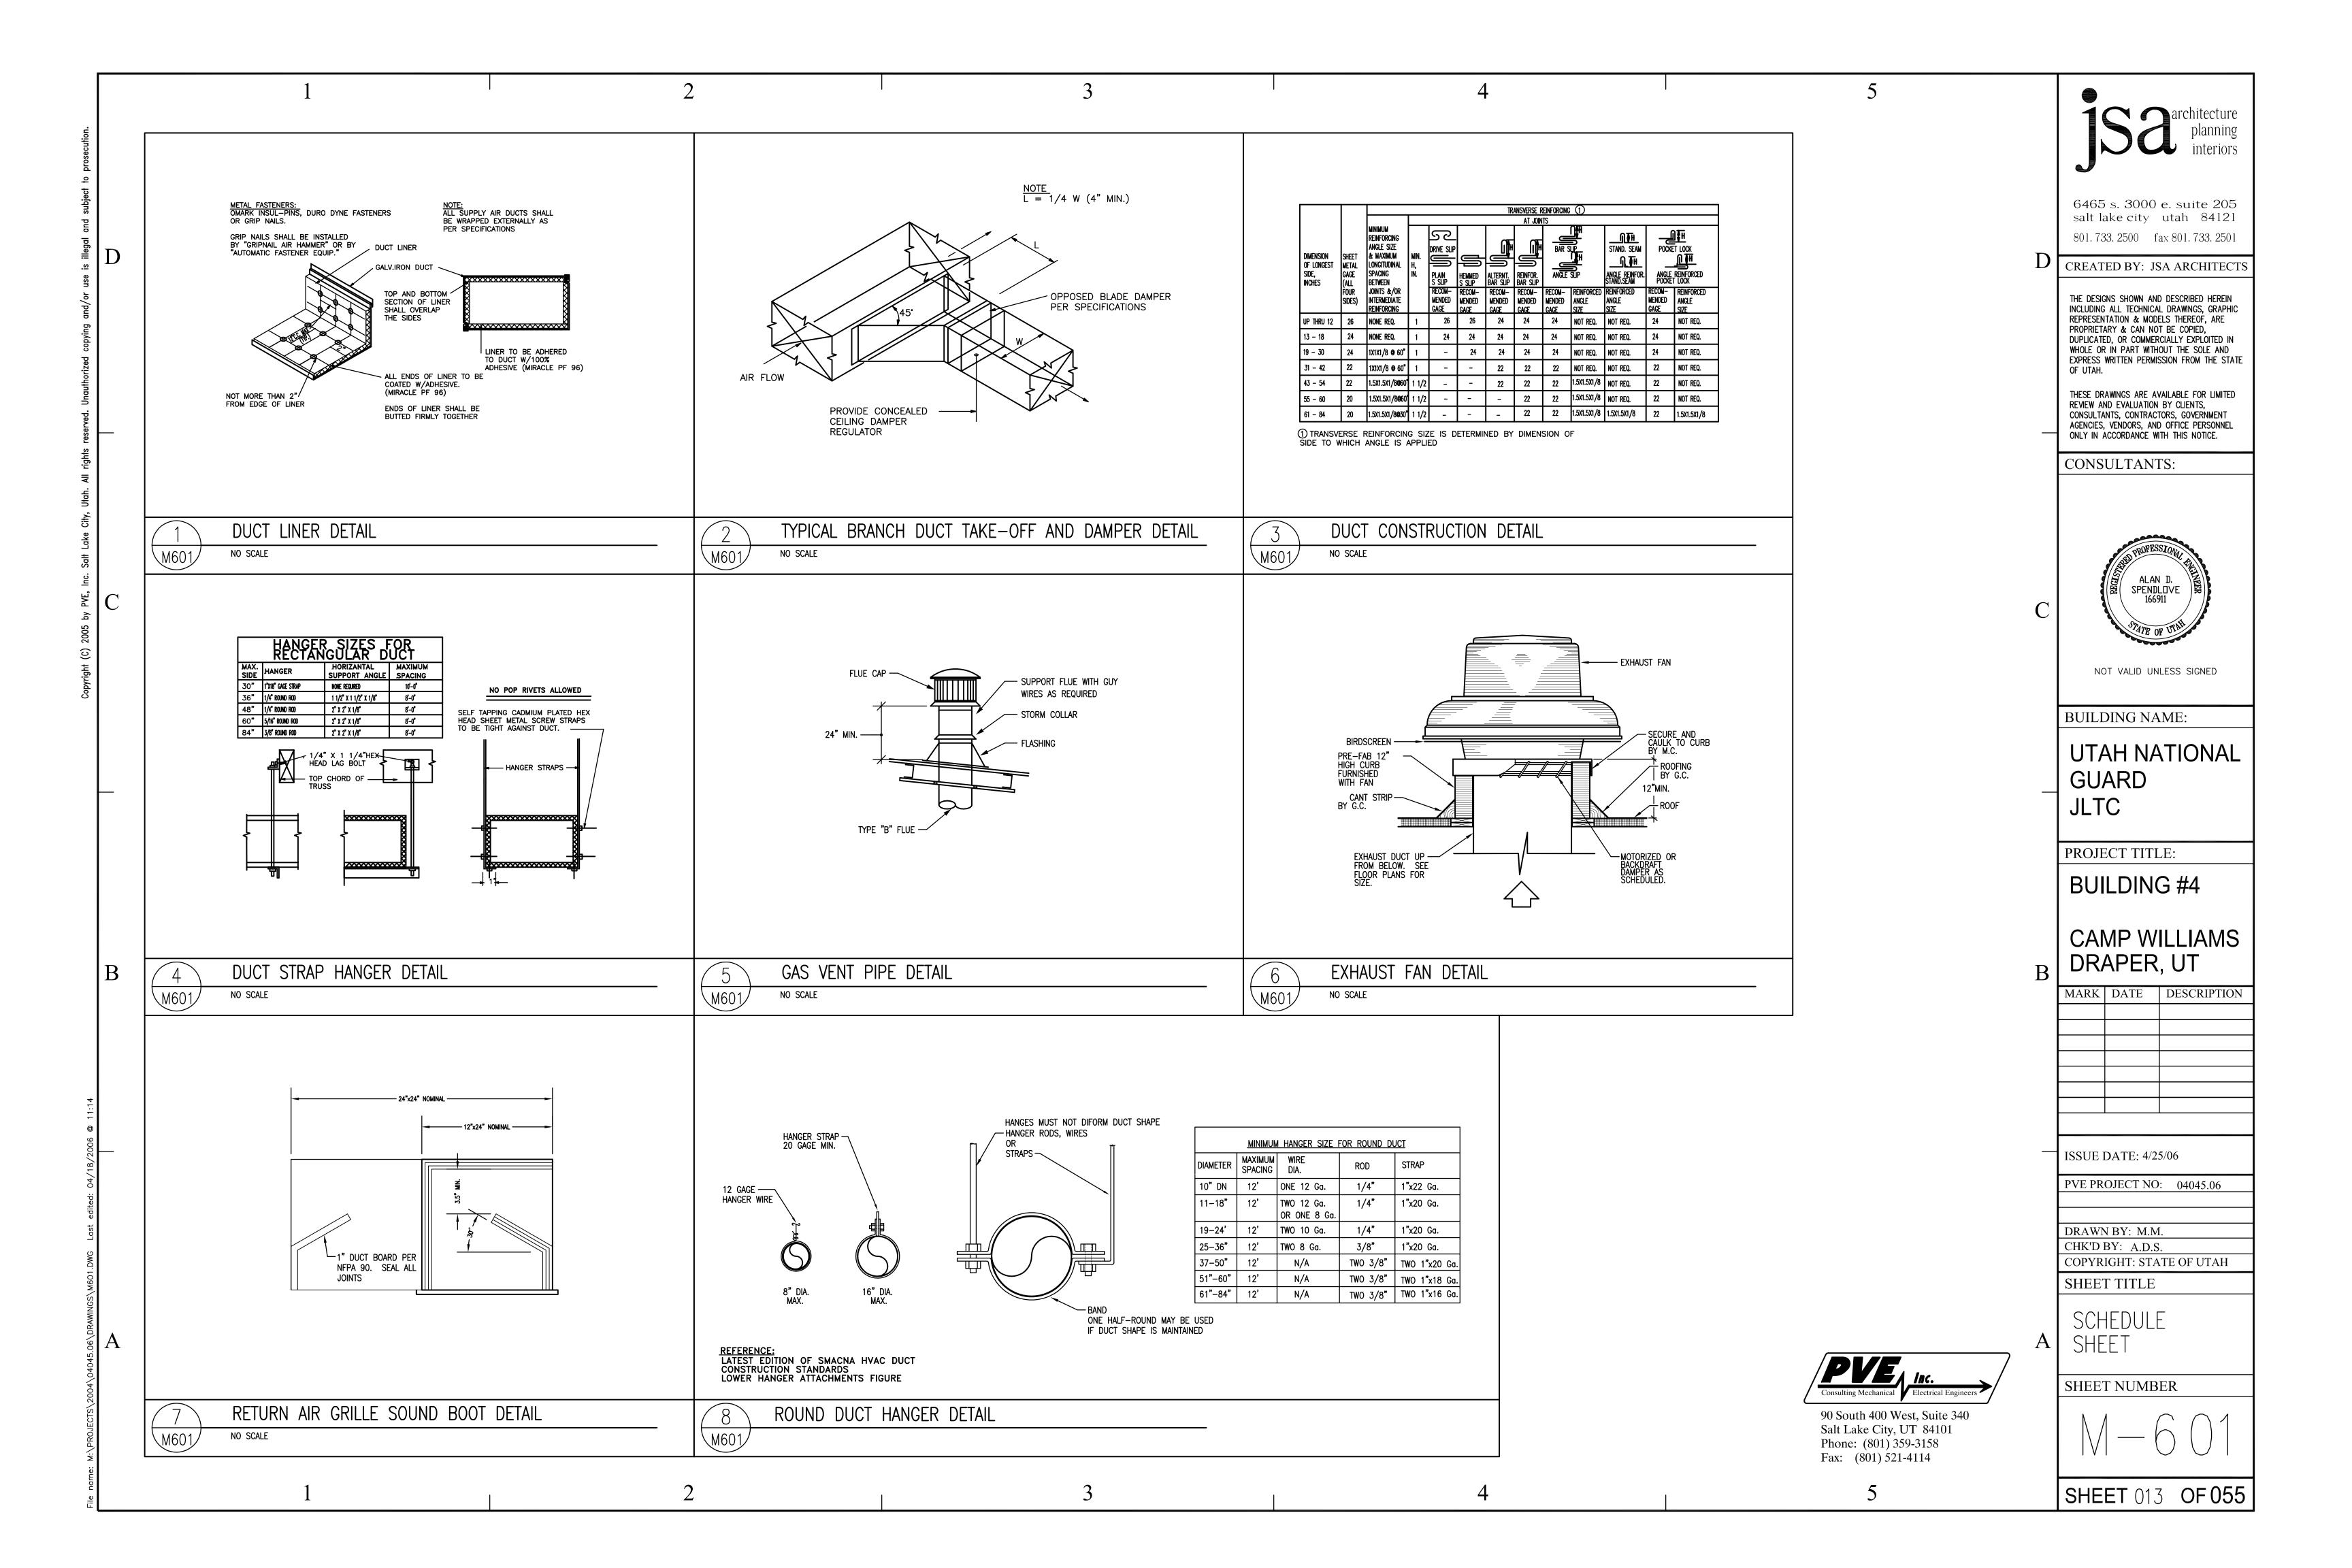

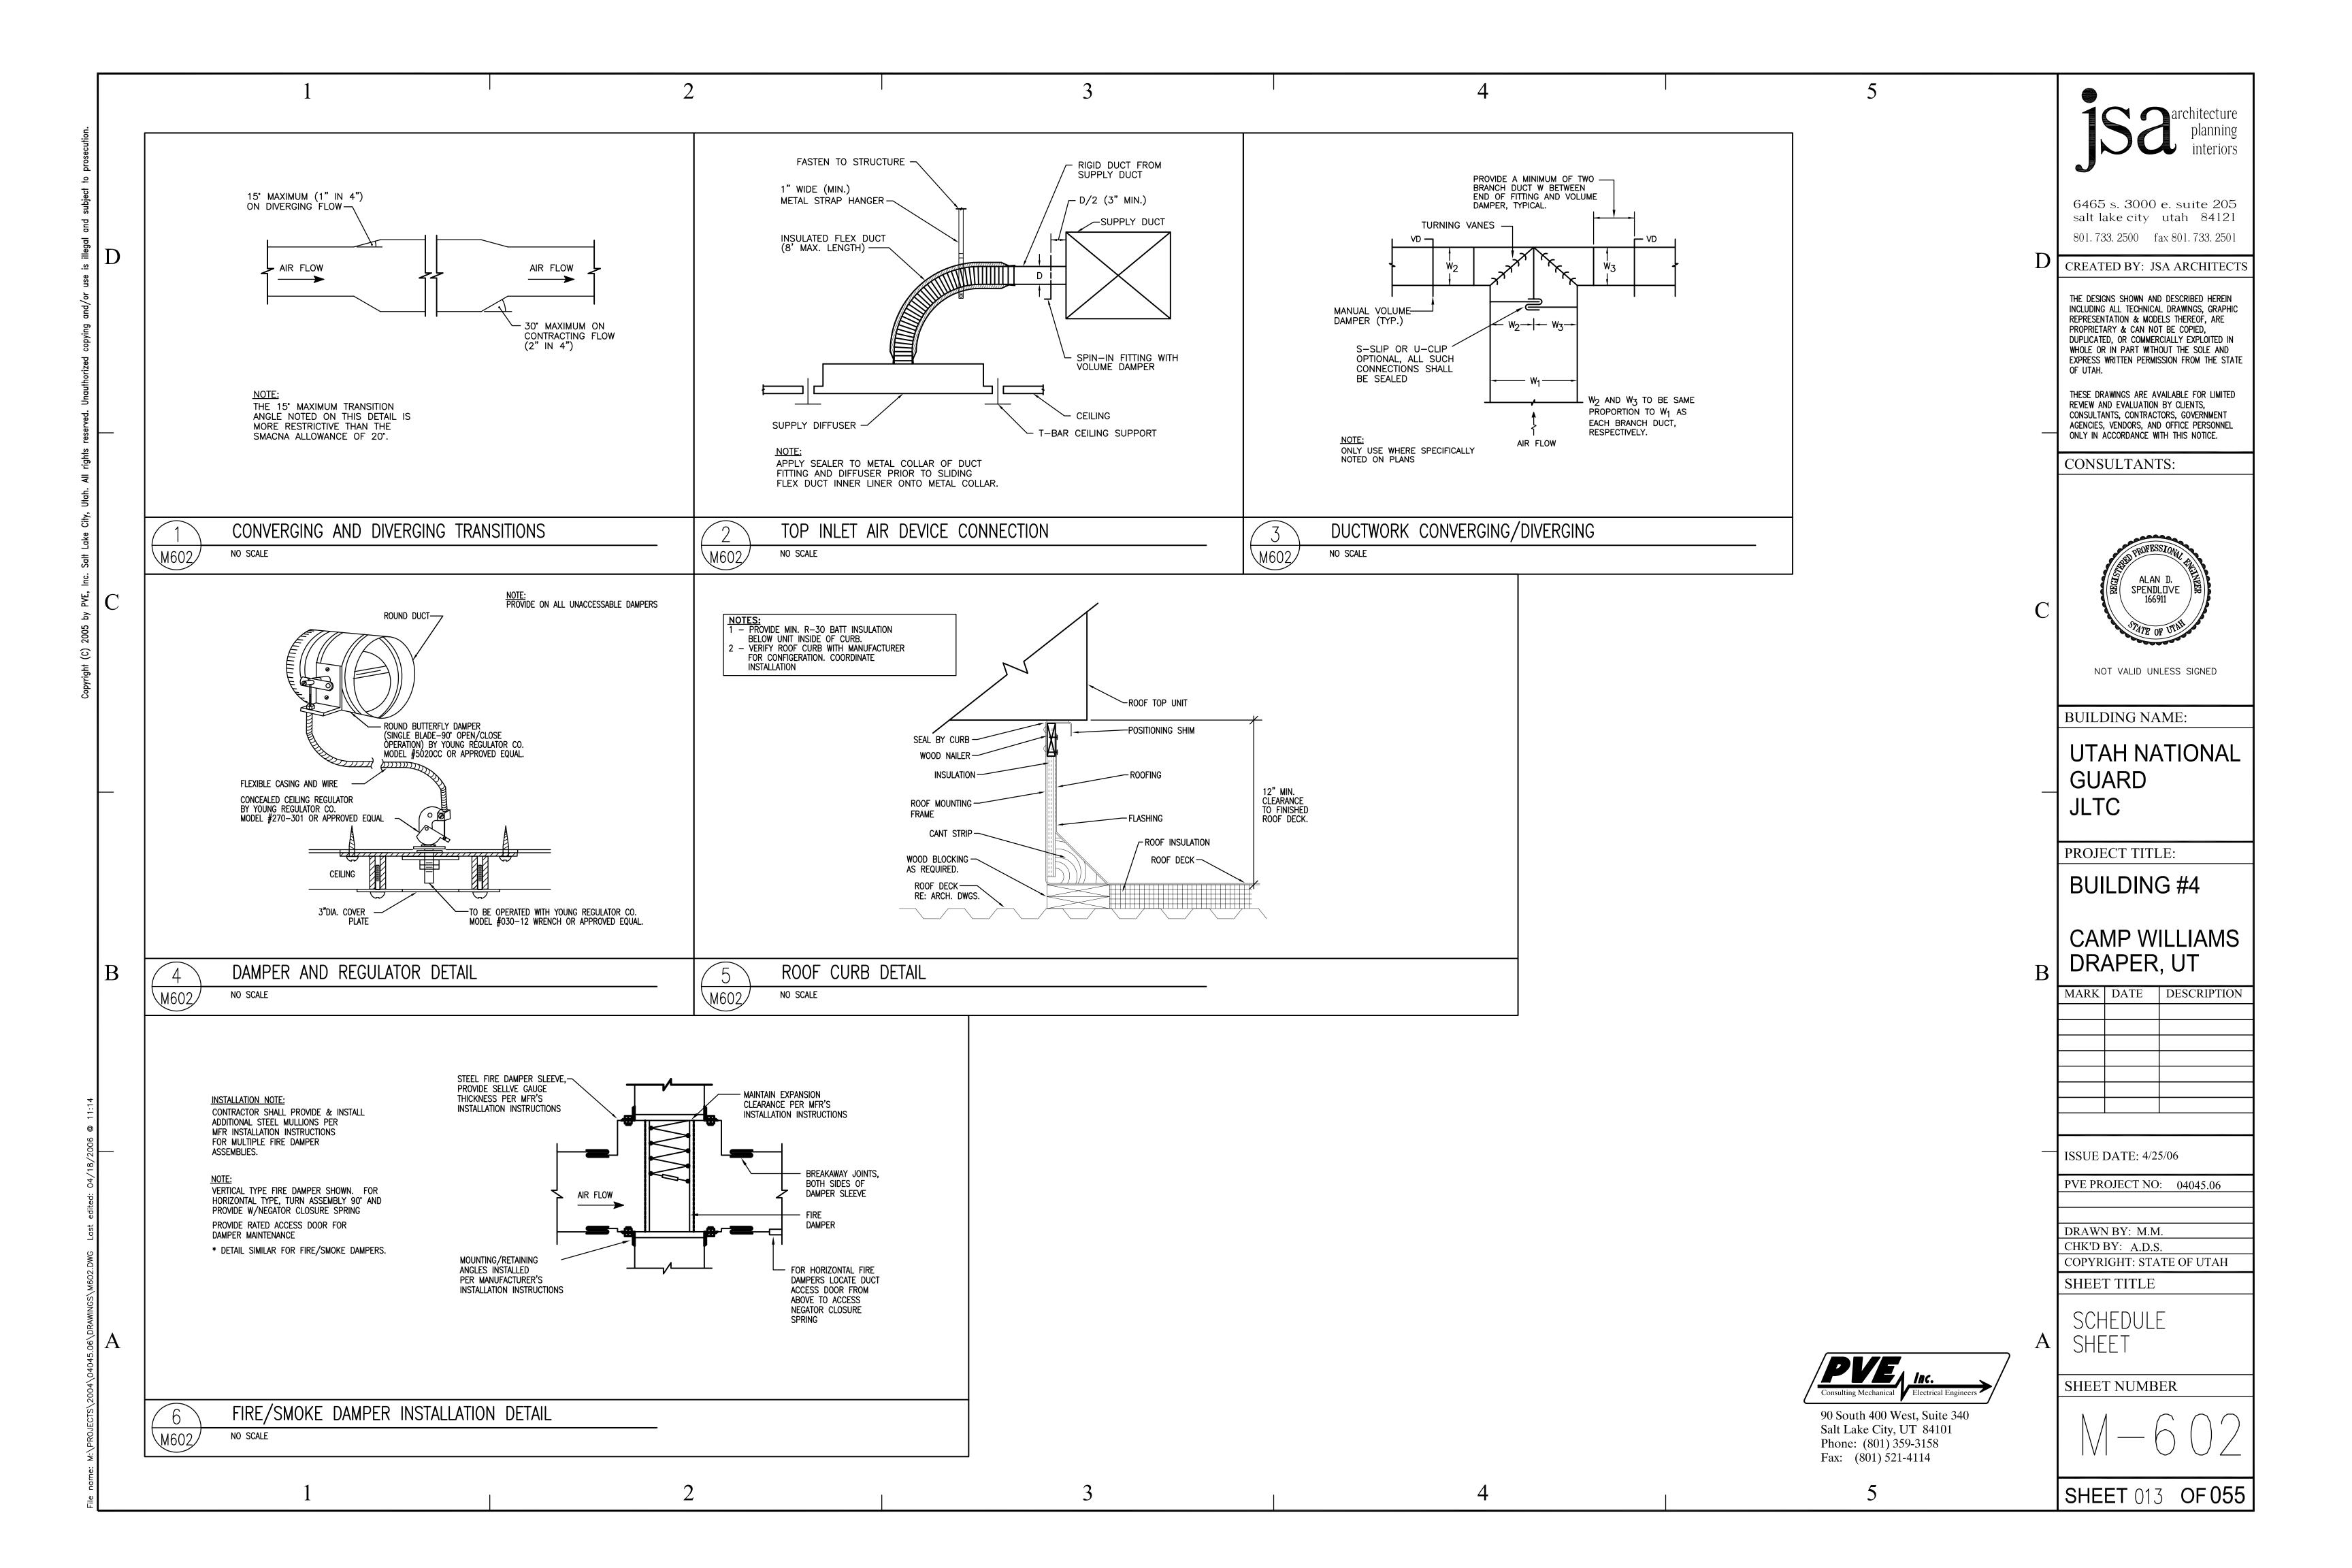

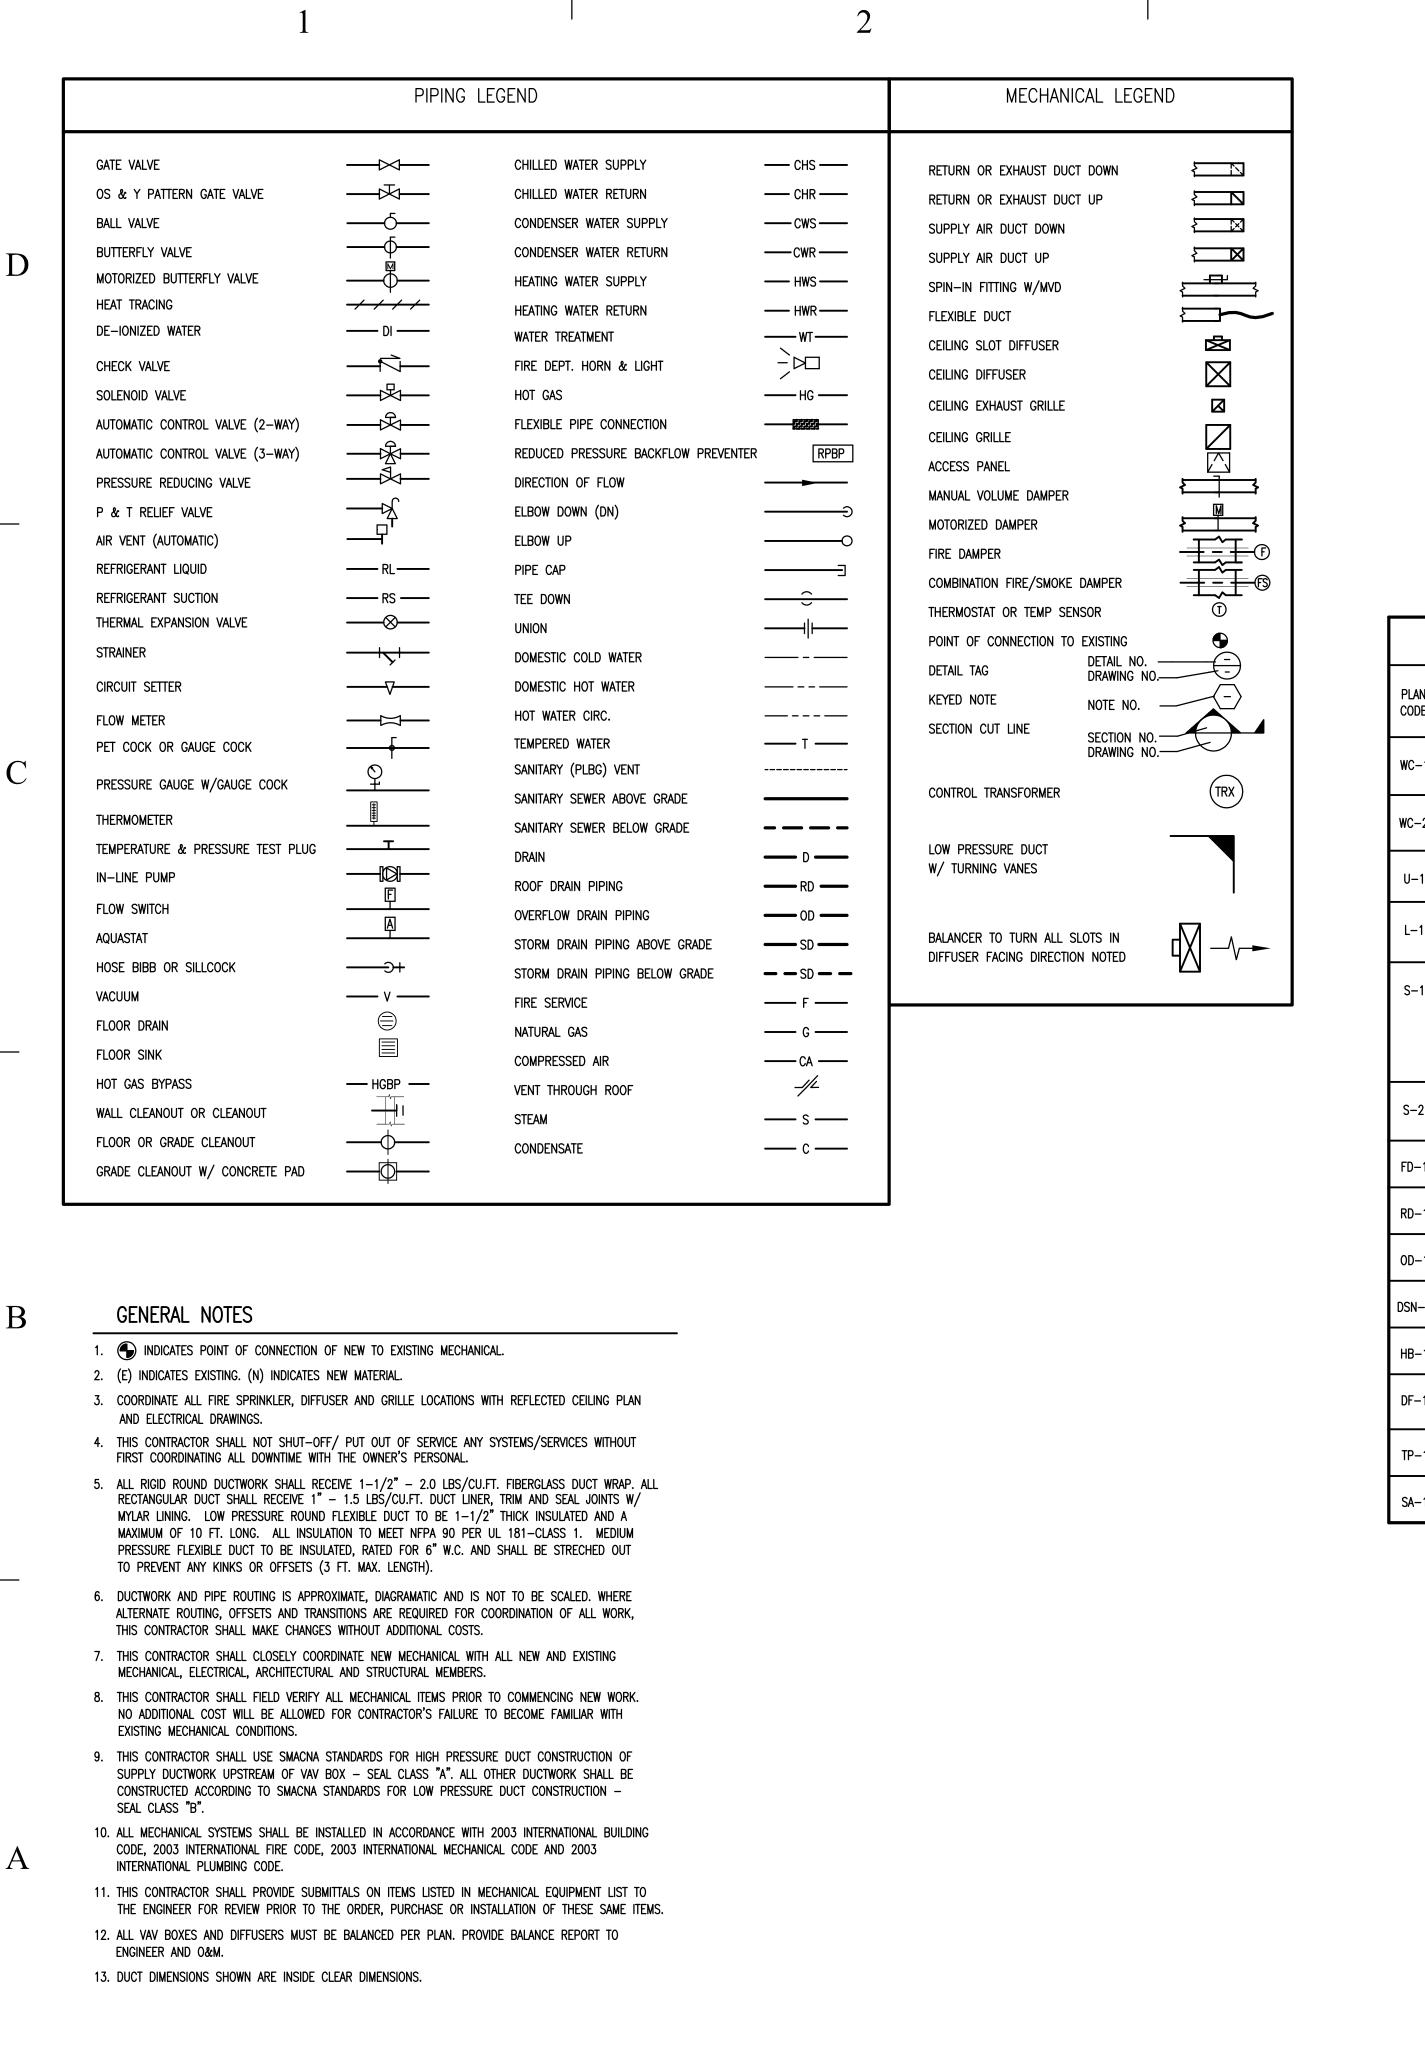

CIRCULATION PUMP SCHEDULE CP—

PLAN CODE DUTY GPM FEET PUMP RPM H.P. VOLTAGE & MANUFACTURER & MODEL NO. COMMENTS

DOMESTIC

HOT WATER

CIRCULATION

	GAS FIRED WATER HEATER SCHEDULE WH—													
PLAN CODE	INPUT (BTUH)	OUTPUT (BTUH)	EFFICIENCY %	FUEL	CAP. (GAL)	RECOVERY RATE (GPH)	TEMP. RISE (*F)	FLUE DIA.	FLUE TYPE	DIMENSIO DIAMETER (in.)	ONS HEIGHT (in.)	VOLTAGE & PHASE	MANUFACTURER & MODEL NO.	ACCESSORIES/COMMENTS
WH-1	40,000		80	NG	40	73	90	4"	TYPE B	20	51		BRADFORD WHITE #M-I-403S6EN	1234

3250

TACO

MODEL 006 PNP

120/1

STAINLESS

STEEL CARTRIDGE

1) OUTLET THERMOMETER 2) PRESSURE TEMPERATURE VALVE 3) SEDIMENT REDUCTION SYSTEM 4) INSTALL PER MANUFACTURER RECOMMENDATIONS

	PLUMBIN	IG FIXTU	RE CONN	ECTION S	SCHEDUL	E	
PLAN CODE	DESCRIPTION		CONNECT	ION SIZE		SPECIFICATIONS	
	DESCRIPTION	C.W.	H.W.	WASTE	VENT	SPECIFICATIONS	
WC-1	WATER CLOSET	1/2"		3"	2"	KOHLER K-3505 "WELLWORTH" VITREOUS CHINA, 1.4 GPF, FLOOR MOUNTED PRESSURE ASSISTED TANK TOILET. PROVIDE WITH K-4666-CA ELONGATED OPEN FRONT TOILET SEAT.	
WC-2	WATER CLOSET (HANDICAP)	1/2"		3"	2"	KOHLER K-3493 "HIGHLINE", ADA COMPLIANT, VITREOUS CHINA, 1.4 GPF, FLOOR MOUNTED PRESSURE ASSISTED TANK TOILET. PROVIDE WITH K-4666-CA ELONGATED OPEN FRONT TOILET SEAT.	
U-1	URINAL	3/4"		2"	2"	KOHLER K-4972-T, "STANWELL", ADA COMPLIANT, VITREOUS CHINA, 1¼" TOP SPUD. 1.0 GPF. WALL MOUNTED, SLOAN #8180 G2 OPTIMA PLUS FLUSH VALVE. FLUSH VALVE TO HAVE MANUAL OVERRIDE. MOUNT URINAL AT 17" AFF	
L-1	WALL HUNG LAVATORY	1/2"	1/2"	1-1/2"	1-1/2"	KOHLER WHITE K-2005 "KINGSTONE", WALL HUNG VITREOUS CHINA, WITH 4" FAUCET CENTERS, K-7605 ANGLE SUPPLIES WITH STOPS, K-8998 1-1/4" CAST BRASS P-TRAP, POP-UP DRAIN. FAUCET TO BE MOEN SINGLE-LEVER "VILLETA" #L4701 WITH CHROME GRID DRAIN. PROVIDE McGUIRE PRO-WRAP INSULATION ON P-TRAP AND SUPPLIES.	
S-1	KITCHEN SINK	1/2"	1/2"	2"	2"	"JUST" 18 GA. STAINLESS STEEL SINK. 18"x32" OUTSIDE DIMENSIONS; 7½" DEEP. TYPE 304 STAINLESS, SOUND DEADENED. "JUST" J-901 DECK MOUNTED SINGLE LEVER WASHERLESS MIXING FAUCET WITH ESCUTCHEON AND 8" SPOUT WITH AERATOR. "JUST" J-35-316 STAINLESS STEEL CRUMB CUP STRAINERS WITH REMOVABLE BASKET, FLEXIBLE CHROME PLATED SUPPLIES WITH STOPS, CAST BRASS P-TRAPS WITH CLEANOUT PLUG. DISPOSAL — STAINLESS STEEL INTERNAL CONSTRUCTION, AUTOMATIC REVERSING ACTION, QUICK—LOCK MOUNTING, PERMANENTLY LUBRICATED BEARINGS, DISHWASHER DRAIN CONNECTION, OVERLOAD PROTECTION W/MANUAL RESET. ½ HP	
S-2	MOP SINK	1/2"	1/2"	3"	2"	KOHLER #K-6710, 28"x28" ENAMELED CAST IRON FLOOR MOUNTED CORNER MODEL. K-9146-3 3" DRAIN W/STRAINER AND SOCKET, # K-8940 REMOVABLE VINYL COATED GUARD. K-8940 FAUCET W/VACUUM BREAKER, SCREWDRIVER STOPS IN SHANKS, 5' RUBBER HOSE AND WALL HOOK.	
FD-1	FLOOR DRAIN			SEE PLANS	2"	JOSAM 2" FLOOR DRAIN, #3000-5A, STAINLESS STEEL OR NICKEL BRONZE STRAINER. ADJUSTABLE STRAINER, TRAP PRIMER, PROVIDE PRO-SET TRAP GUARD. PROVIDE SQUARE STRAINER FOR MENS SHOWER ROOM.	
RD-1	ROOF DRAIN			4"		JR SMITH #1010 W/FLASING CLAMP, UNDER DECK CLAMP, CAST IRON DOME, INSULATE BOTTOM OF ROOF DRAIN BOWL AND DRAIN PIPE.	
OD-1	OVER FLOW ROOF DRAIN			4"		JR SMITH #1080 W/FLASING CLAMP, UNDER DECK CLAMP, CAST IRON DOME, 2½" WATER DAM, INSULATE BOTTOM OF ROOF DRAIN BOWL AMD DRAIN PIPE.	
DSN-1	OVER FLOW ROOF DRAIN NOZZLE			4"		JR SMITH #1770-PB DOWNSPOUT NOZZLE.	
HB-1	HOSE BIBB	1/2"				JRSMITH #5519, COMPLETE WITH STAINLESS STEEL FLUSH MOUNTED BOX, NON-FREEZE VALVE AND VACUUM BREAKER, 1/4 TURN HYDRANT.	
DF-1	DRINKING FOUNTAIN	1/2"		1 1/2"	1 1/2"	HAWS #HWBFA8L, HI-LO BARRIER FREE. 7.7 GPH, 115 VOLT, R134A REFRIGERANT, CHROME PLATED BRASS BUBBLE HEAD, SELF-LUBRICATING FAN MOTOR. PUSH DOWN BARS TO ACTIVATE WATER DELIVERY, ADA COMPLIANT. BRUSHED STERLING VINYL FINISH. WATER TEMPERATURE 50°F.	
TP-1	TRAP PRIMER	1/2"				MIFAB M-500, PRESSURE DROP ACTIVATED TRAP SEAL PRIMER, W/MIFAB MI-GAP DISTRIBUTION UNIT. PROVIDE ACCESS DOOR TO TRAP PRIMER.	
SA-1	SHOCK ABSORBER	1/2"				JOSAM #75000 SERIES, STAINLESS STEEL, SEE PLANS FOR SIZE. PROVIDE ACCESS DOOR. SEE ARCHITECT FOR COLOR OF DOOR.	

1 Sarchitecture planning interiors

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CONSULTANTS:



NOT VALID UNLESS SIGNED

BUILDING NAME:

UTAH NATIONAL GUARD JLTC

PROJECT TITLE:

BUILDING #4

CAMP WILLIAMS DRAPER, UT

MARK	DATE	DESCRIPTION								

ISSUE DATE: 4/25/06

PVE PROJECT NO: 04045.06

DRAWN BY: M.M.
CHK'D BY: A.D.S.

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SHEET TITLE

SCHEDULE SHFFT

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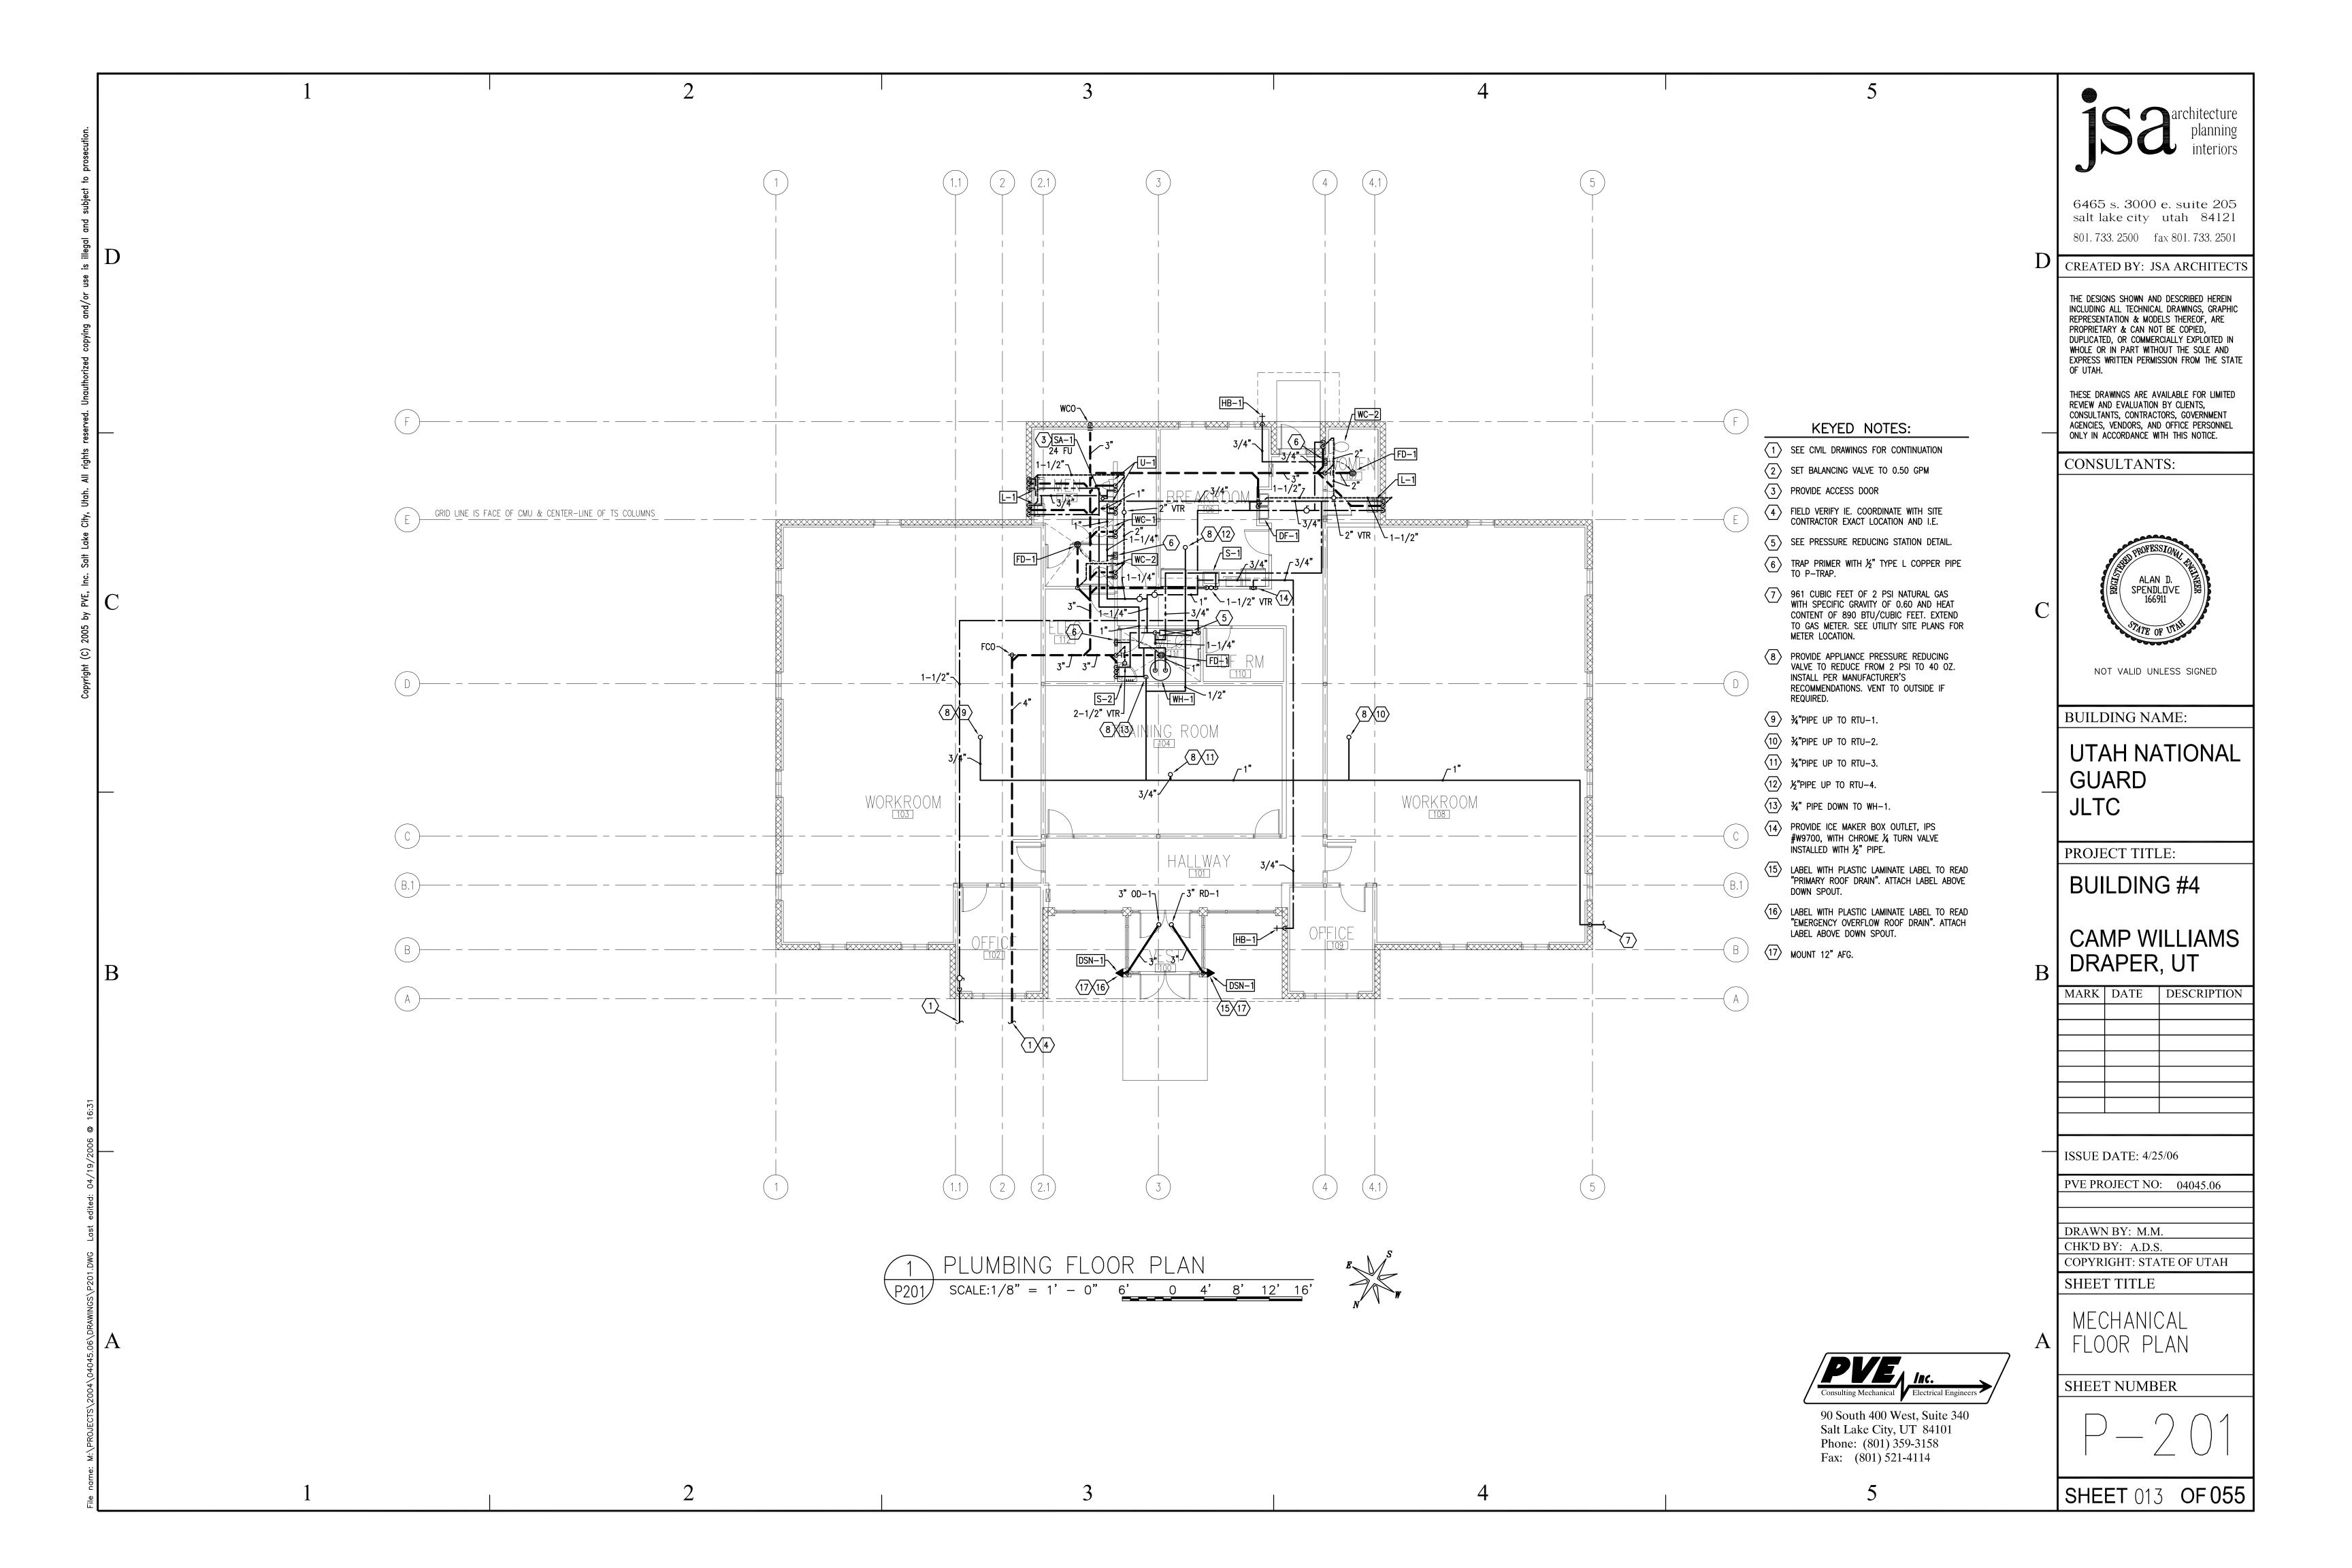
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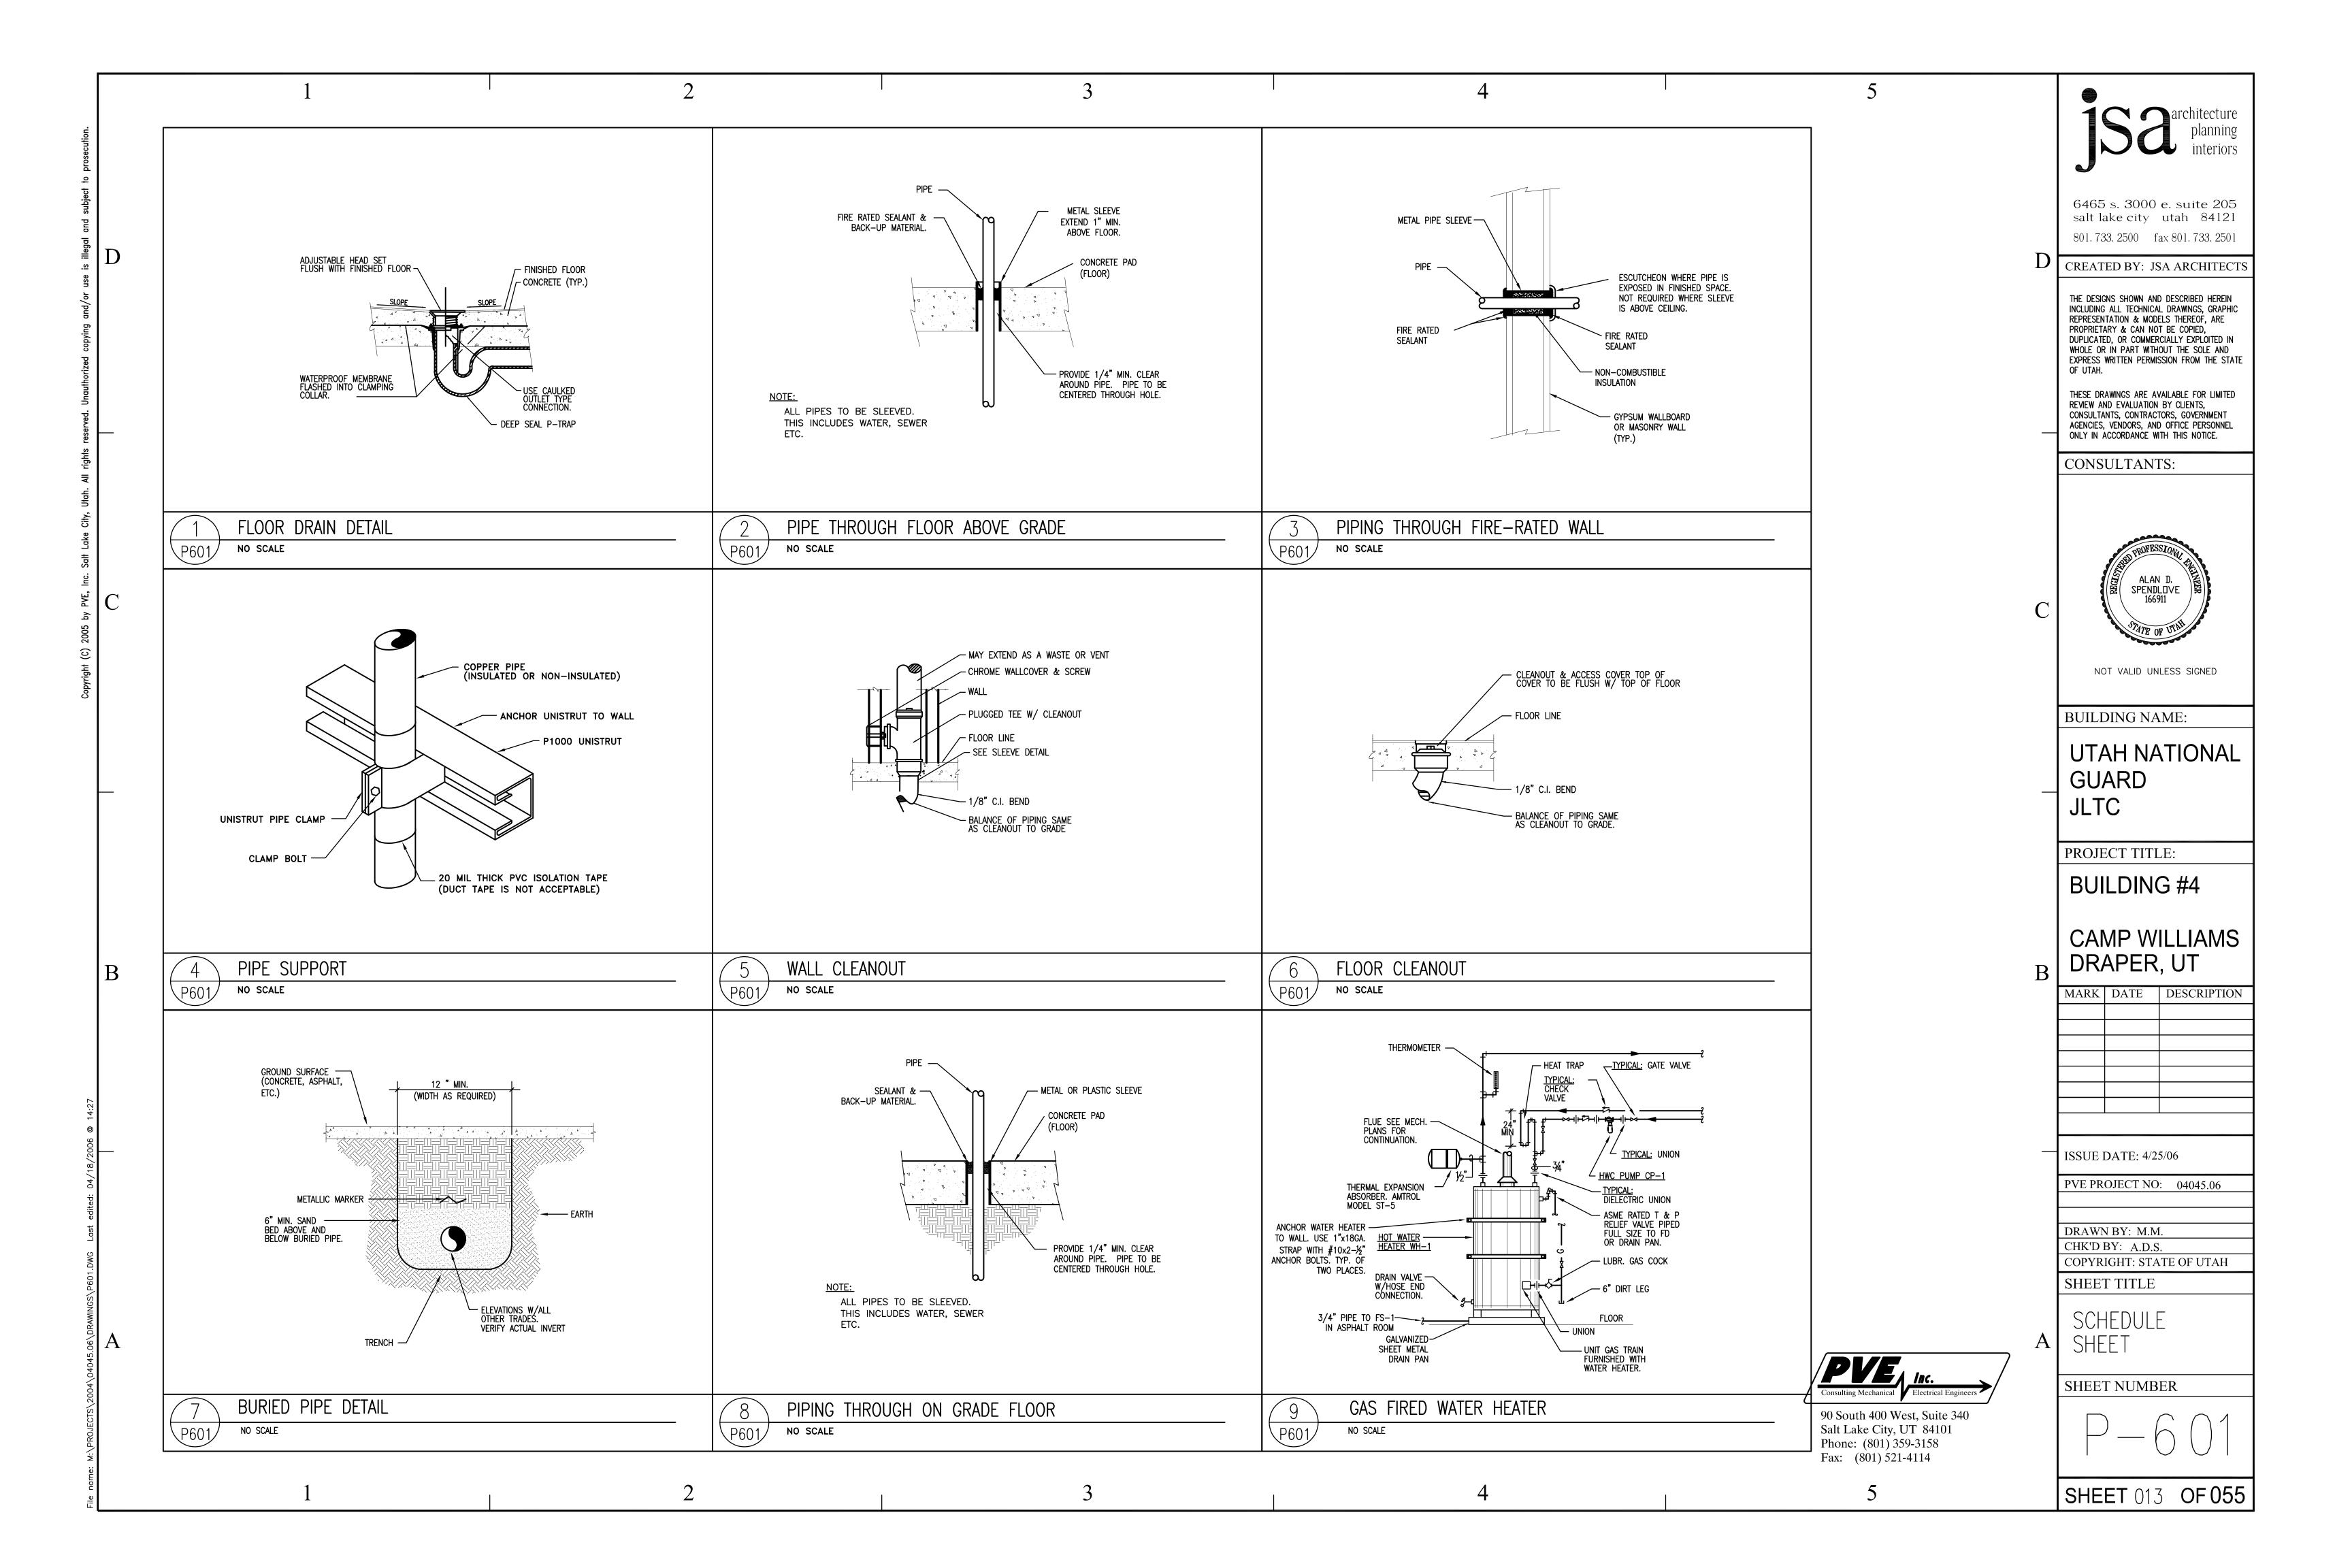
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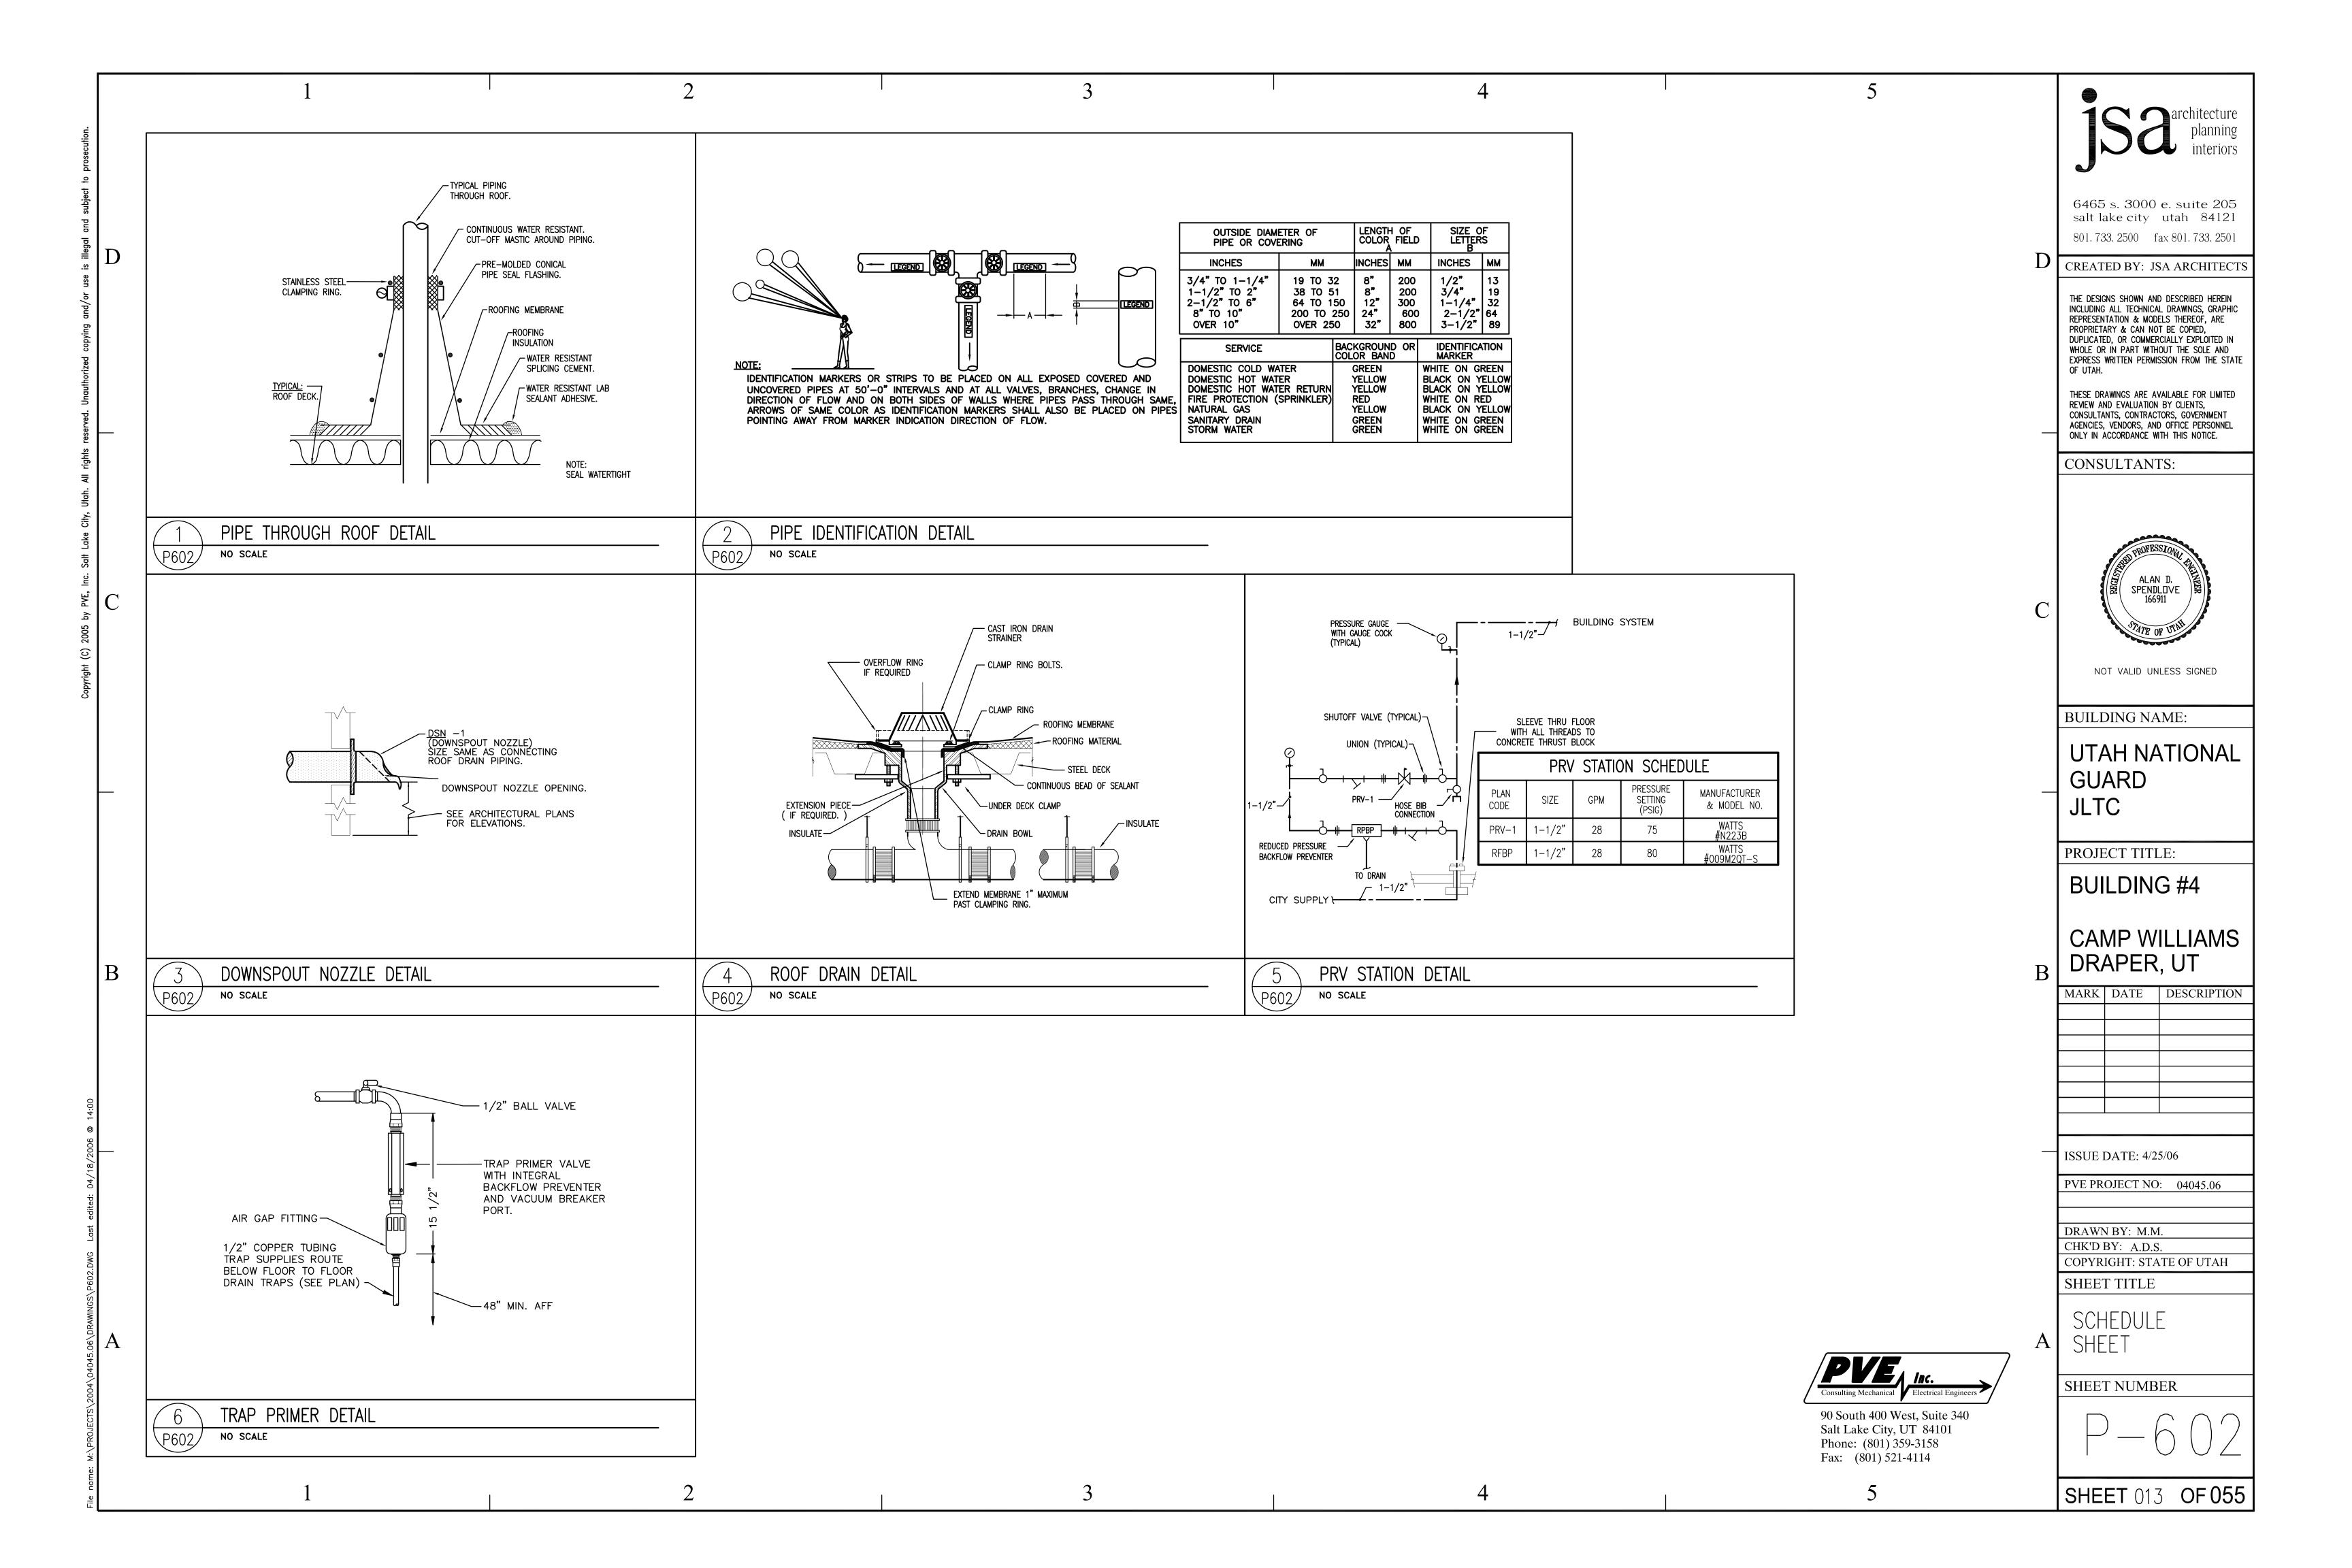
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	1	2	3	4	5	
	LIGHTING SYSTEMS SYMBOL LIST	IICHTING	FIXTURE SCHEDULE	GENERAL NOTES:		1 C architecture
	SYMBOL DESCRIPTION	SYMBOL DESCRIPTION	LAMPS APPROVED MANUFACTURERS CATALOG NUMBER	① REFER TO THE ARCHITECTURAL REFLECTED CEILING PLANS FOR THE EXACT	(38) ELECTRICAL CONTRACTOR SHALL VERIFY ALL ELECTRICAL LOADS (VOLTAGE,	planning interiors
	LIGHTING SYMBOLS	2' x 4' LAY-IN FLUORESCENT FIXTURE, 3 LAMP, PARABOL LENS, 18 CELL, SEMI-SPECULAR FINISH, UNIVERSAL		LOCATION OF ALL LIGHTING FIXTURES. (2) THE COLOR OF THE LIGHT FIXTURES SHALL BE SELECTED BY THE ARCHITE	PHASE, CONNECTION REQUIREMENT, ETC.) OF EQUIPMENT FURNISHED UNDER OTHER DIVISIONS WITH APPROVED SHOP DRAWINGS. REFER TO BEGINNING	
-	RECESSED FLUORESCENT FIXTURE SURFACE MOUNTED FLUORESCENT FIXTURE	T-I VOLTAGE BALLAST.	T8 METALUX (2EP3GX SERIES EQUAL) LIGHTOLIER (DPA SERIES EQUAL)	(3) MINIMUM SIZE OF CONDUIT TO BE 3/4". ALUMINUM CONDUITS SHALL NOT BE USED.	(39) THE CONTRACTOR SHALL INFORM THE ARCHITECT/ENGINEER IN WRITING OF ANY	3115 e. lion lane suite 300
	FLUORESCENT STRIP LIGHT FIXTURE	SAME AS T-I, BUT ONE LAMP ON BATTERY BACK-UF	(3) 32W	4) USE RIGID STEEL SET SCREW TYPE FITTINGS ONLY. DIE CAST FITTINGS SHALL NOT BE USED.	DISCREPANCIES FOUND BETWEEN THE INTENDED FUNCTION OF EQUIPMENT AND EQUIPMENT SPECIFIED IN THE CONTRACT DOCUMENTS A MINIMUM OF TEN (10) WORKING DAYS PRIOR TO ISSUANCE OF THE FINAL BID. FAILURE TO REPORT	salt lake city utah 84121
	EXTERIOR WALL MOUNTED FIXTURE WITH REMOTE EMERGENCY BATTERY BACK-UP	LV 4 FLUODES CENT CUDE 4 CE MOUNT LIDADAD OUNT	T8 METALUX (2EP3GX SERIES EQUAL)EM LIGHTOLIER (DPA SERIES EQUAL)EM	(5) SUPPORT THE LAY-IN TYPE FIXTURES FROM THE CEILING DECK INDEPENDENT OF	ANY DISCREPANCY (CATALOG NUMBERS, DISCONTINUED ITEMS, ETC.) DOES NOT RELIEVE THE CONTRACTOR FROM PROVIDING EQUIPMENT WHICH SHALL	801. 278. 8151 fax 801. 278. 8661
	WALL MOUNTED FIXTURE	I X 4 FLUORESCENT SURFACE MOUNT WRAPAROUNI LENS LIGHT FIXTURE	COLUMBIA WC4-232-EB8LHI2O (2) 32W DAYBRITE (EQUAL)	THE CEILING GRID, AS SHOWN ON THE TYPICAL RECESSED FIXTURE MOUNTING DETAIL.	CONFORM TO AND FULFILL THE INTENT OF THE CONTRACT DOCUMENTS. NOR SHALL IT BE USED AS A CONDITION TO OBTAIN ADDITIONAL FUNDS FROM THE OWNER AFTER THE CONTRACT IS AWARDED. THE CONTRACTOR SHALL REQUEST	CREATED BY: JSA ARCHITECTS
	E, NL FIXTURE WITH EMERGENCY BATTERY BACK-UP AND NIGHT LIGHT EXTERIOR LIGHT FIXTURE WITH INTEGRAL MOTION SENSOR	FLUORESCENT 4-0" WALL MOUNTED VANITY LIGHT,	METALUX (EQUAL) COLUMBIA W4-232-EB8LHUNV	(6) REFER TO THE MECHANICAL SHEETS FOR THE EXACT LOCATION OF THE MECHANICAL EQUIPMENT.	ALL CLARIFICATIONS OF CONTRACT DOCUMENT REQUIREMENTS IN WRITING TO THE ARCHITECT/ENGINEER A MINIMUM OF TEN (IO) WORKING DAYS PRIOR TO ISSUANCE OF THE FINAL ADDENDUM.	THE DESIGNS SHOWN AND DESCRIBED HEREIN INCLUDING ALL TECHNICAL DRAWINGS, GRAPHIC
	EXIT LIGHT. ARROWS SHOW EXIT DIRECTION	UNIVERSAL VOLTAGE BALLAST, OPAL ACRYLIC LE THERMOPLASTIC END CAPS, STEEL HOUSING.	NS (2) 32W T8 METALUX (EQUAL)	7 ALL NEW WORK MUST MEET THE CURRENT ADOPTED NATIONAL ELECTRICAL CODE.	(40) PROVIDE MACHINE PRINTED ADHESIVE LABELS FOR ALL DUPLEX OUTLETS AND	REPRESENTATION & MODELS THEREOF, ARE PROPRIETARY & CAN NOT BE COPIED,
	\$ SINGLE POLE TOGGLE SWITCH - 20 AMP	UNIVERSAL VOLTAGE BALLAST. RECESSED FLUORESCENT DOWNLIGHT, WET	LIGHTOLIER (EQUAL) 13 W PRESCOLITE CBX-120-HPF-TL31	NOT MORE THAN THREE (3) CIRCUITS, SHALL BE INSTALLED IN A ANY CONDUIT. EACH CIRCUIT SHALL CONSIST OF I CONDUCTOR FOR EACH PHASE, I NEUTRAL,	LIGHT SWITCHES TO INDICATE WHICH CIRCUIT THEY ARE TIED TO. (4) INSTALL EXIT SIGNS ON THE WALL IF POSSIBLE.	DUPLICATED, OR COMMERCIALLY EXPLOITED IN WHOLE OR IN PART WITHOUT THE SOLE AND EXPRESS WRITTEN PERMISSION FROM THE STATE
	\$1,0 SINGLE POLE TOGGLE SWITCH - 20 AMP, LETTERS INDICATE SWITCH ASSIGNMENT \$3 THREE WAY TOGGLE SWITCH - 20 AMP	LOCATION APPROVED, 6" APERATURE, FLAT OPAL LEXAN LENS	QUAD HALO (EQUAL) TUBE C.F. LITHONIA (EQUAL)	AND I GROUND, FOR A TOTAL OF FIVE CONDUCTORS.	(4) CONTRACT DOCUMENTS SHALL TAKE PRECEDENCE OVER SHOP DRAWINGS	OF UTAH.
	\$P PILOT LIGHT TOGGLE SWITCH	4' FLUORESCENT STRIP LIGHT WITH WIRE GUARD	COLUMBIA CS4-232-EBHLHUNV-CSWG4	(9) THE SIZE OF THE NEUTRAL CONDUCTORS SHALL BE NO. 10 AWG FOR ALL HOME RUNS WITH COMMON NEUTRAL (LIGHTING AND POWER CIRCUITS).	UNLESS SPECIFICALLY NOTETHE D OTHERWISE. (43) SWITCHBOARDS, PANELBOARDS, AND MOTOR CONTROL CENTERS SHALL BE	THESE DRAWINGS ARE AVAILABLE FOR LIMITED REVIEW AND EVALUATION BY CLIENTS, CONSULTANTS, CONTRACTORS, GOVERNMENT
	CEILING MOUNTED OCCUPANCY SENSOR - U = ULTRASONIC, I = INFRARED, DT = DUAL TECH.	$\left \begin{array}{c} \left(T-5 \right) \right $	T8 METALUX (EQUAL) LIGHTOLIER (EQUAL)	(1) THE MINIMUM SIZE OF THE CONDUCTORS ARE TO BE #12 AWG THHN COPPER, UNLESS INDICATED OTHERWISE ON THE DRAWINGS.	FIELD MARKED TO WARN QUALIFIED PERSONS OF POTENTIAL ELECTRIC ARC FLASH HAZARDS. THE MARKING SHALL BE LOCATED SO AS TO BE CLEARLY	AGENCIES, VENDORS, AND OFFICE PERSONNEL ONLY IN ACCORDANCE WITH THIS NOTICE.
	WALL MOUNTED OCCUPANCY SENSOR - U = ULTRASONIC, I = INFRARED, DT = DUAL TECH.	SAME AS T-5 BUT WITH 90 MINUTE, 1100 LUMEN BATTERY PACK	(2) 32W	ALL PANELBOARDS SHALL HAVE FULL SIZE ISOLATED NEUTRAL AND GROUND COPPER BUSSBARS.	VISIBLE TO QUALIFIED PERSONS BEFORE EXAMINATION, ADJUSTMENT, SERVICING, OR MAINTENANCE OF THE EQUIPMENT. (NEC 110-16).	CONSULTANTS:
	30 MINUTE, SPRING WOUND, WALL MOUNTED TIMER SWITCH T-X, LIGHTING FIXTURE CALLOUT. NUMBER INDICATES A SUGGESTED QUANTITY- TO BE VERIFIED	1-5E	T8 METALUX (EQUAL) LIGHTOLIER (EQUAL)	(12) SUCCESSFUL BIDDER FOR THE PANELBOARDS, MAIN DISTRIBUTION PANEL, ETC.,	(4) PROVIDE ENGRAVED THERMOPLASTIC TAGS FOR ALL PANELBOARD AND EQUIPMENT DISCONNECTS. DISCONNECTS SHALL BE LABELED WITH EQUIPMENT	CONSCENTANTS.
	REFERENCE NOTE CALLOUT	EXTERIOR EMERGENCY WALL SCONCE, SMALL PROFILE, PAINT TO MATCH ADJACENT SURFACE. T-6 MOUNT REMOTE BALLAST IN INTERIOR OF BUILDING	GARDCO	SHALL INCLUDE IN THEIR SUBMITTALS, A LAYOUT OF THE ELECTRICAL ROOM TO SHOW THE ELECTRICAL GEAR FINAL LOCATIONS. (SCALE: 1/4" = 1'-0").	DESIGNATION AND CIRCUIT BREAKER THEY ARE TIED TO.	PROFESSION.
	POWER SYSTEMS SYMBOL LIST	ON WALL AT HEIGHT AND LOCATION TO BE DETERMINED BY ARCHITECT. 1100 LUMEN BATTER	TUBE C.F. HUBBELL TWSL-42TRF-9CBA-I2O-GPCF-849	(13) DETAILS ARE SHOWN ON DIFFERENT SHEETS. THE CONTRACTOR SHALL REFER TO THOSE DETAILS WHETHER OR NOT CALLED IN REFERENCE NOTES. (14) ALL J-BOXES SHALL HAVE MINIMUM DEPTH OF 2-1/8" UNLESS OTHERWISE SPECIFIED. SECURE ALL J-BOXES AS SHOWN IN THE DETAILS. FURNISH AND INSTALL PROPER MUD RINGS. (15) ALL METALLIC CONDUITS, JOINTS, FITTINGS, ETC., IN CONTACT WITH THE GROUND		NO. 354252-2202
	SYMBOL DESCRIPTION O DESCRIPTION	EXTERIOR WALL MOUNTED METAL HALIDE LIGHT FIXTURE. FULL CUTOFF, TRAPEZOIDAL STYLE.	HUBBELL TWSM-IOOMH-DL-BK-I2O (I) IOOW GARDCO (EQUAL)			DARRIN B. SANDERS
	DUPLEX CONVENIENCE OUTLET - 20 AMP DUPLEX CONVENIENCE OUTLET - 20 AMP GROUND FAULT INTERRUPTER	(1-1)	(I) IOOW GARDCO (EQUAL) MH VISIONAIRE (EQUAL)			OF UTAIL
	TWIST-LOCK RECEPTACLE	NOT USED		SHALL BE SPIRALLY WRAPPED WITH 3M SCOTCHRAP-51, 20 MIL TAPE (OR APPROVED EQUAL). 1/2" OVERLAP IS REQUIRED.		C
	4-PLEX CONVENIENCE OUTLET - 20 AMP	12'-O" LINEAR INDIRECT FIXTURE WITH PERFORATE		(16) ALL CONDUITS EXPOSED TO THE WEATHER SHALL BE GALVANIZED RIGID STEEL, UNLESS OTHERWISE NOTED.		
	SPECIAL PURPOSE SINGLE PHASE OUTLET POWER / COMMUNICATIONS POLE	SIDES, LOW PROFILE TYPE WITH CAST ALUMINUM EN CAPS, (2) T5HO LAMPS WIDE, TWO SWITCH LEG CIRCUITS, LENGTHS AND QUANTITIES AS SHOWN ON	T5HO LIGHTOLIER LSC-2-X-B-54-I-WH-DC	(17) ALL EXPOSED CONDUIT MUST RUN AGAINST THE WALLS OR CEILINGS. DO NOT		ECE, Inc. CONSULTING ENGINEERS
	JUNCTION BOX - SIZE AND FUNCTION AS REQUIRED	THE DRAWINGS, WHITE HOUSING, FULLY ADJUSTABL AIRCRAFT CABLE SUSPENSION, VERIFY LENGTH,	CORELITE IP-WP-2T5-2C-I2O-ACXX-XX-DC	PENDANT MOUNT ANY CONDUIT FROM THE CEILINGS. (18) ALL THE HOMERUNS MUST BE ACCESSIBLE IN THE CEILING PLENUM. DO NOT		939 S. WEST TEMPLE PHONE: 801.521.8007 SALT LAKE CITY, UTAH 84101 FAX: 801.521-8057
		CLEAR TOP DUST COVER, MATTE WHITE, CONTINUO RUN.		CARRY A HOMERUN FROM ONE DEVICE TO ANOTHER WHICH IS TIED TO A SEPARATE HOMERUN INSIDE THE WALL. MARK ON ALL THE J-BOXES THE CIRCUIT		BUILDING NAME:
	CONDUITS CONCEALED IN CEILING AND WALLS			NAMES AND NUMBERS. USE NO. 10 THHN CONDUCTORS FOR CONDUCTOR LENGTH OVER 100 FEET, NO. 8 THHN OVER 200 FEET, NO. 6 THHN OVER 300 FEET AND NO. 4 THHN OVER 400 FEET LENGTH.		UTAH NATIONAL
	ARROWS INDICATE HOME RUNS - LINES INDICATE NUMBER CONDUCTORS FUSED DISCONNECT SWITCH - SIZE AS REQUIRED			(19) PAINT ALL THE J-BOXES FOR FIRE ALARM SYSTEM WITH RED PAINT. MARK ALL THE CONDUIT FOR FIRE ALARM SYSTEM EVERY 8' WITH RED STRIPE.		GUARD
	COMBINATION STARTER/FUSED DISCONNECT SWITCH - SIZE AS REQUIRED	LED EXIT SIGN, WHITE WITH GREEN LETTERS, THERMOPLASTIC HOUSING, NICAD BATTERY BACK- UNIVERSAL MOUNT.	JP, INCLUDED SURELITES LXUGWE (EQUAL)	20 THE FIRST 10' LENGTH OF ALL BURIED CONDUIT OVER 1" SHALL BE RIGID		JLTC
	MOTOR LOCATION	Notes	LIGHTOLIER (EQUAL)	GALVANIZED STEEL WHERE THEY ARE LEAVING OR ENTERING THE BUILDING, MANHOLE, VAULT, ETC.		
	\$\text{T} MANUAL DISCONNECT WITH THERMAL OVERLOAD PROTECTION ELECTRICAL PANEL LOCATION		NIC PROGRAMMABLE START BALLAST'S, IO%, TOTAL HARMONIC DISTORTION. ED MANUFACTURERS. BALLAST'S TO HAVE 5 YEAR WARRANTY.	ALL UNDERGROUND CONDUIT SHALL BE BURIED 24" MINIMUM UNDER THE GROUND. PUT METALLIC YELLOW WARNING TAPE ABOVE ALL UNDERGROUND		PROJECT TITLE:
	ELECTRICAL METER LOCATION	2. ALL FLUORESCENT LAMPS SHALL HAVE COLOR T	EMPERATURE, AS SELECTED BY THE OWNER.	CONDUIT. ② COORDINATE WITH THE ARCHITECT FOR THE EXACT LOCATION OF THE OUTLETS.		BUILDING #4
	M.P. INDICATES WEATHER PROOF EQUIPMENT	3. FIELD VERIFY ALL LIGHTING VOLTAGES PRIOR		23 LIGHT SWITCHES INSTALLED ADJACENT TO EACH OTHER, SHALL BE GANGED TOGETHER WITH ONE PIECE COVERPLATE.		
-	A INDICATES DEVICE IS ABOVE COUNTER TOP	4. THE WRITTEN CRITERIA OF THE FIXTURE DESCRIF 5. ALL MRIG LAMPS SHALL HAVE BOTTOM LENS ANI	PTION TAKES PRECEDENCE OVER THE CATALOG NUMBER. D BE RATED AT 10,000 HOURS.	24) USE EPOXY ANCHORS TO SUPPORT THE ELECTRICAL EQUIPMENT. EXPANSION		CAMP WILLIAMS
	CLG INDICATES CEILGING MOUNTED DEVICE XX-I	6. THE FOLLOWING MANUFACTURERS ARE APPROVE	D ALTERNATES FOR THE LIGHTING FIXTURES, BASED ON INFORMATION	ANCHOR BOLTS ARE NOT ACCEPTED. ② ② ③ AT THE END OF THE JOB, PROVIDE BLANK COVER PLATES TO MATCH THE		D DRAPER, UT
	REFERENCE NOTE CALLOUT	T-I THOMAS, LITHONIA, LSI T-IE THOMAS (BODINE), LITHONIA, LSI (EELF	LE. ALTERNATES SHALL BE EQUAL TO THOSE SPECIFIED ABOVE:)	OTHER COVER PLATES FOR ALL J-BOXES WHERE DEVICES HAVE NOT YET BEEN INSTALLED.		MARK DATE DESCRIPTION
	FLUSH FLOOR OUTLET WITH COMMUNICATIONS OUTLET	T-2 THOMAS, LITHONIA, LSI T-3 THOMAS, LITHONIA, LSI T-4 OCEAN STATE LIGHTING, LITHONIA, INF		26 SEAL AROUND ALL CONDUIT PENETRATIONS THROUGH FIRE RATED WALLS AND CEILINGS WITH FIRE RATED MATERIAL. 3M IS AN APPROVED MANUFACTURER.		MARK DATE DESCRIPTION
	COMMUNICATION SYSTEMS SYMBOL LIST	T-5 THOMAS, LITHONIA, LSI T-6 LSI		② ALL DISCONNECTS, J-BOXES AND CONDUITS EXPOSED TO THE OUTSIDE WEATHER		
	SYMBOL DESCRIPTION TELEPHONE TERMINAL BOARD	T-7 LUMARK, LSI, PACE T-9 FINELITE, DAY-0-LITE EX-1 THOMAS, EELP, LITHONIA		SHALL BE NON-CORROSIVE, WEATHER PROOF TYPE. (28) ALL DISCONNECTS SHALL BE HEAVY DUTY TYPE.		
	FLUSH VOICE / DATA OUTLET	LA I HIVI MO, LLLI , LITRUNIA		29 ALL MATERIALS USED IN THIS INSTALLATION SHALL BE U.L. APPROVED AND NEW.		
	A INDICATES DEVICE IS ABOVE COUNTER TOP			30 ALL ELECTRICAL WIRING MUST BE IN CONDUIT (ROMEX AND MC CABLE ARE NOT PERMITTED).		ISSUE TYPE: CONSTRUCTION SET
	FIRE ALARM SYSTEM SYMBOL LIST			3) FLEXIBLE CONDUITS CAN ONLY BE USED FOR SHORT RUNS (6' MAXIMUM).		
	SYMBOL DESCRIPTION			32) NO CONDUITS SHALL RUN IN DUCT WORK.		ISSUE DATE: 5/18/06
	ELECTRICAL PANEL LOCATION			(33) TEMPORARY ELECTRICAL SERVICE IS TO BE PROVIDED BY THE ELECTRICAL CONTRACTOR AND REMOVED BY THE ELECTRICAL CONTRACTOR.		DFCM PROJECT NO: 06013480 ECE PROJECT NO: 3127
A _	SD FIRE ALARM PHOTOELECTRIC SMOKE DETECTOR SD FIRE ALARM PHOTOELECTRIC SMOKE DETECTOR			34) PRIOR TO SUBMITTING A BID THE ELECTRICAL CONTRACTOR SHALL INSPECT THE SITE AND INCLUDE IN HIS BID PACKAGE ALL CHARGES DUE TO EXISTING CONDITIONS SHOP PRAIJINGS ARE REQUIRED. ALL LARGE MATERIAL AND		CAD DWG FILE:
	FIRE ALARM PHOTOELECTRIC DUCT DETECTOR FIRE ALARM MANUAL PULL STATION			CONDITIONS. SHOP DRAWINGS ARE REQUIRED. ALL LABOR, MATERIAL AND WORKMANSHIP SHALL BE GUARANTEED FOR A PERIOD OF I YEAR FROM THE DATE OF ACCEPTANCE BY THE TENANT. REPLACE OR REPAIR ALL DEFECTS		DRAWN BY: DBS CHK'D BY: DBS
	H): FIRE ALARM HORN WITH STROBE HIGH DECIBEL			DURING THE GUARANTEED PERIOD.		COPYRIGHT: STATE OF UTAH
	H FIRE ALARM HORN HIGH DECIBEL			(35) THE ELECTRICAL CONTRACTOR SHALL TERMINATE THE ELECTRICAL CONNECTIONS TO ALL THE EQUIPMENT BY PROVIDING THE NECESSARY MALE/FEMALE CONNECTOR, RECEPTACLE, PLUG, ETC.		SHEET TITLE
	A.D.A. STROBE FOR FIRE ALARM FS FIRE SPRINKLER FLOW SWITCH			36 ALL DUPLEX OUTLETS AND SWITCHES SHALL BE 20 AMP., 120 VOLT SPEC GRADE. HUBBELL AND PASS & SEYMOUR AND LEVITON ARE APPROVED		GEN NOTES, DTLS, A & SCHEDULES
	FS FIRE SPRINKLER FLOW SWITCH TS FIRE SPRINKLER TEMPER SWITCH			MANUFACTURERS.		
	FSD FIRE/9MOKE DAMPER			(3) THE ELECTRICAL CONTRACTOR SHALL NOTIFY AND COORDINATE WITH THE MECHANICAL CONTRACTOR SO THAT NO PIPING, DUCTS, OR OTHER EQUIPMENT SHALL BE INSTALLED IN ENTRY OR PASS THROUGH ELECTRICAL ROOM OR SPACES ABOVE OR BELOW ELECTRICAL PANELS.		SHEET NUMBER
	RM FIRE ALARM RELAY					STILLI NUMBER
	F.A.C.P. FIRE ALARM CONTROL PANEL F.A.R.A.P. FIRE ALARM REMOTE ANNUNCIATOR PANEL					E-0 01
	REFERENCE NOTE CALLOUT					
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